

# RIVERBANKS ZOO & GARDEN

Procurement Services  
400 Rivermont Drive, Columbia, SC 29210  
Phone: 803-602-0831 Fax: 803-771-8722

## INVITATION FOR BIDS- HAY BARN

BID NUMBER: **B2022-06-12**

DATE: **06/24/2022**

OPENING DATE AND TIME: **August 8, 2022, 10:00 AM EST**

OPENING LOCATION: Riverbanks Zoo & Garden  
Procurement Services  
400 Rivermont Drive  
Columbia, SC 29210

MAILING ADDRESS: Riverbanks Zoo & Garden  
Attn: Raymond Brindle  
400 Rivermont Drive  
Columbia, SC 29210

PROCUREMENT FOR: **Hay Barn**

**Subject to the conditions, provisions and the enclosed specifications, sealed bids will be received at this office until the stated date and time and then publicly opened. Any bid received after the scheduled deadline will be immediately disqualified. The District assumes no responsibility for delivery of bids which are mailed. Oral, telephonic, electronic or telegraphic bids are invalid and will not receive consideration.**

**IT IS REQUIRED THAT THE BID NUMBER BE SHOWN ON THE OUTSIDE OF ENVELOPE.**

**DIRECT ALL INQUIRES TO: Raymond Brindle, Procurement Manager, 803-360-0841,  
[rbrindle@riverbanks.org](mailto:rbrindle@riverbanks.org)**

## KEY EVENTS / DATES

- |                                 |                                 |
|---------------------------------|---------------------------------|
| 1. Advertisement / Posting Date | June 24, 2022                   |
| 2. Mandatory Site Visit         | July 6, 2022, 10:30 AM (EST.)   |
| 3. Deadline for Questions       | July 11, 2022, 5:00 PM (EST.)   |
| 4. Bid Due                      | August 8, 2022, 10:00 AM (EST.) |

**NOTICE TO BIDDERS: There will be a Mandatory Site Visit on June 6, 2021, at 10:30 AM (EST.) at Riverbanks Zoo & Garden, 500 Wildlife Parkway, Columbia, SC 29210. Meet at the reception gate. Once you cross the railroad tracks, make a right and the reception gate will be on your left.** Due to the importance of all bidders having a clear understanding of the scope and requirements for this project, *attendance at this meeting will be mandatory.* Any changes that may be agreed upon as a result of this conference will be noted in an amendment to the bid invitation and posted on the Riverbanks Zoo and Garden procurement page. Each bidder shall fully acquaint himself with conditions relating to the scope and restrictions attending the execution of the work under the conditions of this bid. The failure or omission of a bidder to acquaint himself with existing conditions shall in no way relieve him of any obligation with respect to this bid or to the contract. All amendments to and interpretations of this solicitation shall be in writing and issued by the Procurement Manager. Richland-Lexington Riverbanks Park District DBA Riverbanks Zoo & Garden (hereinafter known as "the District") shall not be legally bound by any amendment or interpretation that is not in writing.

*If downloading this solicitation from our website or alternate internet location, it is the responsibility of the bidder to email [rbrindle@riverbanks.org](mailto:rbrindle@riverbanks.org) to be registered as a potential bidder and to receive any subsequent amendments. Deadline for questions is July 11, 2022, by 5:00 PM (EST.) All questions must be submitted in writing.*

<b>"NO BID" RESPONSE FORM</b>
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To submit a "No Bid" response for this project, this form must be completed for your company to remain on our bidders list for commodities/services referenced.

**Note:** Please show the solicitation number on the outside of the envelope.

Please check statement(s) applicable to your "No Bid" response --

Specifications are restrictive, i.e. geared toward one brand or manufacturer only (explain below).

Specifications are ambiguous (explain below).

We are unable to meet specifications.

Insufficient time to respond to the solicitation.

Our schedule would not permit us to perform.

We are unable to meet bond requirements.

We are unable to meet insurance requirements.

We do not offer this product or service.

Remove us from your vendor list for this commodity/service.

Other (specify below).

*Comments:*

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\_\_\_\_\_  
Company Name (as registered with the IRS)

\_\_\_\_\_  
Authorized Signature

\_\_\_\_\_  
Correspondence Address

\_\_\_\_\_  
Printed Name

\_\_\_\_\_  
City, State, Zip

\_\_\_\_\_  
Title

\_\_\_\_\_  
E-mail Address (Please Print)

\_\_\_\_\_  
Date

\_\_\_\_\_/\_\_\_\_\_  
Telephone Fax

**INSTRUCTIONS TO BIDDERS**

1. Only one copy of bid invitation is required, unless otherwise stated.
2. Bids, amendments thereto or withdrawal request must be received by the time advertised for bid openings to be timely filed. It is the vendor's sole responsibility to ensure that these documents are received by the Procurement Office at or before the time indicated in the bid document.
3. When specifications or descriptive papers are submitted with the bid invitation, enter bidder's name thereon.
4. Submit your signed bid on the forms provided. Show bid number on envelope as instructed. The District assumes no responsibility for unmarked or improperly marked envelopes. Unsigned bids will be rejected.
5. Bidders must clearly mark as "Confidential" each part of their bid which they consider to be proprietary information that could be exempt from disclosure under Section 30-4-4C Code of Laws of South Carolina, 1976, (1986 Cum Supp) Freedom of Information Act. The District reserves the right to determine whether this information should be exempt from disclosure and no legal action may be brought against the District or its agents for its determination in this regard.
6. By submission of a bid, you are guaranteeing that all goods and services meet the requirements of the solicitation during the contract period.
7. This solicitation does not commit the District to award a contract, to pay any cost incurred in the preparation of the bid, or to procure or contract for goods or services listed herein.
8. CORRECTION OF ERRORS ON THE BID FORM: All prices and notations shall be printed in ink or typewritten. Errors should be crossed out, corrections entered and initialed by the person signing the bid. Erasures or use of typewriter correction fluid may be cause for rejection. No bid shall be altered or amended after specified time for opening.
9. BIDDERS SCHEDULE: Enter the manufacturer, brand, and model/catalog number, as applicable, and your bid price in the space provided on the bidder's schedule. Additional pages may be attached, when applicable, for alternates, etc.
10. NOTIFICATION: Intent to Award and/or Statement of Award will be posted on the Riverbanks Zoo & Garden website at <http://www.riverbanks.org/procurement>
11. RIGHT TO PROTEST: (does not apply to procurements \$1-\$50,000) Any prospective bidder, offeror, or contractor, who is aggrieved in connection with the solicitation of a contract shall protest in writing to the Procurement Manager within ten (10) calendar days of the date of issuance of the Invitation to Bid, Requests for Proposals or other solicitation documents, whichever is applicable, or any amendments thereto, if the amendment is at issue. Any actual bidder, offeror, or contractor, who is aggrieved in connection with the intended award or award of a contract, shall protest in writing to the Procurement Manager within ten (10) calendar days of the notification of Intent to Award or Statement of Award.
12. PROTEST PROCEDURE: A protest shall be in writing, submitted to the Procurement Manager, and shall set forth the specific grounds of the protest with enough particularity to give notice of the issues to be decided.
13. QUESTIONS REGARDING SPECIFICATIONS AND/OR THE BIDDING PROCESS:
  - To ensure fair consideration for all bidders the District prohibits any type of communications to or with any department, employee, or District official during the

solicitation process, except as provided on page one of the solicitation. This includes any communications initiated by a bidder to any District Official or employee evaluating or considering the bidder, prior to the time an award decision has been made public. **Failure to comply shall be grounds for disqualification of the offending bidder from consideration for award of the bid and/or any future solicitations.**

- Any communications between the bidder and the District shall be initiated by the Procurement Office or the appropriate District representative in order to obtain necessary information or clarification needed to develop a proper and accurate evaluation of the bid. **Failure to comply shall be grounds for disqualification of the offending bidder from consideration for award of the bid and/or any future solicitations.**
- It will be the sole responsibility of the bidder to contact the Procurement Office prior to submitting a bid to ascertain if any amendments have been issued in order to obtain all such documentation, and to return the executed documentation with their bid. All amendments will be posted on the Riverbanks Zoo & Garden website at: <http://www.riverbanks.org/procurement>

### **GENERAL PROVISIONS**

1. The District reserves the right to reject any and all bids, to cancel a solicitation, and to waive any technicality if deemed to be in the best interest of the District.
2. Unit prices will govern over extended prices unless otherwise stated in this bid invitation.
3. PROHIBITION OF GRATUITIES: Amended section 8-13-700 and 705 of the 1976 Code of Laws of South Carolina states: "Whoever gives or offers to any public official or public employee any compensation including a promise of future employment to influence his action, vote, opinion or judgment as a public official or public employee or such public official solicits or accepts such compensation to influence his action, vote, opinion or judgment shall be subject to the punishment as provided by Section 16-9- 210 and Section 16-9-220."
4. BIDDERS QUALIFICATIONS: Consideration will be given only to the contractors who can produce conclusive evidence that they can meet the following requirements:
  - 4.1 Adequate capital and credit rating sufficient to complete all operations under this contract in a satisfactory manner.
  - 4.2 An efficient office force with satisfactory record in expediting delivery of materials to field force, and capable of fulfilling proper liaison service with mechanical trade.
  - 4.3 An adequate and efficient field force with extensive knowledge of all types of work involved under this contract.
  - 4.4 A record of amicable relations with labor.
  - 4.5 An adequate supply of applicable equipment in good operating condition to fulfill the contract.
5. LICENSES, PERMITS, INSURANCE, & TAXES: All costs for required licenses, permits, insurances and taxes shall be borne by the Contractor.
6. INSURANCE:
  - 6.1 The amount and types of insurance required should be reasonably commensurate with the hazards and magnitude of the undertaking, but in no event of lesser amount nor more restrictive than the limits of liability and schedule of hazards below described. Without limiting its liability under the contract agreement, the Contractor shall procure and maintain, at its expense during the life of this contract, insurance of the types in the minimum amounts stated below:



**SCHEDULE**

**WORKERS COMPENSATION**

As required by the State of South Carolina.

**COMPREHENSIVE GENERAL LIABILITY**

Premises Operations

Contractual Liability

Independent Contractors

Personal Injury

Products - Completed Operations

**AUTOMOBILE LIABILITY**

All Owned, Non-Owned, and Hired

**LIMIT**

Statutory

\$1,000,000 Single Limit

\$ 100,000 Combined

- 6.2 The Contractor's comprehensive general liability policy shall also include blanket contractual liability coverage or shall be endorsed to cover the liability assumed by the Contractor. Said insurance shall be written by a company or companies approved to do business in the State of South Carolina and acceptable to the District. Before commencing any work hereunder, certificates evidencing the maintenance of said insurance shall be furnished to the District. The District, its officials, employees and volunteers are to be covered as insured's as respects: liability arising out of activities performed by or on behalf of the contractor, including the insured's general supervision of the contract; products and completed operations of the contractor; premises owned, occupied or used by the Contractor; or automobiles owned, leased, hired or borrowed by the contractor. The coverage shall contain no special limitations on the scope of protection afforded the District, its officials, employees or volunteers. To accomplish this objective, the District shall be named as an additional insured under the Contractor's insurance as outlined above.
- 6.3 The contractor shall take out and maintain, during the life of this contract, the statutory Workmen's Compensation and Employer's Liability Insurance for all of his employees to be engaged in work on the project under this contract, and in case any such work is sublet, the contractor shall require the subcontractor similarly to provide Workmen's Compensation and Employer's Liability Insurance for all of the latter's employees to be engaged in such work.
- 6.4 Contractors insurance coverage shall be primary insurance as respects the District, it's officials, employees and volunteers. Any insurance or self-insurance maintained the District shall be in excess of the Contractor's insurance and shall not be required to contribute. To accomplish this objective, the following wording should be incorporated in the previously referenced additional insured endorsement:  
  
*Other Insurance:* This insurance is primary, and our obligations are not affected by any other insurance carried by the additional insured whether primary, excess, contingent or on an other basis.
- 6.5 Each insurance required by the District shall be endorsed to state that coverage shall not be suspended, voided, canceled by either party, reduced in coverage or in limits except after thirty (30) days prior written notice by certified mail, return receipt requested, has been given to Riverbanks Zoo & Garden Procurement Office.
- 6.6 Contractor shall include all subcontractors as insured under its policies or shall furnish separate certificates and endorsements for each subcontractor. All coverage's for subcontractors shall be subject to all the requirements stated herein.
- 6.7 All certificates and endorsements must be received and approved by the District within ten (10) days after notification of award.

- 6.8 The District, its officers and employees shall be named as an “additional insured” in the Automobile and General Liability policies, and it shall be stated on the Insurance Certificate with the provision that this coverage “is primary to all other coverage the District may possess”.
7. **BIDDERS RESPONSIBILITY:** Each bidder shall fully acquaint himself with conditions relating to the scope and restrictions attending the execution of the work under the conditions of this bid. It is expected that this will sometimes require on-site observation. The failure or omission of a bidder to acquaint himself with existing conditions shall in no way relieve him of any obligation with respect to this bid or to the contract.
8. **AWARD CRITERIA:** The contract shall be awarded to the lowest responsible and responsive bidder(s) whose bid meets the requirements and criteria set forth in the Invitation for Bid. The award can be made to one or a multiple of contractors; whichever is in the best interest of the District, or unless otherwise stated on bidders’ schedule.

If two or more bidders are tied in price while otherwise meeting all of the required conditions, awards are determined in the following order of priority:

  - 8.1 If there is a South Carolina firm tied with an out-of-state firm, the award must be made automatically to the South Carolina firm.
  - 8.2 Tie bids involving South Carolina produced or manufactured products, when known, and items produced or manufactured out of the State must be resolved in favor of the South Carolina commodity.
  - 8.3 Tie bids involving a business certified by the South Carolina Office of Small and Minority Business Assistance as a Minority Business Enterprise must be resolved in favor of the Minority Business Enterprise.
  - 8.4 Tie bids involving South Carolina firms must be resolved in favor of the South Carolina firm located closest to the District.
  - 8.5 In all other situations in which bids are tied, the award must be made to the tied bidder offering the quickest delivery time, or if the tied bidders have offered the same delivery time, the tie must be resolved by the flip of a coin witnessed by the Procurement Manager. All responding vendors must be invited to attend.
9. **WAIVER:** The District reserves the right to waive any Instruction to Bidders, General or Special Provisions, General or Special Conditions, or specifications deviation if deemed to be in the best interest of the District.
10. **COMPETITION:** This solicitation is intended to promote competition. If any language, specifications, terms and conditions, or any combination thereof restricts or limits the requirements in this solicitation to a single source, it shall be the responsibility of the interested contractor to notify the Procurement Services Office in writing within five (5) days prior to the opening date. The solicitation may or may not be changed but a review of such notification will be made prior to the award.
11. **REJECTION:** The District reserves the right to reject any bid that contains prices for individual items or services that are inconsistent or unrealistic when compared to other prices in the same or other bids or ambiguous bids which are uncertain as to terms, delivery, quantity, or compliance with specifications may be rejected or otherwise disregarded if such action is in the best interest of the District.

**GENERAL CONDITIONS**

1. **DEFAULT:** In case of default by the contractor, the District reserves the right to purchase any or all items in default in the open market, charging the contractor with any excessive costs. Should such charge be assessed, no subsequent bids will be considered, or purchase orders issued to the defaulting contractor until the assessed charge has been satisfied.
2. **NON-APPROPRIATION:** Any contract entered into by the District resulting from this bid invitation shall be subject to cancellation without damages or further obligation when funds are not appropriated or otherwise made available to support continuation of performance in a subsequent fiscal period or appropriated year.
3. **INDEMNIFICATION:** The contractor agrees to indemnify and save harmless the District and all District officers, agents and employees from claims, suits, actions, damages and costs of every name and description, arising out of or resulting from the use of any materials furnished by the Contractor, provided that such liability is not attributable to negligence on the part of the District or failure of the District to use the materials in the manner outlined by the Contractor in descriptive literature or specifications submitted with the Contractor's bid.
4. **CONTRACT ADMINISTRATION:** Questions or problems arising after award of this contract shall be directed to the Procurement Manager. Copies of all correspondence concerning this contract shall be sent to, 400 Rivermont Drive, Columbia, SC 29210. All change orders must be authorized in writing by the Procurement Manager. The District shall not be bound to any change in the original contract unless approved in writing by the Procurement Manager.
5. **PUBLICITY RELEASES:** Contractor agrees not to refer to award of this contract in commercial advertising in such a manner as to state or imply that the products or services provided are endorsed or preferred by the User. The contractor shall not have the right to include the District's name in its published list of customers without prior approval. With regard to news releases, only the name of the project and duration of contract may be used and then only with prior approval of the District. The contractor also agrees not to publish, or cite in any form, any comments or quotes from the Riverbanks Zoo & Garden Staff unless it is a direct quote from the Public Relations Officer.
6. **QUALITY OF PRODUCT:** Unless otherwise indicated in this bid it is understood and agreed that any items offered or shipped on this bid shall be new and in first class condition unless otherwise indicated herein.
7. **S.C. LAW CLAUSE:** Upon award of a contract under this bid, the person, partnership, association or corporation to whom the award is made must comply with the laws of South Carolina which require such person or entity to be authorized and/or licensed to do business with this State. Notwithstanding the fact that applicable statutes may exempt or exclude the successful bidder from requirements that it be authorized and/or licensed to do business in this State, by submission of this signed bid, the bidder agrees to subject himself to the jurisdiction and process of the courts of the State of South Carolina as to all matters and disputes arising or to arise under the contract and the performance thereof, including any questions as to the liability for taxes, licenses, or fees levied by the State.
8. **ASSIGNMENT:** No contract or its provisions may be assigned, sublet, or transferred without the written consent/Acknowledgement of the Procurement Manager.
9. **AFFIRMATIVE ACTION:** The successful bidder will take affirmative action in complying with all Federal and State requirements concerning fair employment and treatment of all employees, without regard or discrimination by reason of race, color, religion, sex, national origin or physical handicap.

10. **BIDDING CONDITION OF PRICE:** All bid prices submitted shall remain effective for a minimum period of 90 days, or until evaluation of bids is complete and award is made unless mutual consent of parties is established to extend due to unforeseen circumstances. Thereafter, the contract prices shall remain effective for the term of the contract.
11. **8% S.C. SALES TAX:** The District shall add 8% sales tax to all orders; however lump sum bids shall include sales tax in bid price unless otherwise noted. **By submission of a signed proposal, you are certifying, under penalties of perjury that you comply with the SC Code of Laws 1976, as amended, relating to payment of any applicable taxes. This will certify to the District your compliance.**

Forms to register for all taxes administered by the South Carolina Department of Revenue may be obtained by calling the License and Registration Section at (803) 898-5872 or by writing to the South Carolina Department of Revenue, Registration Unit, Columbia, South Carolina 29214-0140.

12. **PAYMENT TERMS:** Payment will be made within thirty (30) days after acceptance of completed order/project. Early payment discount, if available, will be calculated from date of acceptance. Application for payment shall reflect services completed through the last day of the month. **There will be no exceptions to these payment terms unless approval is obtained in writing from the Procurement Manager prior to bid opening date.**
13. **BID REQUIREMENTS:** Bid requirements on the equipment/goods/services specified are not intended to be restrictive to potential bidders but indicate the required features for satisfactory performance. The District will determine if minor deviations from these features are acceptable.
14. **DEVIATIONS FROM SPECIFICATIONS:** Any deviation from specifications indicated herein must be clearly pointed out; otherwise, it will be considered that items offered are in strict compliance with these specifications, and successful bidder will be held responsible, therefore. Deviations must be explained in detail on separate attached sheet(s). The listing of deviations, if any, is required but will not be construed as waiving any requirements of the specifications. Deviations found in the evaluation of the bid and not listed may be cause for rejection. Bidders offering substitute or equal items must provide information sufficient enough to determine acceptability of item offered.
15. **CONTRACT:** This bid, contract and submitted documents, when properly accepted by the District along with a written purchase order, shall constitute a contract equally binding between the successful offeror, and the District. No different or additional terms will become a part of this contract with the exception of a Change Order.
16. **CHANGE ORDERS:** No oral statement of any person shall modify or otherwise change, or affect the terms, conditions or specifications stated in the resulting contract. All change orders to the contract will be made in writing by the Procurement Manager.
17. **AMENDMENTS:** All amendments to and interpretations of this solicitation shall be in writing and issued by the Procurement Manager. The District shall not be legally bound by any Amendment or interpretation that is not in writing.
18. **BID EVALUATION:** Bids received will be evaluated by the Procurement Manager. However, based on bid total, final decision for bid award may rest with the Richland-Lexington Riverbanks Park Commission. Factors to be considered during the evaluation process include, but are not limited to:
  - 18.1 - Cost.
  - 18.2 - Reputation and dependability of the contractor
  - 18.3 – Past performance

19. ARBITRATION: Under no circumstances and with no exception will the District act as arbitrator between the Contractor.
20. SHIPPING: All deliveries shall be shipped F.O.B. point Destination-freight prepaid; the seller pays and bears all freight charges; collect shipments will not be accepted. It is agreed by the parties hereto that delivery by the contractor to the common carrier does not constitute delivery to the District. Any claim for loss or damage shall be between the contractor and the carrier.
21. "OR APPROVED EQUAL": Certain processes, types of equipment or kinds of material are described in the specifications and/or on the drawings by means of trade/brand names and catalog numbers. In each instance where this occurs, it is understood and inferred that such description is followed by the words "or approved equal". Such method of description is intended merely as a means of establishing a standard of comparability. However, the Owner reserves the right to select the items, which, in the judgment of the Owner, are best suited to the needs of the Owner, based on price, quality, service, availability, standardization and other relative factors. Bidders should indicate brand name, model, model number, size, type, weight, color, etc., of the item bid, if not exactly the same as the item specified. Vendor's stock number or catalog number is not sufficient to meet this requirement. If any bidder desires to furnish an item different from the specifications, vendor should submit along with the bid, the information, data, pictures, designs, cuts, etc., of the material they plan to furnish to enable the Owner to compare the material specified; and such material shall be given due consideration. The Owner reserves the right to insist upon and receive items as specified if the submitted items do not meet the Owner's standards for acceptance.
22. ALTERNATE BIDS: Bidders wishing to submit an alternate for consideration that does not meet the District's specifications (or approved deviations), must submit their proposal as an alternate bid. **This must be properly marked on both the sealed envelope and the Bidder's Schedule and submitted separately from any other bid. Failure to comply shall be grounds for being deemed non-responsive.**
23. DRUG-FREE WORKPLACE: By submittal of this bid, you are certifying that you will comply with Title 44, Code of Laws of South Carolina, 1976, Section 44-107-30.
24. ILLEGAL IMMIGRATION & PUBLIC CONTRACTS: In accordance with the South Carolina Illegal Immigration Reform Act, [2008, Act No. 280](#). Section 3 of this Act added to [Chapter 14 to Title 8](#) of the South Carolina Code of Laws prohibits covered persons from entering into covered contracts unless the contractor agrees either (a) to verify all new employees through the federal work authorization program [and requires the same from subcontractors and sub-subcontractors] or (b) to employ only qualifying workers. Effectively, the Act also requires contractors to agree to provide any documentation required to establish either (a) that the Act does or does not apply to the contractor, subcontractor, or sub-subcontractor; or (b) that the contractor, and any subcontractor or sub-subcontractor, are in compliance with Section 3 of the Act."
25. NO CONTACT POLICY: After the date and time established for receipt of proposals by the District, any contact initiated by any offeror with any District representative, other than the Purchasing Department representative listed herein, concerning this solicitation is prohibited. Any such unauthorized contact may cause the disqualification of the offeror from this procurement transaction.
26. TERMINATION: Subject to the provisions below, the contract may be terminated for any reason by the District providing a 30-day advance notice in writing is given to the contractor.
  - 26.1 Termination for Cause: Termination by the District for cause, default or negligence on the part of the contractor shall be excluded from the foregoing provisions, termination costs, if any, shall not apply. The thirty (30) days advance written notice requirement is waived and the default provision in this bid shall apply; see General Conditions.

- 26.2 Termination for Convenience: The District, by written notice, may terminate this contract in whole or in part, when it is in the best interest of the District.
- 26.3 Termination requirement does not apply if contract is to terminate at the end of an established contract term.
- 26.4 Termination for Non appropriations: If the District fails to appropriate or authorize the expenditure of sufficient funds to provide the continuation of this contract, or if a lawful order issued in or for any fiscal year during the term of the contract reduces the funds appropriated or authorized in such amount as to preclude making the payments set out therein, the contract shall terminate on the date said funds are no longer available without any termination charges or other liability incurring to the District. Any termination for non-appropriations shall not prohibit the District from obtaining services from another source or in another manner, which is in the best interest of the District.

## **SCOPE OF WORK**

### **INTENT:**

Riverbanks Zoo and Garden is seeking a contractor to demolish and build a new hay barn attached to the existing Giraffe Barn on the existing footprint and will be conducted in two (2) phases.

Phase One- To accomplish this, a doorway must be closed with Concrete Masonry Unit (CMU), a heavy-duty metal door installed on the upper landing level and a new set of stairs and landings leading to the giraffe upper level must first be built so that Giraffe operations continue without interruption. See Exhibit A for Drawings and Speciation's.

Phase Two- Once the stairs and landings are complete, the demo phase for the existing barn can begin. The current mostly wooden barn will be replaced with a concrete and CMU barn with metal roof. During demo and construction, the utilities supplying the Giraffe barn and surrounding area must be protected and remain active. Some water lines will need to be moved and reinstalled same day to support the giraffe operation. See Exhibit B for Drawings and Speciation's.

### **REQUIREMENTS:**

- Work hours are Monday through Friday 7am till 5pm with some exceptions permittable. Work which requires being in the Giraffe barn will be more restricted if Giraffes cannot be on exhibit and must remain in the barn. Those hours are Monday through Friday 8:30am till 4:30pm to allow for giraffe routine to be consistent.
- Demo methods should be planned so that loud and sudden noises are prevented. Any equipment that generates loud noise through its operation must be preapproved. If the noise is from an issue with the machine it will need to be replaced or repaired.
- Material availability should be verified to prevent delays during construction as cooler weather could impact the work schedule.
- Contractor must have a single point of contact on site at all times work is being performed.
- Bidders shall refrain from direct or indirect communications promoting their qualifications for this Project to the District or any member of the Lexington-Richland Riverbanks Park Commission, other than through the formal submittal process established by this Invitation for Bid (IFB). Failure to comply with submittal requirements may cause the submittal to be removed from further consideration.

- Contractor to submit documents and secure permit for entire project.
- The selected contractor must hold the required license(s) for demolition and construction of the hay barn.
- Contractor must be bondable, a certified contractor and have personnel on site who hold the necessary OSHA required certifications to safely perform the work.
- Must have an Experience Modifier Rate (EMR) of less than one (1).
- The contractor should submit as a part of the bid package the safety program to be used on this site to ensure workplace safety.
- Contractor's site superintendent shall coordinate all activities with Zoo Project Manager.
- All deliveries must be made before 7:00 AM or after 7:00 PM est.
- Riverbanks Zoo and Garden is a smoke free facility.

**CONSIDERATIONS:**

- The area around the hay barn is open to Riverbanks employees so deliveries, work practices, application processes and behavior of staff will be closely monitored by the Project Manager to ensure the quality of the staff environment.
- Jobsite is in a non-public area with direct access to the back service road. Work vehicles carrying tools and supplies will be allowed to park at site. Active workers only will be allowed inside perimeter fence, no family or pets are allowed within the perimeter fence.

**OBLIGATION:**

- Riverbanks Zoo and Garden makes no guarantees as to the correctness of the information and materials identified in this specification. It shall be the contractor's responsibility to ascertain the full extent of this job.

**REGULATIONS AND STANDARDS:**

- The work shall comply with all laws, ordinances and regulations of all legally constituted authorities having jurisdiction over any part of this work, County and State level. These requirements supplement the specifications and shall take precedence in case of conflict.
- All work shall be performed and completed in a thoroughly workmanlike and professional manner in accordance with best modern practices, regardless of any omissions from the attached specifications and/or drawings. All material and equipment shall be new and shall comply with the applicable standard in every case where such a standard has been established for the particular type of material in question.
- Safety Department to review fall protection plans specific to this project as requested. The Zoo Project Manager to final approve all aspects of the project including changes and payments.
- The Bidder shall supply for review, all SCOSHA written programs as applicable to include, but not limited to, the following OSHA standards; Walking-Working Surfaces (Fall Protection), Control of Hazardous Energy (Lockout/Tagout), Personal Protective Equipment and Permit-required Confined Spaces.



**SITE CLEAN UP:**

- The contractor shall keep the job site clean and free from an accumulation of debris or materials during the project. At the completion of the work, the entire facility and premises shall be left clean.
- The contractor shall remove from the premises all accumulations of trash and other materials, which are not to be used in the project, daily.

**CONTRACTOR'S CARE:**

- Contractor shall exercise due care in protecting all trees, property, and surrounding property. Contractor will be responsible for any damage and will be required to restore any damage. If the Contractor fails or refuses to repair any damage promptly, the Project Manager may have the necessary work performed and charge the cost thereof to the contractor.

**FINAL INSPECTION:**

- At the completion of the contract work, a representative of Riverbanks Zoo and Garden shall accompany the contractor on an inspection of the work. All defects found in the work will be corrected before final payment will be authorized.

**BIDS MUST INCLUDE**

- Solicitation name and number clearly marked on the outside of the envelope
- One hard copy and one digital (i.e. thumb drive)
- A schedule showing phases and duration
- A written introduction summarizing your company's background, resources and relevant experience.
- Three examples of past or current projects of similar size and scope, and the timelines under which they were completed
- Three references from past projects
- MBE/DBE/WBE Cultivation Plan- The owner is committed to cultivating MBE/DBE/WBE involvement in all aspects of owner's operations. Explain how your firm will cultivate MBE/DBE/WBE participation in the Greenhouse.
- A single point of contact – name, title, phone and email address must be included.

**HOURS OF OPERATION:**

Riverbanks Zoo and Garden is open Monday through Sunday from 9:00 am to 5:00 pm and closed on Thanksgiving and Christmas Days.

**DISPOSAL OF WASTE:**

- The Contractor will ensure proper handling and disposal of materials removed from the containers to prevent discharges of pollutants to surface waters or groundwater.

**NATIONAL POLLUTION DISCHARGE ELIMINATION SYSTEM (NPDES)  
REQUIREMENT:**

- Contractor shall comply with current and future requirements of the City of Columbia, City of West Columbia and State of South Carolina's NPDES permits (if any) as it may be amended from time to time.



**Procurement Services**  
 400 Rivermont Drive, Columbia, SC 29210  
 Phone: 803-602-0831 Fax: 803-771-8722

## BIDDERS SCHEDULE

**BID NUMBER: B2022-06-12**

**DATE: 06/24/2022**

**OPENING DATE AND TIME: August 8, 2022, 10:00 AM (EST)**

**OPENING LOCATION:** Riverbanks Zoo & Garden  
 Procurement Services  
 400 Rivermont Drive  
 Columbia, SC 29210

**PROCUREMENT:** Under a fixed price contract provide all materials, equipment, and labor for the demolition and construction of a new hay barn in accordance with the specifications, conditions, and provisions as applicable to this solicitation. All prices are to include all applicable transportation, recycle and disposal costs. **Submit one (1) hard copy and one (1) digital copy.**

**Delivery Requirements:** All deliveries shall be shipped F.O.B. point Destination-freight prepaid; the seller pays and bears all freight charges; collect shipments will not be accepted. It is agreed by the parties hereto that delivery by the contractor to the common carrier does not constitute delivery to the District. Any claim for loss or damage shall be between the contractor and the carrier.

ITEM NUMBER	QTY U/I	DESCRIPTION MFG/MDL/STK #	PRICE
#1:	EA	Demolition and Construction of Hay Barn	

**Total Price Written:** \_\_\_\_\_

**COMPANY:** \_\_\_\_\_

**AUTHORIZED SIGNATURE:** \_\_\_\_\_

The attached Certificate of Familiarity must be returned with bid.
--

**SOLICITATION NUMBER: B2022-06-12****DATE: June 24, 2022**

<b>CERTIFICATE OF FAMILIARITY</b>
-----------------------------------

The undersigned, having fully familiarized himself with the information contained within this entire solicitation and applicable amendments, submits the attached bid and other applicable information to the District, which I verify to be true and correct to the best of my knowledge. I certify that this bid is made without prior understanding, agreement, or connection with any corporation, firm or person submitting a bid for the same materials, supplies or equipment, and is in all respects, fair and without collusion or fraud. I agree to abide by all conditions of this bid and certify that I am authorized to sign this bid. I further certify that this bid is good for a period of ninety (90) days, unless otherwise stated.

---

 Company Name as registered  
with the IRS

---

 Authorized Signature

---

 Correspondence Address

---

 Printed Name

---

 City, State, Zip

---

 Title

---

 Date

---

 Telephone Number    Fax Number

---

 Remittance Address

---

 E-mail Address (PLEASE PRINT)

---

 City, State, Zip

---

 Telephone Number

---

 Toll-Free Number if available

---

 Federal Tax ID Number

---

 SC Sales and Use Tax Number

**INTENTIONALLY LEFT BLANK**

**Richland-Lexington Riverbanks Park District**

**B2022-06-12  
Hay Barn**

**LIST OF REFERENCES**

*Please list four (4) references that your company has recently or currently provided similar products and/or services for.*

\_\_\_\_\_  
Company Name

\_\_\_\_\_  
Company Name

\_\_\_\_\_  
Representative

\_\_\_\_\_  
Representative

\_\_\_\_\_  
Address

\_\_\_\_\_  
Address

\_\_\_\_\_  
City, State, Zip Code

\_\_\_\_\_  
City, State, Zip Code

\_\_\_\_\_  
Telephone # / Fax #

\_\_\_\_\_  
Telephone # / Fax #

\_\_\_\_\_  
E-Mail Address

\_\_\_\_\_  
E-Mail Address

\_\_\_\_\_  
Company Name

\_\_\_\_\_  
Company Name

\_\_\_\_\_  
Representative

\_\_\_\_\_  
Representative

\_\_\_\_\_  
Address

\_\_\_\_\_  
Address

\_\_\_\_\_  
City, State, Zip Code

\_\_\_\_\_  
City, State, Zip Code

\_\_\_\_\_  
Telephone # / Fax #

\_\_\_\_\_  
Telephone # / Fax #

\_\_\_\_\_  
E-Mail Address

\_\_\_\_\_  
E-Mail Address

COMPANY: \_\_\_\_\_

AUTHORIZED SIGNATURE: \_\_\_\_\_




Notes:

- 1- Demo sliding door, frame and track, dispose of off site
- 2- Enclose opening with 8 inch block.
- 3- Establish new door opening, coordinate height with catwalk height inside barn.
- 4- New door to be HD Metal with lockset for a schlage E key way
- 5-Door and walls to be primed and painted to match existing building color
- 6- Existing concrete and asphalt to be cut and removed for installation of foundations for supports and stairs


1/4 inch equals 1 foot

All measurements to be field verified

EXHIBIT A

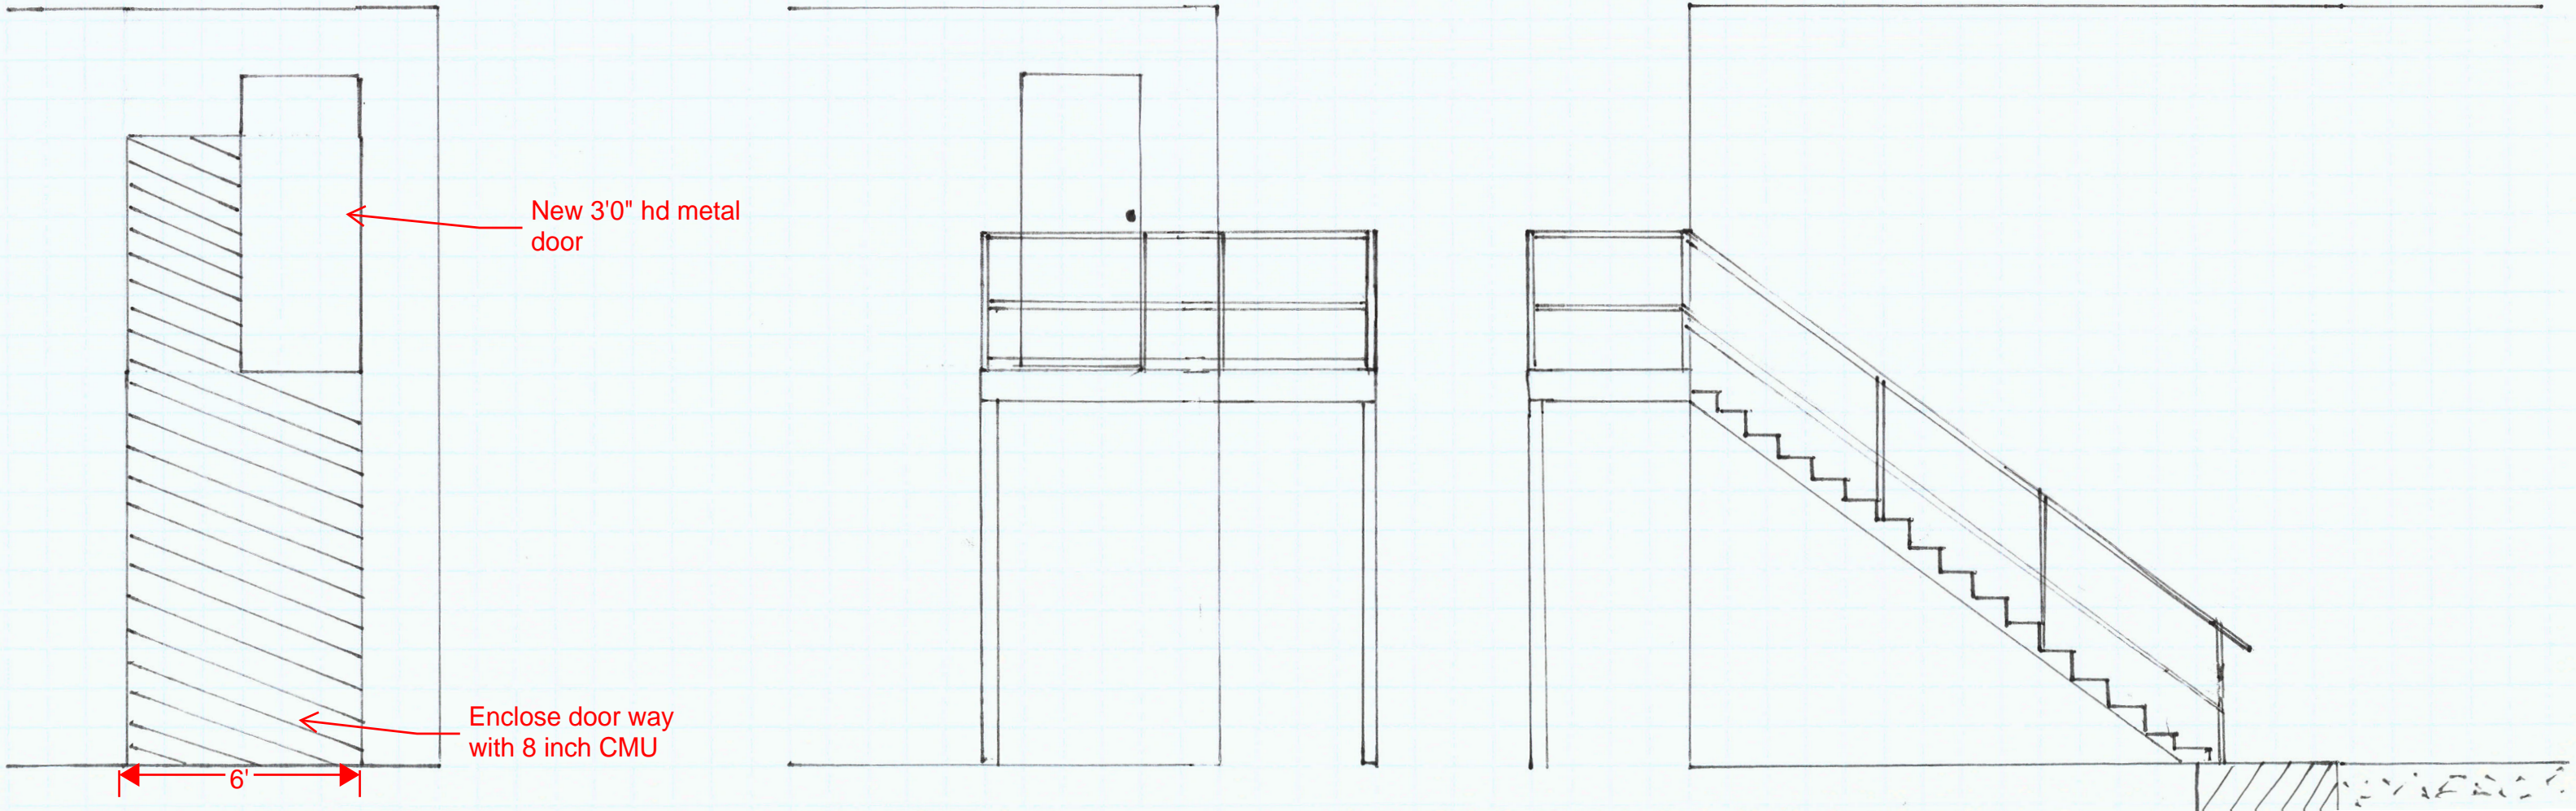




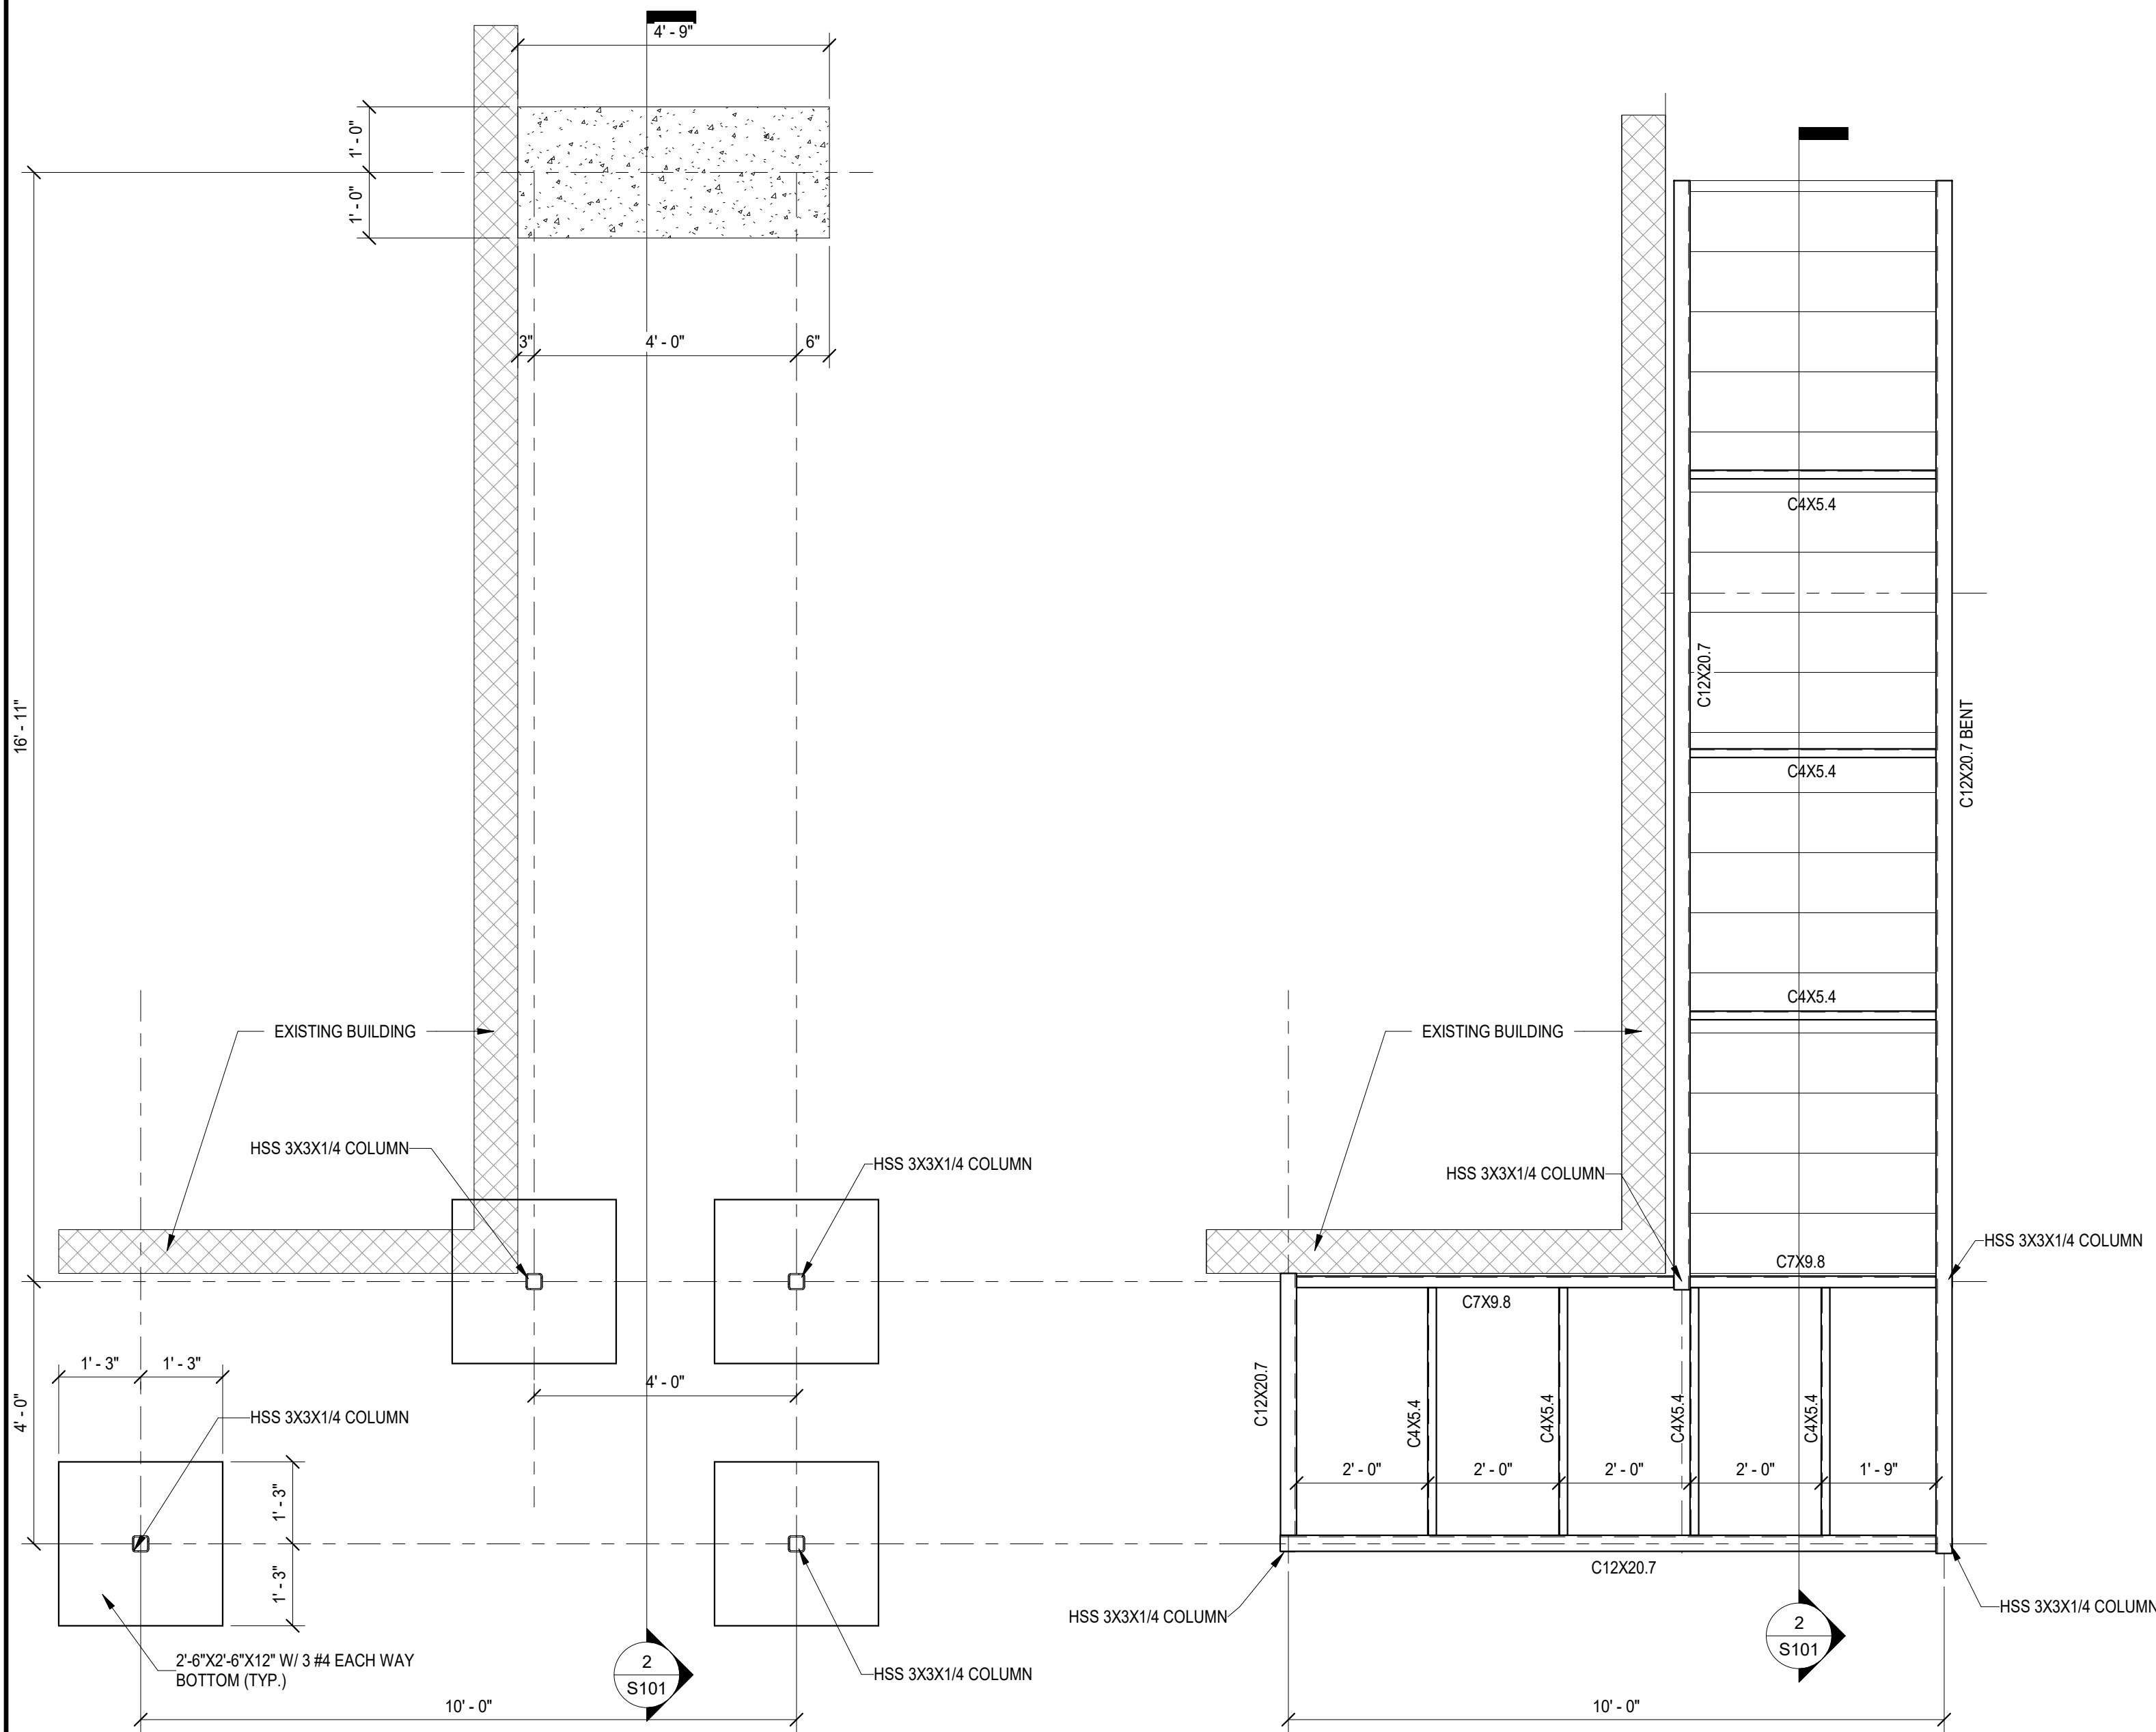


## 1 STAIR PLANS

S101 1/2" = 1'-0"  
NOTES:  
1. ALL STEEL TO BE HOT DIPPED GALVANIZED

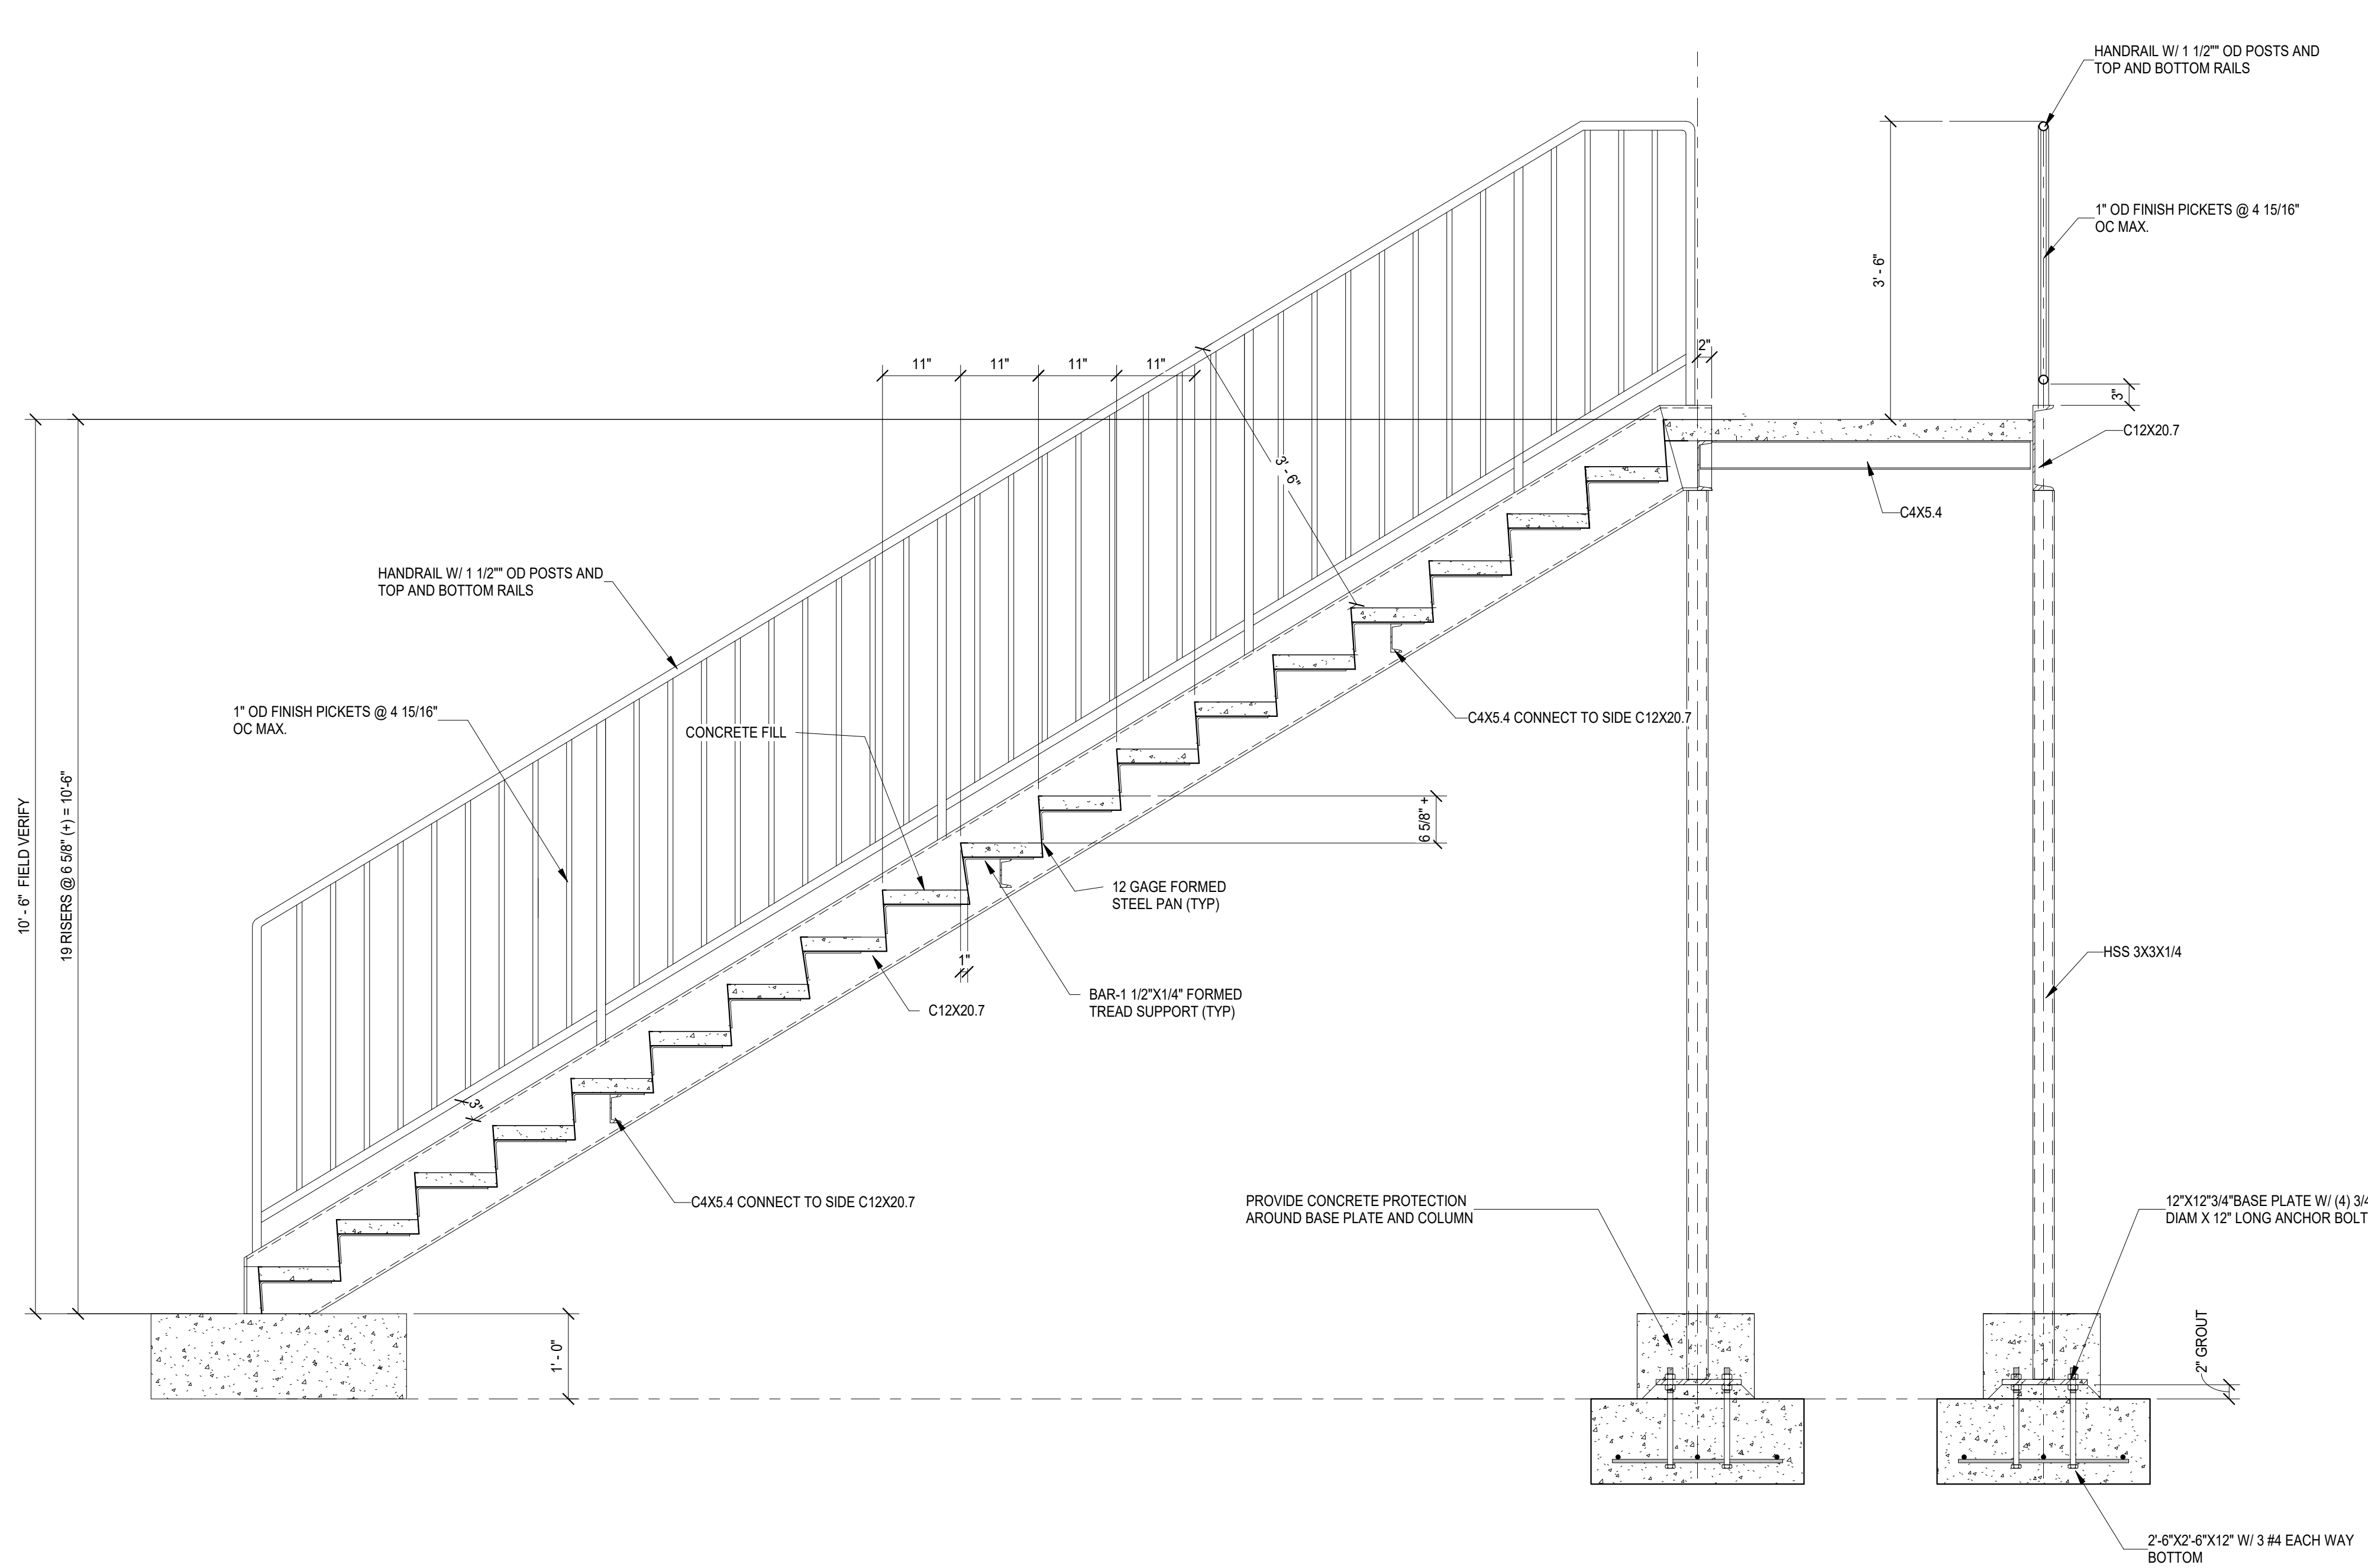


## 2 STAIR SECTION

S101 3/4" = 1'-0"  
NOTES:  
1. ALL STEEL TO BE HOT DIPPED GALVANIZED

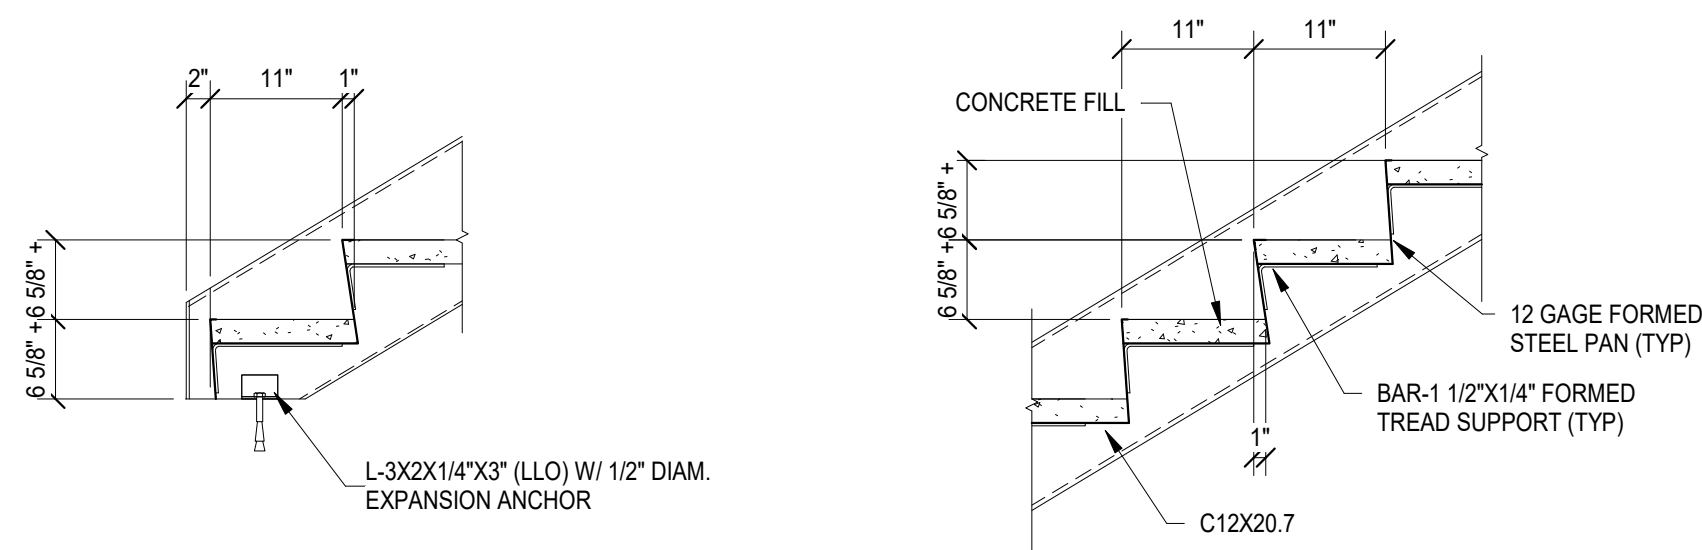

## 3 STAIR DETAILS

S101 3/4" = 1'-0"

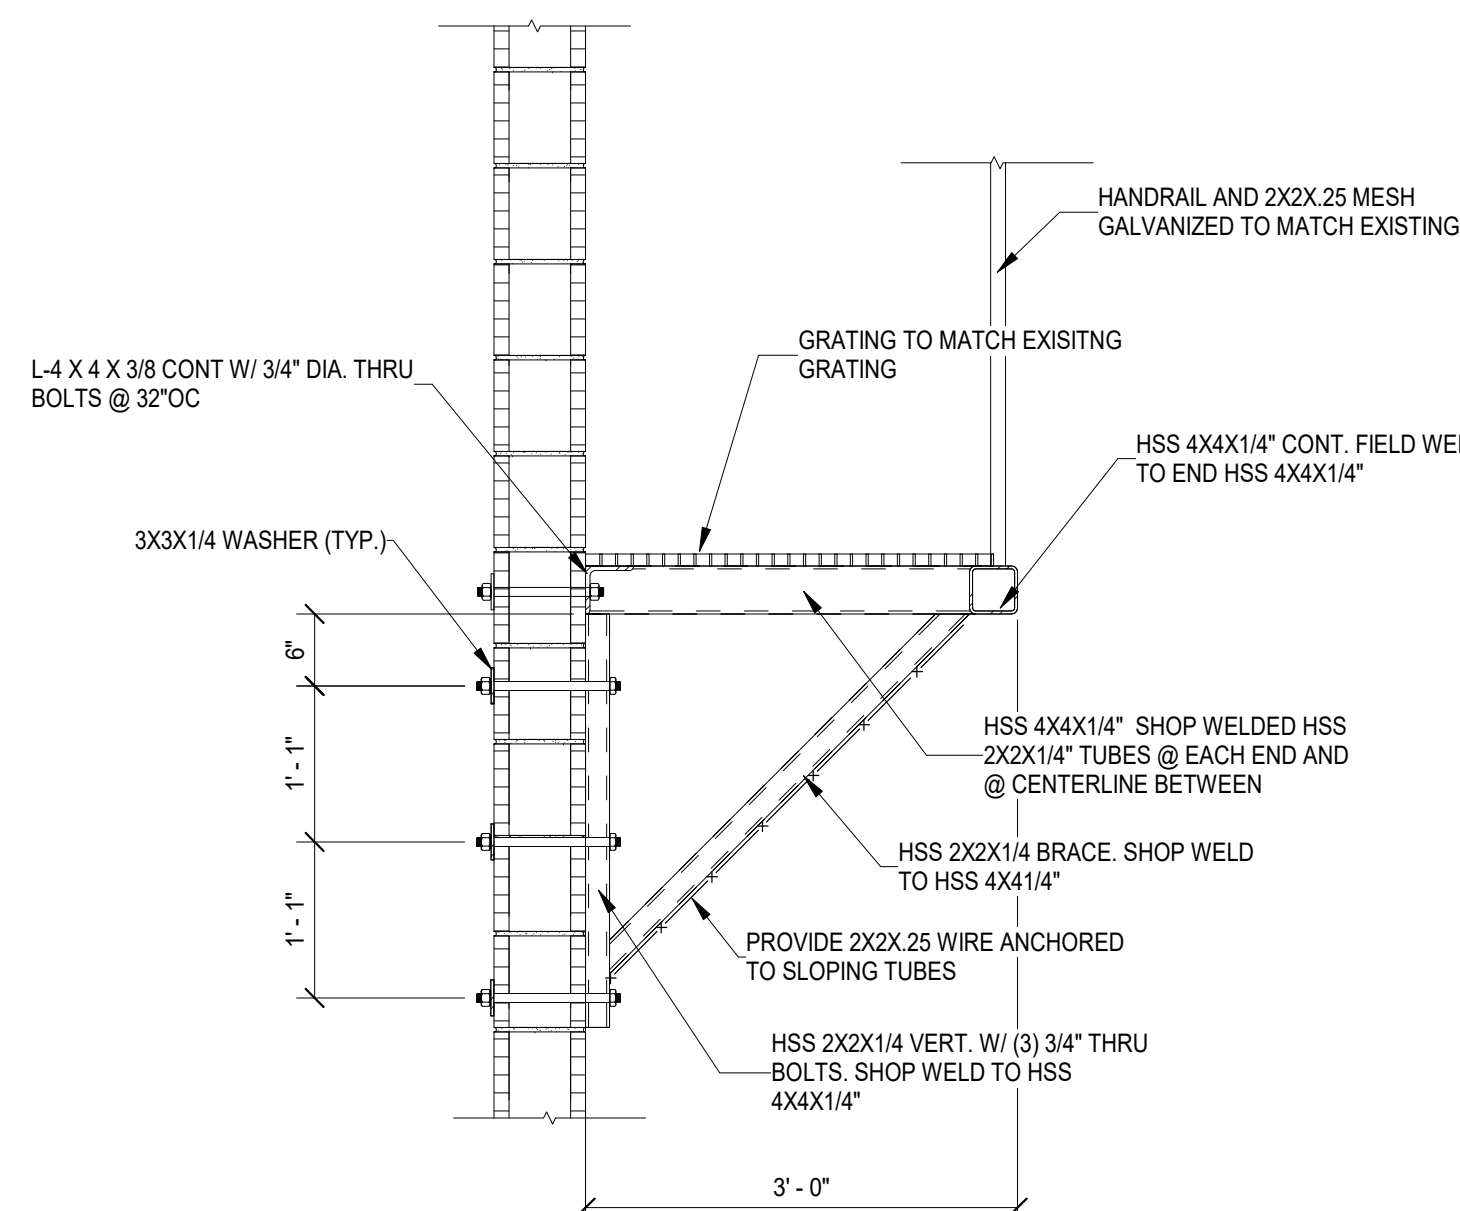


## 4 CATWALK

S101 3/4" = 1'-0"  
NOTES:  
1. ALL STEEL TO BE HOT DIPPED GALVANIZED

- GENERAL NOTES
- FIELD VERIFY ALL DIMENSIONS AND CONDITIONS RELATED TO EXISTING CONSTRUCTION.
  - DESIGN CRITERIA
    - BUILDING CODE: 2018 INTERNATIONAL BUILDING CODE
    - RISK CATEGORY: III
    - SEISMIC DESIGN DATA:
      - IMPORTANCE FACTOR: 1.25
      - $S_s = 0.348$   $S_i = 0.113$
      - $S_{D1} = 0.30$   $S_{D2} = 0.113$
      - SITE CLASS C, SEISMIC DESIGN CATEGORY B
    - WIND VELOCITY 125 MPH, EXPOSURE C, INTERNAL PRESSURE COEFFICIENT  $\pm 0.18$ .
    - ROOF LIVE LOAD: 20 PSF
    - GROUND SNOW LOAD: 10 PSF
  - FOUNDATION DESIGN IS BASED ON THE ASSUMED ALLOWABLE BEARING PRESSURE LISTED BELOW. CONTRACTOR SHALL HIRE AN INDEPENDENT TESTING LABORATORY, ACCEPTABLE TO THE ARCHITECT, TO VERIFY THE ALLOWABLE BEARING PRESSURE BEFORE FOOTINGS ARE CONSTRUCTED OR REINFORCING IS FABRICATED.
    - ASSUMED ALLOWABLE BEARING PRESSURE = 2500 PSF
    - STEP FOOTINGS AS REQUIRED TO LET UTILITIES PASS OVER FOOTINGS.
  - CONCRETE: 28-DAY COMPRESSIVE STRENGTHS SHALL BE AS FOLLOWS:
    - ALL CONCRETE: 3000 PSI, NORMAL WEIGHT
  - CONCRETE REINFORCING STEEL
    - ASTM A615, GRADE 60, EXCEPT WHERE REINFORCING IS SHOWN TO BE WELDED, USE ASTM A706 WELDABLE REINFORCING. DO NOT WELD OR TACK WELD ANY REINFORCING NOT SHOWN ON THE DRAWINGS TO BE WELDED.
    - DETAIL IN ACCORDANCE WITH ACI DETAILING MANUAL, LATEST EDITION.
    - LAP ALL BARS WITH CLASS B SPLICES UNLESS NOTED OTHERWISE.
    - PROVIDE CORNER BARS OF SAME SIZE AND SPACING AS HORIZONTAL REINFORCING AT ALL WALLS AND FOOTING INTERSECTIONS. LAP WITH CLASS B SPLICES.
  - STRUCTURAL STEEL
    - MATERIALS:
      - PIPE: ASTM A53, GRADE B
      - TUBE: ASTM A500, GRADE C
      - WIDE FLANGES AND TEES: ASTM A992, GRADE 50
      - OTHER: ASTM A36
    - FABRICATION SHALL BE IN ACCORDANCE WITH AISC SPECIFICATIONS.
    - BOLTED CONNECTIONS: ASTM A325, 3/4" DIAMETER, SNUG-TIGHTENED, BEARING TYPE CONNECTIONS WITH THREADS IN THE SHEAR PLANE UNLESS NOTED OTHERWISE.
    - WELDED CONNECTIONS: E70XX ELECTRODES. ELECTRODES USED FOR WELDING A992 STEEL SHALL BE LOW HYDROGEN ELECTRODES.

REVISIONS	BY

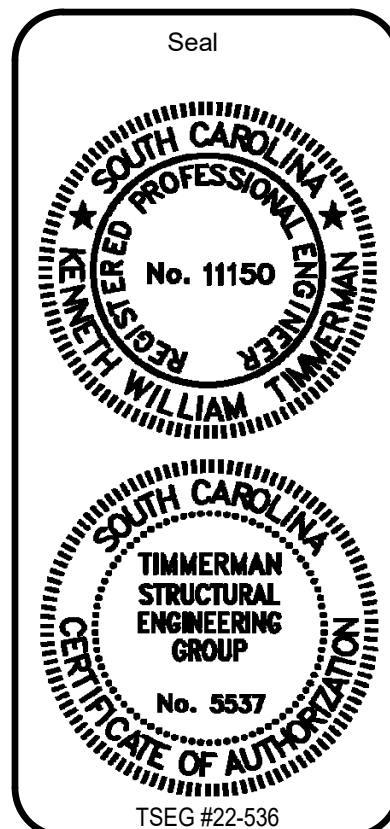

JOB TITLE:  
**RIVERBANKS ZOO STAIR  
COLUMBIA, SOUTH CAROLINA**



Drawing Title:  
**STEEL STAIR AND  
CATWALK ADDITION**

Scale: AS NOTED  
Job Number: 22-536  
Designed By: LWK  
Drawn By: LWK  
Checked By: KWT  
Date: Issue Date

Sheet Number:  
**S101**  
of



NEW CONSTRUCTION SHALL MEET
BUILDING CODE IBC 2018 REQUIREMENTS 2009 IECC OR ASHRAE 90.1 2007
BUILDING CODE INFORMATION - IBC 2018 2614 sf -Total square feet
IBC 2018- Sect. 303.3 page 41 Occupancy classification: S1 -Storage IBC 2018- chapter 6, section 602.4, Table 601 Construction Type: V̄a- unsprinklered IBC 2018- chapter 5, section 504.3, Table 506.2 Building Height: max allowed (3 story) Building Height: 2 story actual
New Building - Exterior - CMU walls ,concrete floors, steel columns, beams and roof joists - metal roof
IBC 2018- chapter 5, section 504.3, 506.2 Building Area Allowed: 9,000 sf max IBC 2018- chapter 5, section 506.2.1
Building Area Actual: 2614 sf
EGRESS -
IBC 2018 - CHAPTER 10, TABLE 1004.1.2 1 EXIT REQUIRED - 1 PROVIDED- SECTION 1006.2.1 EGRESS WIDTH PROVIDED = 34" EGRESS WIDTH PER OCCUPANT REQUIRED = .015/PER 100' TO EXIT MAX. - TABLE 1017.2 EMERGENCY LIGHTS REQUIRED 34" WIDTH ,REQ. = 34" EXIT WIDTHS PROVIDED ,CORRIDOR WIDTH MIN. 44"
FIRE AREAS AND ALARMS
IBC 2018 - CHAPTER 7
2 HOUR RATED FIRE SEPERATION REQUIRED - EXISTING BUILDING - 2 HR WALL FIRE ALARM SYSTEM- FIRE ALARM PROVIDED EXISTING SHALL MEET NFPA 72 CODE REQUIREMENTS
OCCUPANT LOAD
OCCCUPANCY TYPE - Storage Total - 2614/300 = 9 Occupants
ALL AREAS - TOTAL - 9 OCCUPANTS TOTAL
PLUMBING CODE INFORMATION - IBC CHAPTER 29, TABLE 290.2.1
no plumbing facilities is required - no occupants occupy storage facility
ALL PLUMBING WORK SHALL MEET INTERNATIONAL PLUMBING CODE REQUIREMENTS. ALL ELECTRICAL WORK SHALL MEET INTERNATIONAL ELECTRICAL CODE REQUIREMENTS. PROVIDE: EXIT LIGHTS W/ BATTERY BACK-UPS AT ALL EXITS, EMERGENCY LIGHTS IN ALL INTERIOR AREAS REQUIRED FOR EGRESS- MIN. 1 FT CANDLE EMERGENCY LIGHTS AT ALL EXTERIOR EGRESS AREAS EMERGENCY LIGHTS AS SHOWN ON PLAN PROVIDE INTERIOR DOORS HARDWARE (LEVER SET) THAT MEETS ADA CODE REQUIREMENTS PROVIDE DOOR HARDWARE AT EXIT DOORS TO MEET CODE REQUIREMENTS PROVIDE SAFETY FALL PROTECTION RAILS AT ROLL-UP DOOR ON SECOND FLOOR PROVIDE SAFETY FALL PROTECTION RAILS AT ROOF HATCH IF REQUIRED BY CODE.

EXHIBIT A

RIVERBANKS ZOO

NEW HAY BARN

500 WILDLIFE PARKWAY  
COLUMBIA , SC

DRAWING INDEX

CO COVER SHEET

ARCHITECTURAL

- A1 EXISTING FLOOR PLANS  
A2 NEW FLOOR PLANS  
A3 ELEVATIONS  
A4 DEMOLITION AND ROOF PLAN  
A5 DETAILS  
A6 SPECIFICATIONS  
A7 SPECIFICATIONS  
A8 SPECIFICATIONS  
A9 SPECIFICATIONS

PLUMBING


- P1 PLUMBING DEMOLITION FLOOR PLAN  
P2 PLUMBING FLOOR PLAN  
P3 PLUMBING SCHEDULES AND DETAILS  
P4 PLUMBING SPECIFICATIONS

STRUCTURAL

- S1.0 FOUNDATION PLAN  
S1.1 FRAMING PLAN  
S2.0 FOUNDATION SECTIONS  
S2.1 SECTION CONTINUED  
S2.2 TYPICAL DETAILS  
S3.0 NOTES  
S3.1 SPECIAL INSPECTIONS

ELECTRICAL

- E1 LEGEND  
E2 LIGHTING PLAN  
E3 POWER PLAN  
E4 SCHEDULES AND DETAILS

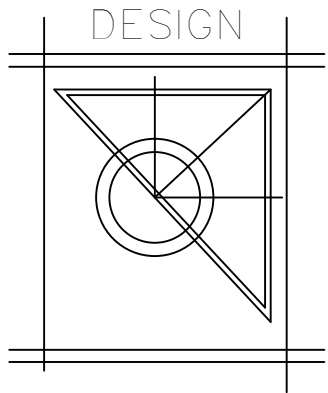

RDS DESIGN, LLC

ARCHITECTURE

821 KINLOCK CT.  
COLUMBIA, SOUTH CAROLINA 29223  
803.447.4817 Simkins@aol.com



Robert Simkins

3/01/2022



SEAL

RIVERBANKS ZOO – HAY BARN

500 WILDLIFE PARKWAY

COLUMBIA, SC

SHEET TITLE:

COVER SHEET

DRAWN BY \_\_\_\_ RS \_\_\_\_





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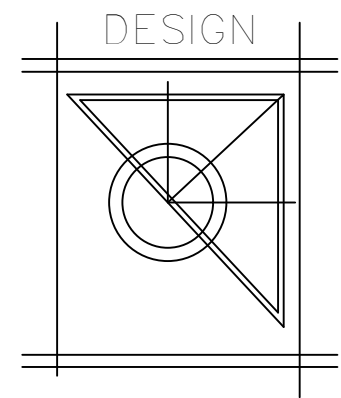
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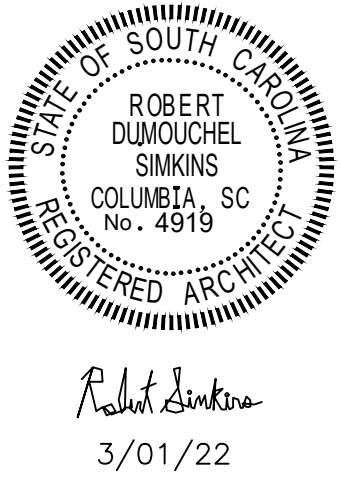




SECOND FLOOR PLAN -EXISTING  
SCALE: 1/4"=1'-0"



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RIVERBANKS ZOO – HAY BARN  
500 WILDLIFE PARKWAY  
COLUMBIA, SC

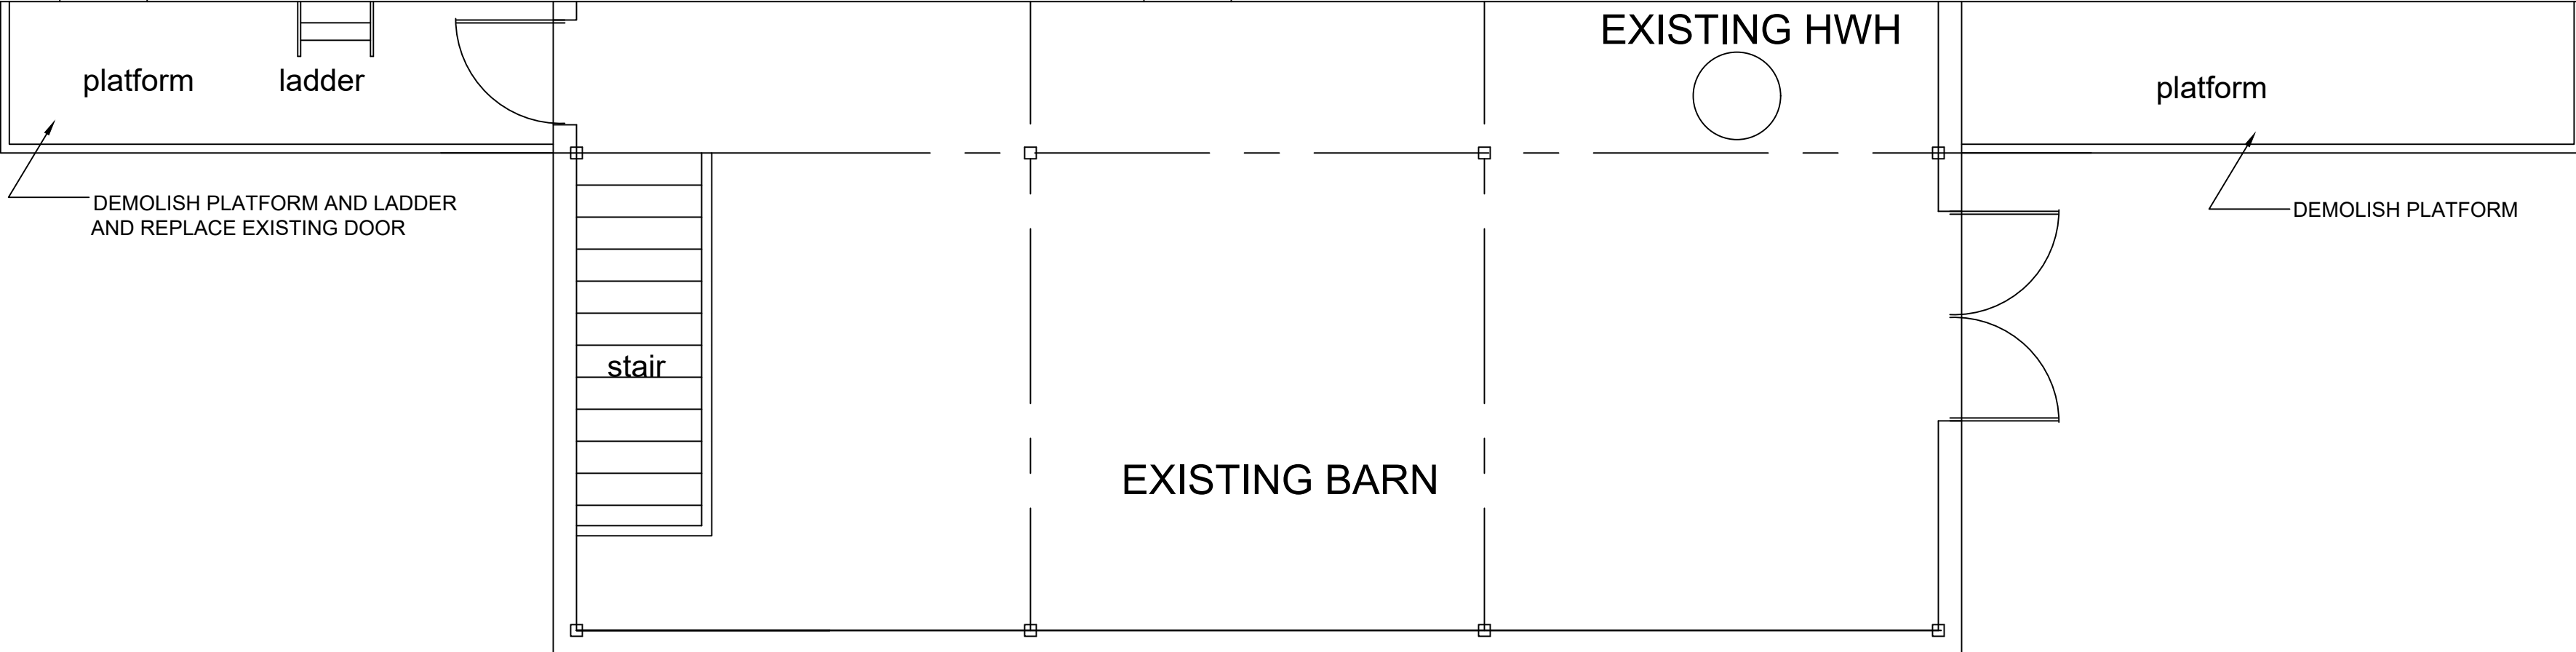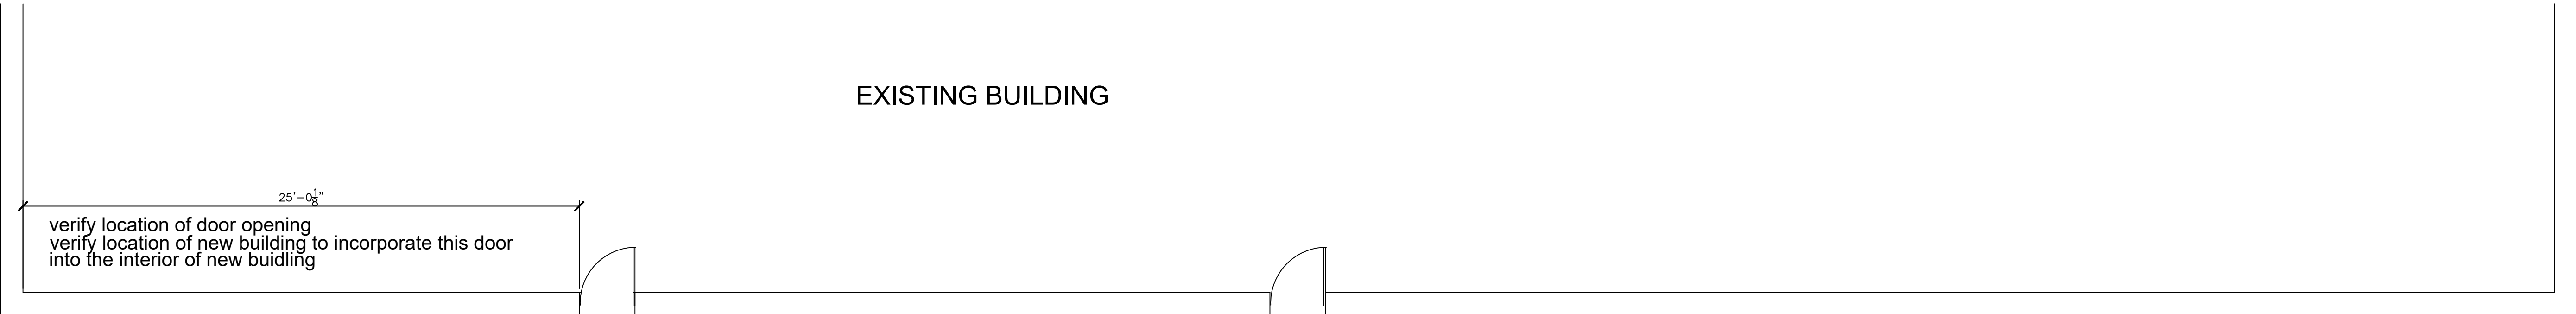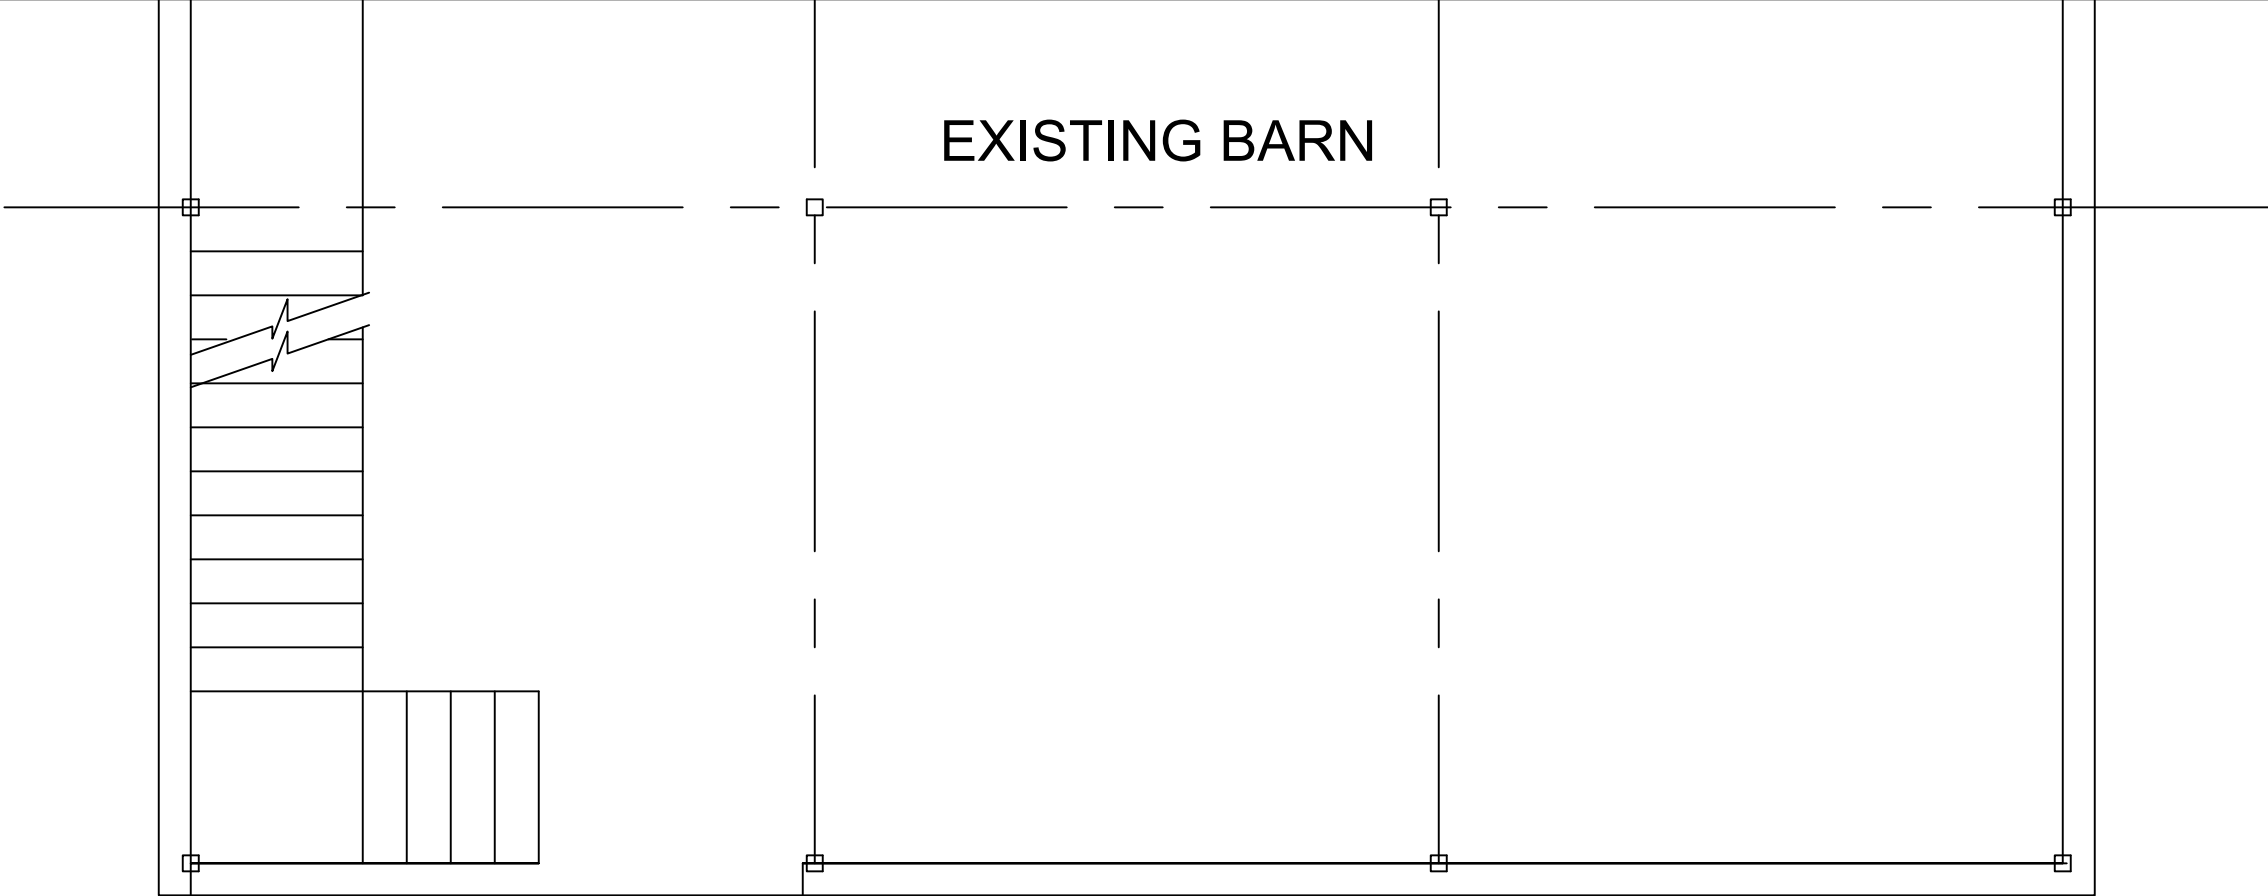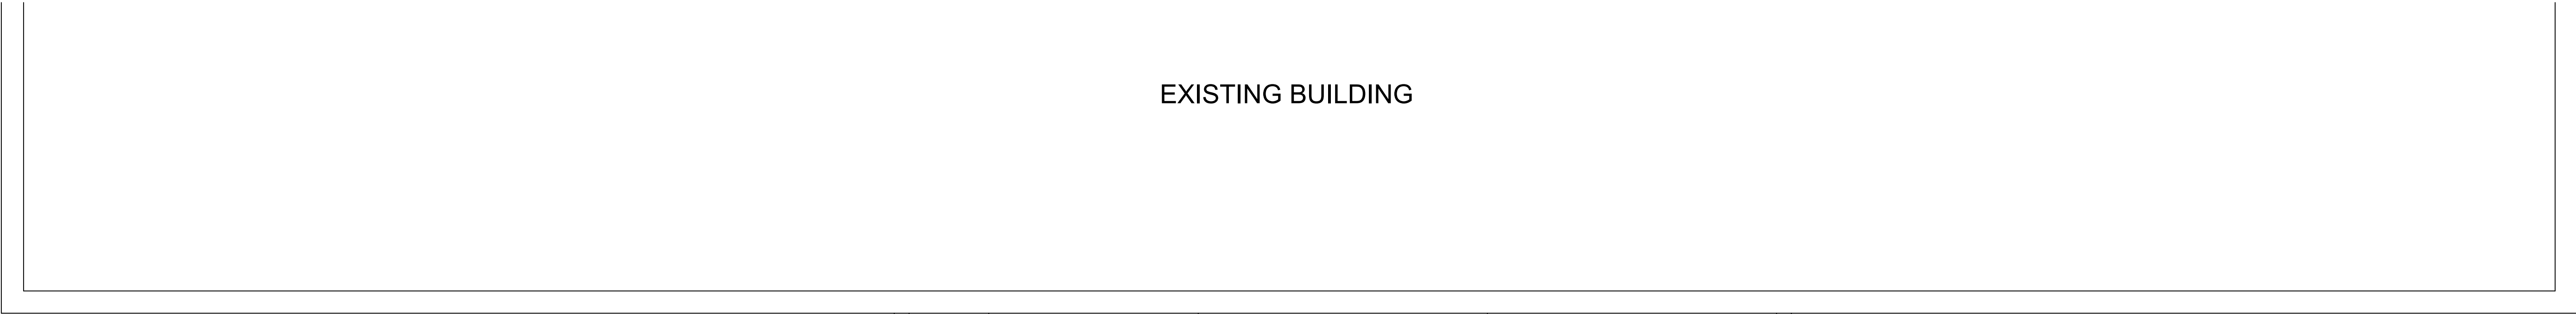
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EXISTING FLOOR PLANS

DRAWN BY \_\_\_\_\_ RS  
DATE 3/01/22


SHEET NO.

OF

A1

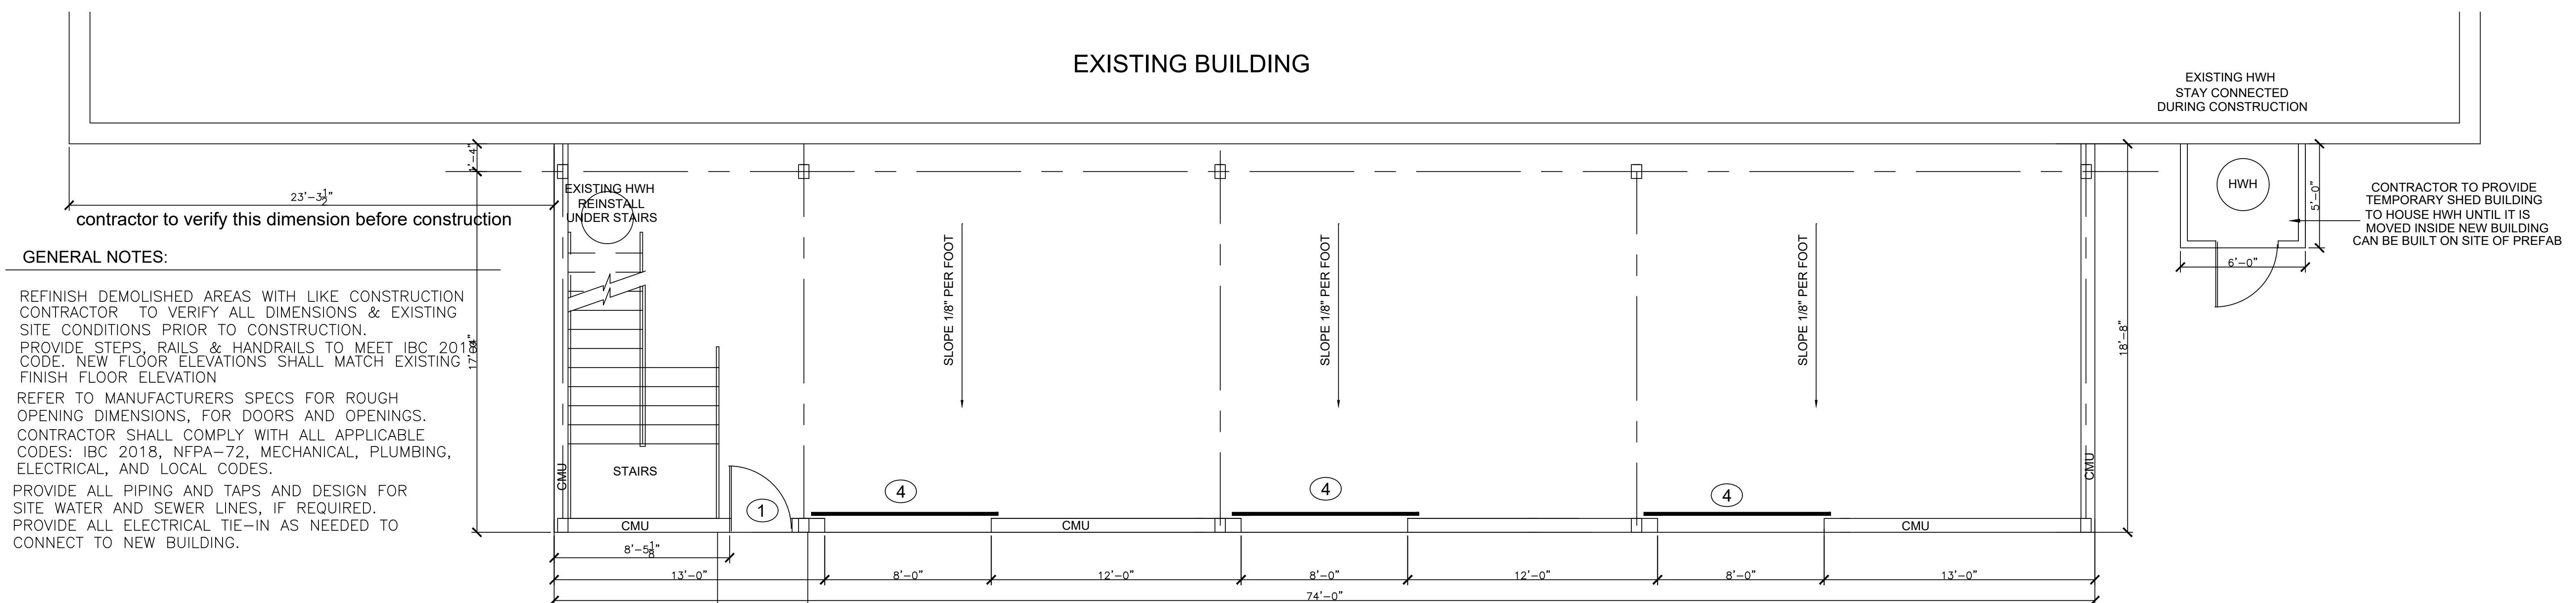

FIRST FLOOR PLAN - NEW  
SCALE: 1/4"=1'-0" 1307 sf

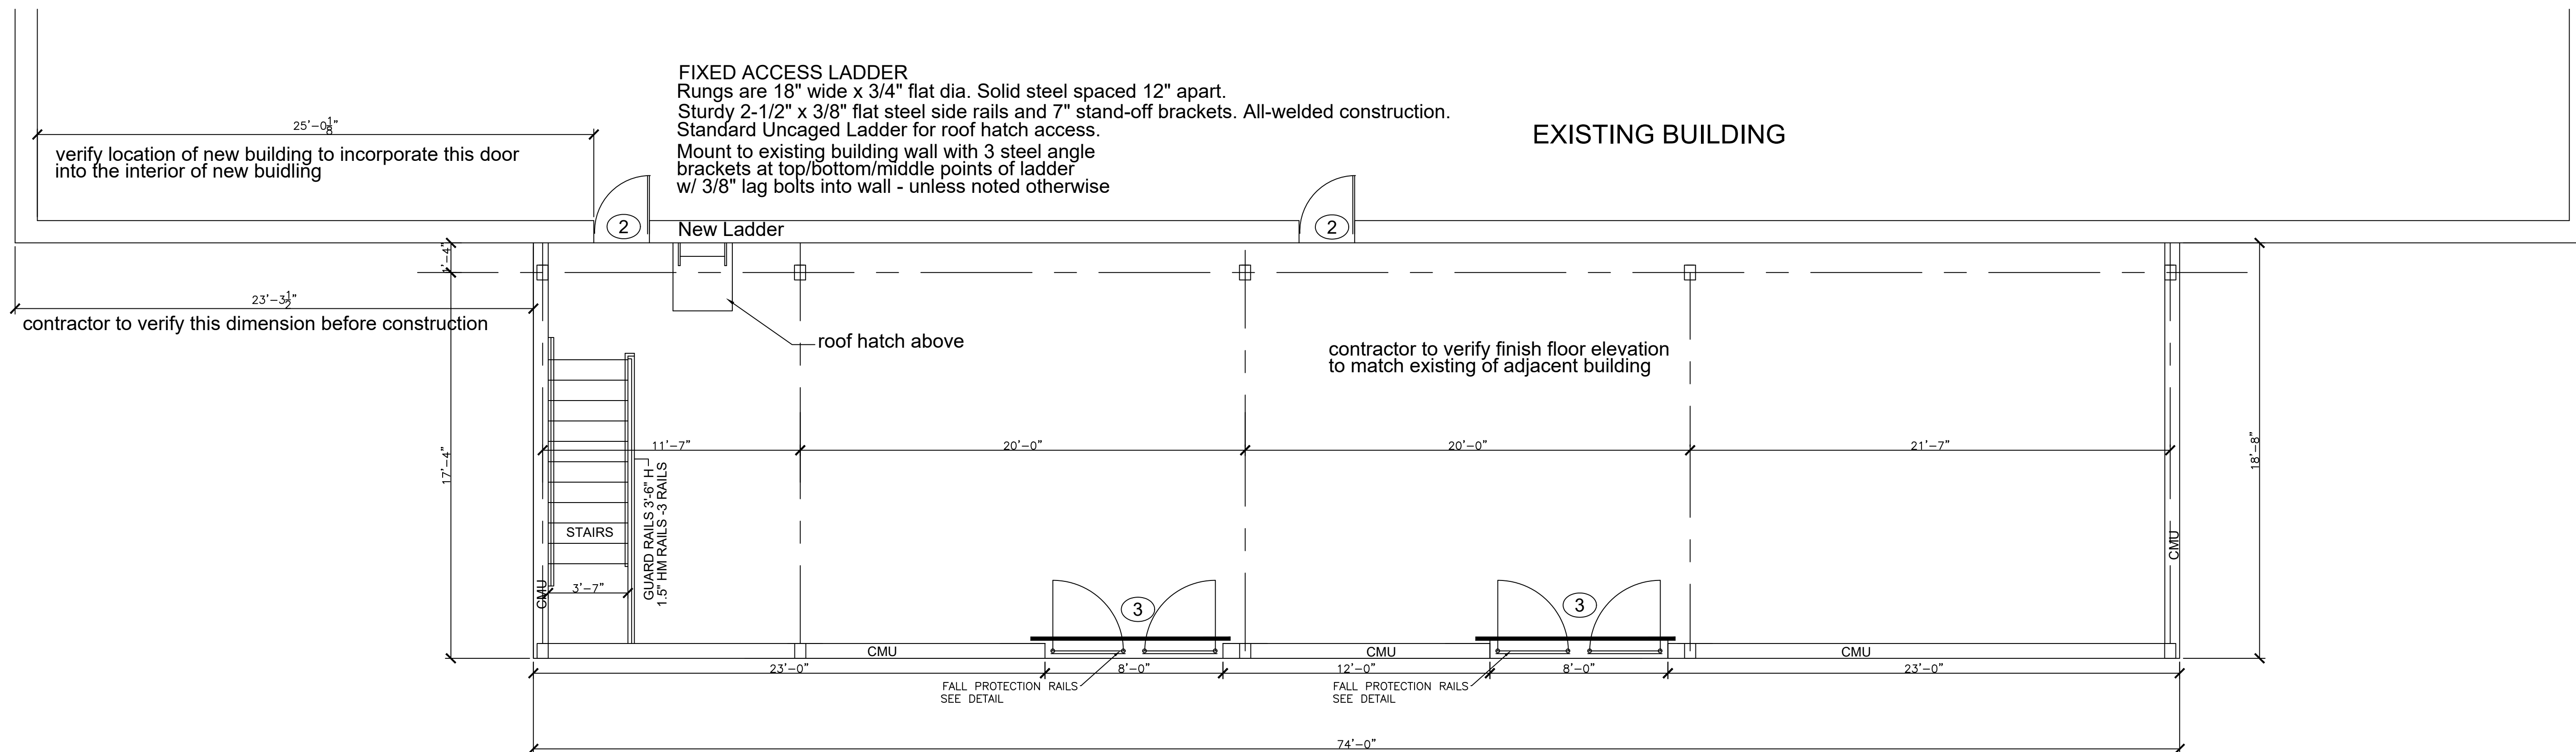


SECOND FLOOR PLAN - NEW  
SCALE: 1/4"=1'-0" 1307 sf

GENERAL NOTES:

1. ALL NEW WORK SHALL CONFORM TO 2018 IBC BUILDING CODE REQUIREMENTS.  
INCLUDING ALL SLAB FOUNDATIONS, BEAMS, WALLS, DOORS ETC.  
INCLUDING ALL ELECTRICAL, MECHANICAL, AND PLUMBING LINES  
ALL PLUMBING WORK SHALL MEET INTERNATIONAL PLUMBING CODE REQUIREMENTS.  
ALL ELECTRICAL WORK SHALL MEET INTERNATIONAL ELECTRICAL CODE REQUIREMENTS.  
ALL FIRE ALARM SYSTEM MEET NFPA 72 REQUIREMENTS.

2. CONTRACTOR SHALL VERIFY WORK SCHEDULE WITH CLIENT A MINIMUM OF 24 HOURS WORK BEGINS. STANDARD WORK HOURS ARE M-F 8AM TO 4PM  
ANY ADDITIONAL NON STANDARD WORK HOURS MUST BE REQUESTED AND APPROVED BY OWNER.  
COORDINATE ACCESS/DELIVERIES AND EQUIPMENT LAYDOWN AREAS WITH OWNER.

3. CONTRACTOR SHALL VERIFY ALL DIMENSIONS BEFORE ANY WORK BEGINS.
4. CONTRACTOR SHALL INSTALL ALL ITEMS PER MFG. INSTRUCTIONS.
5. CONTRACTOR SHALL VERIFY ALL EXISTING WATER/SEWER/ELECTRICAL AND UNDERGROUND UTILITY LOCATIONS BEFORE STARTING ANY DEMOLITION OR NEW WORK.
6. CONTRACTOR SHALL REROUTE THE EXISTING WATER AND SEWER LINE SO IT IS OPERABLE TO PROVIDE WATER AND SEWER TO EXISTING BUILDING HOT WATER HEATER THAT WILL BE MOVED TO A TEMPORARY LOCATION DURING CONSTRUCTION. CONTRACTOR SHALL MOVE WATER HEATER TO NEW LOCATION INSIDE BUILDING AND RECONNECT AFTER NEW BUILDING IS COMPLETED.

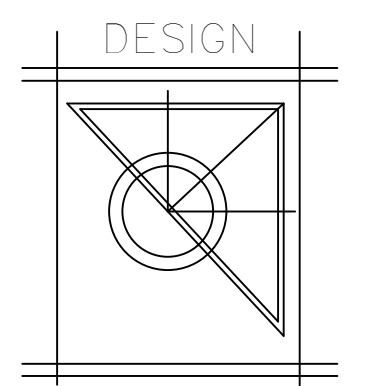


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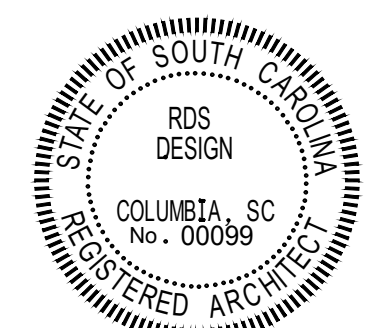
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Robert Sinkov  
3/01/22




SEAL

RIVERBANKS ZOO – HAY BARN  
500 WILDLIFE PARKWAY  
COLUMBIA, SC


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NEW FLOOR PLANS

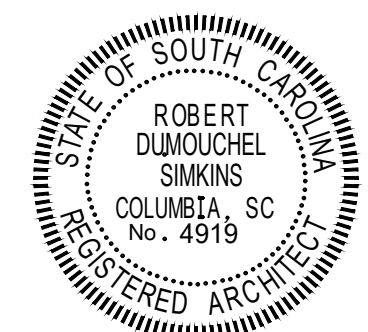DRAWN BY \_\_\_\_\_ RS \_\_\_\_\_  
DATE 3/01/22


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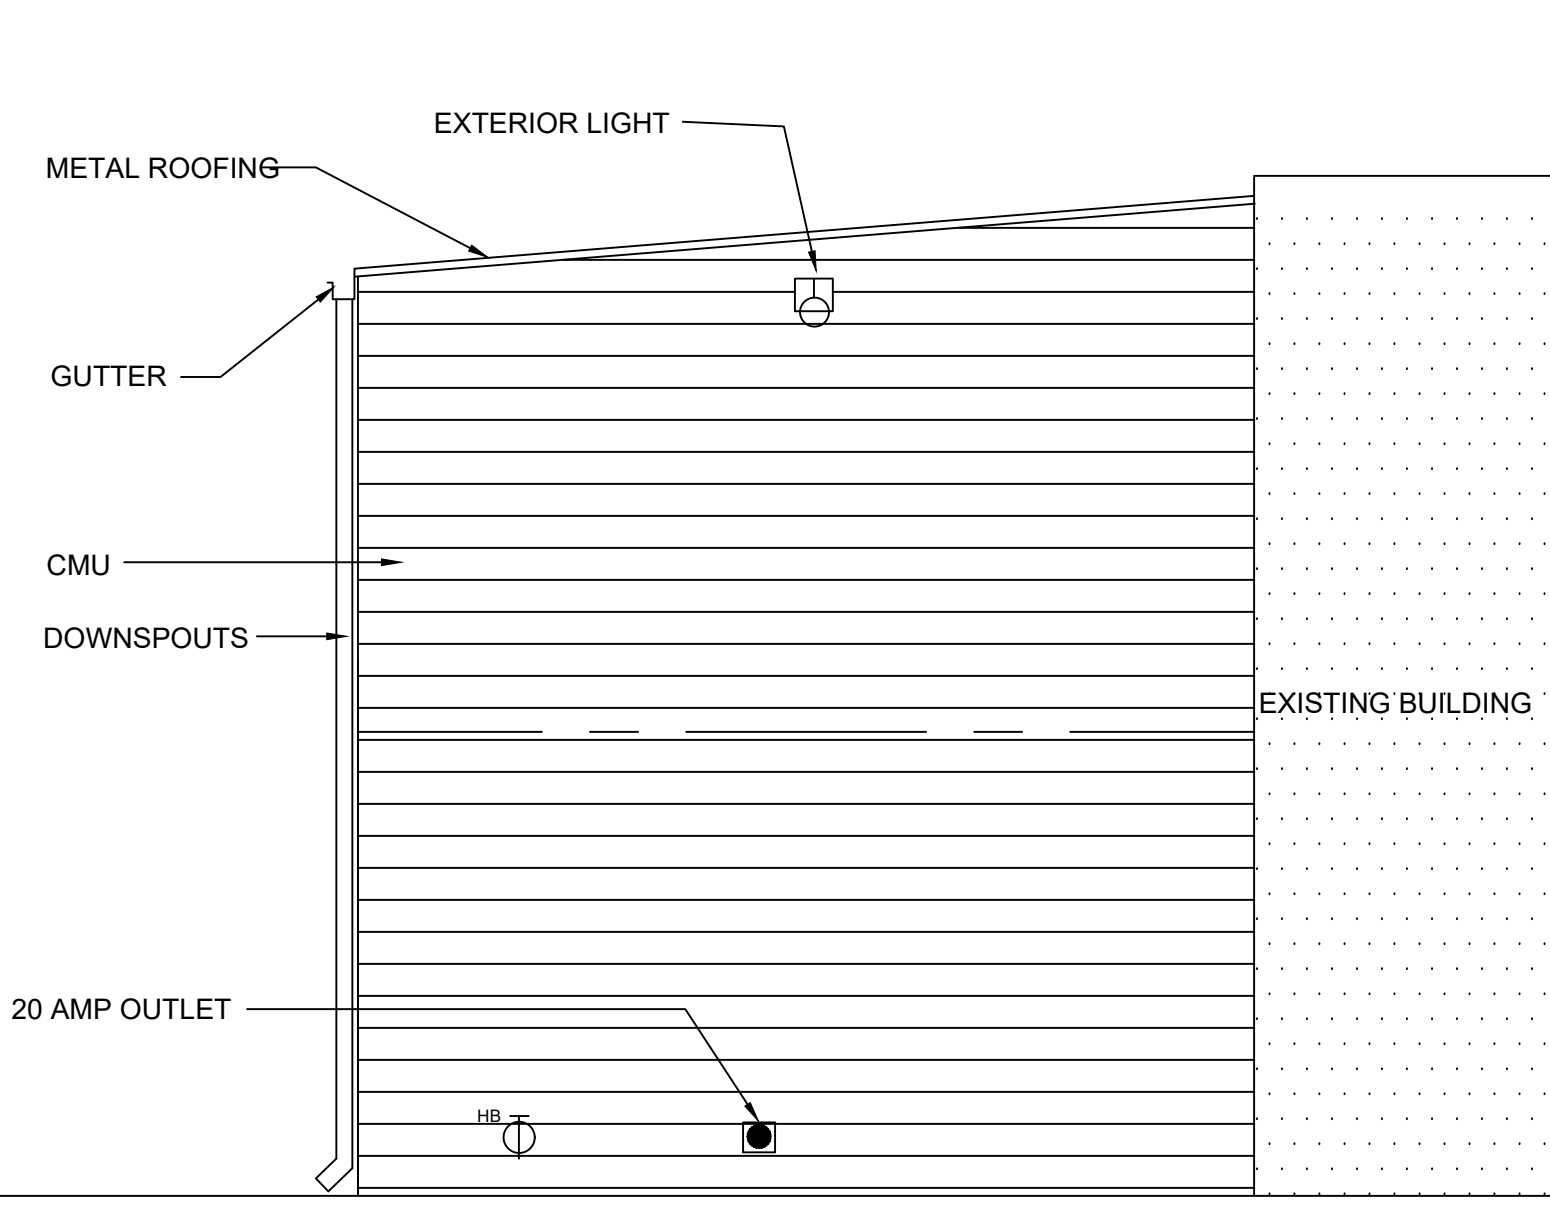
FRONT ELEVATION -EXISTING  
SCALE: 1/4"=1'-0"

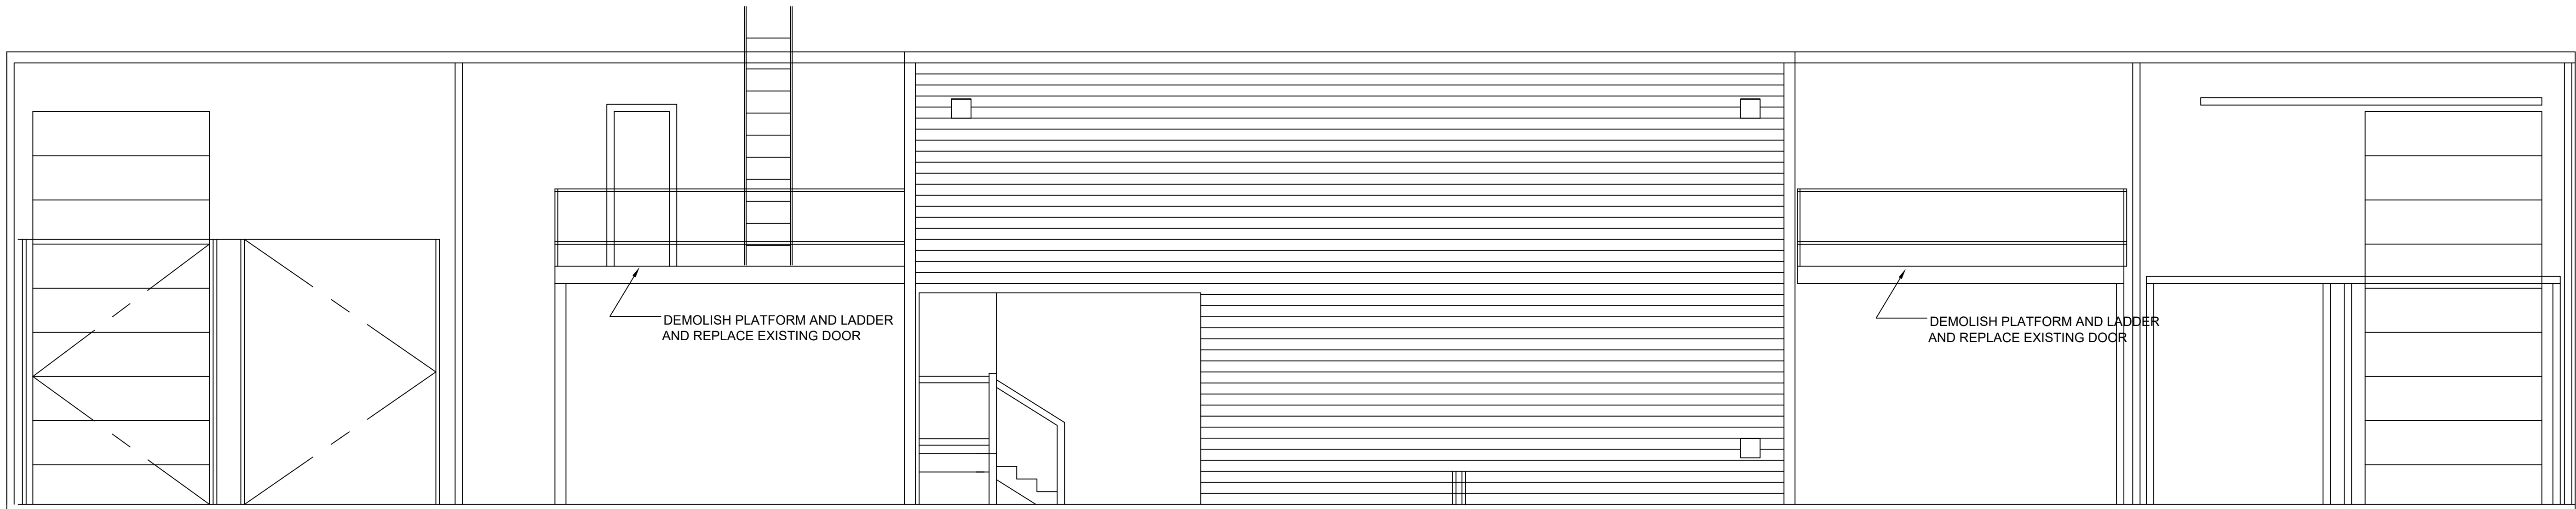


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SCALE: 1/4"=1'-0"

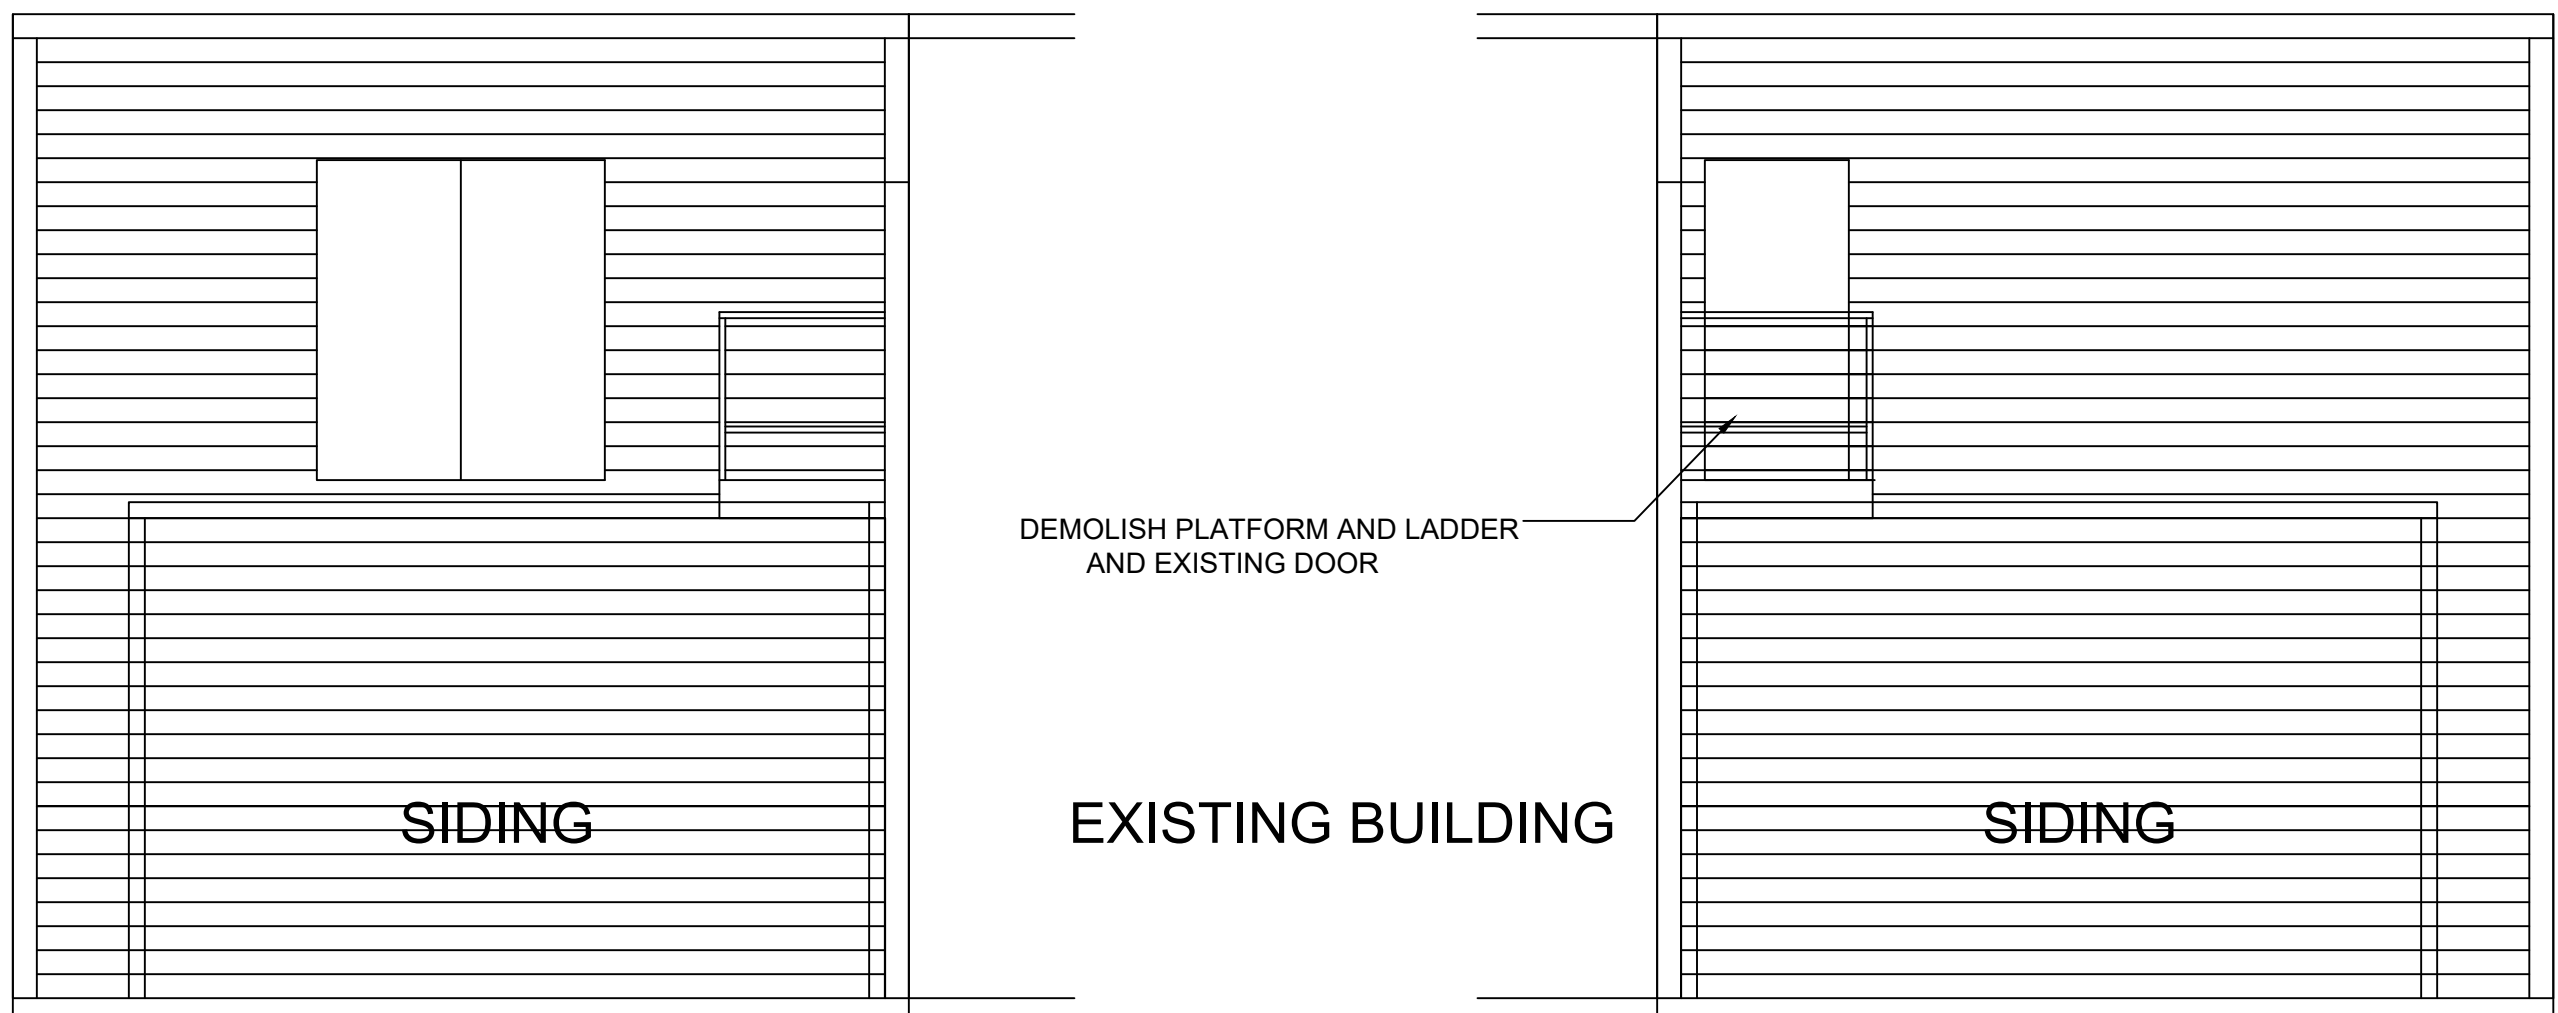


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RIGHT SIDE ELEVATION - NEW  
SCALE: 1/4"=1'-0"

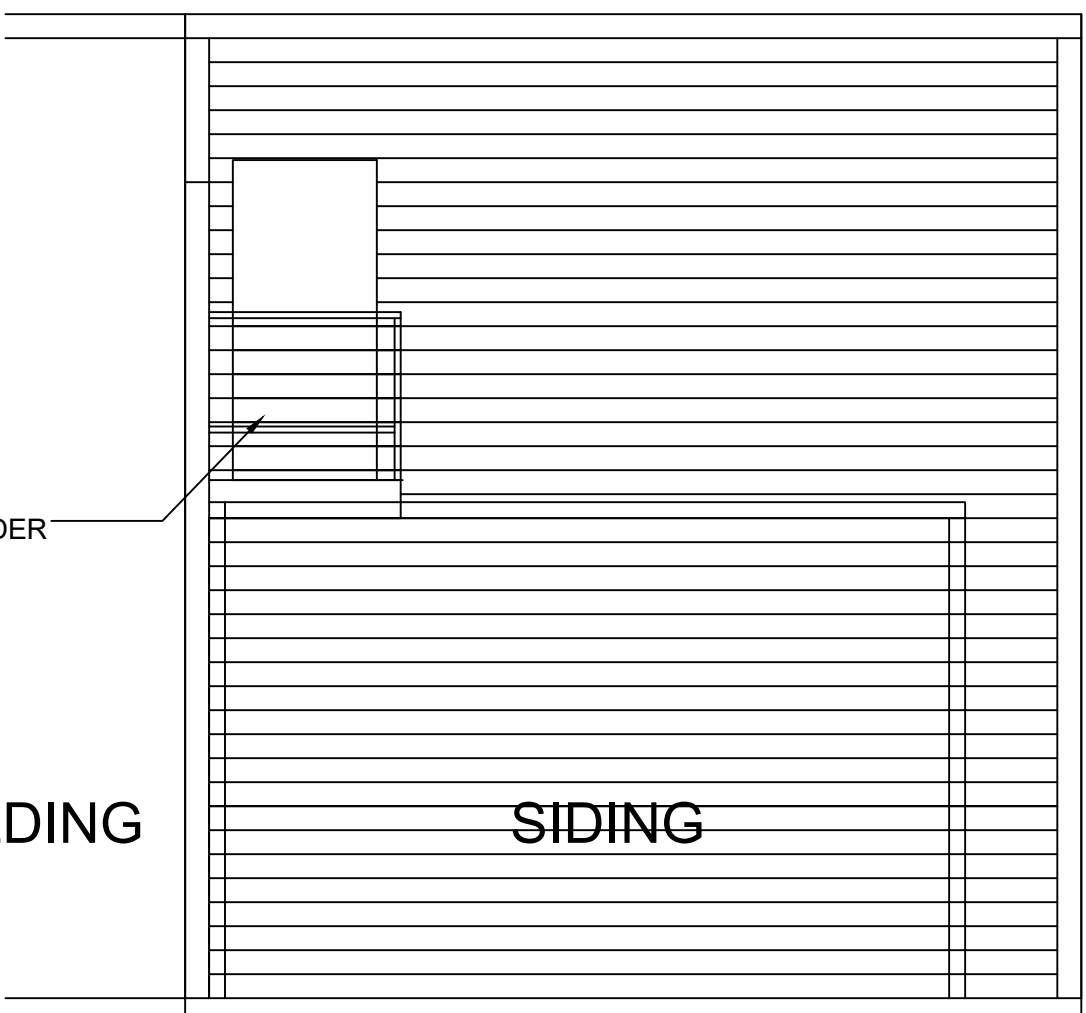


LEFT SIDE ELEVATION - NEW  
SCALE: 1/4"=1'-0"

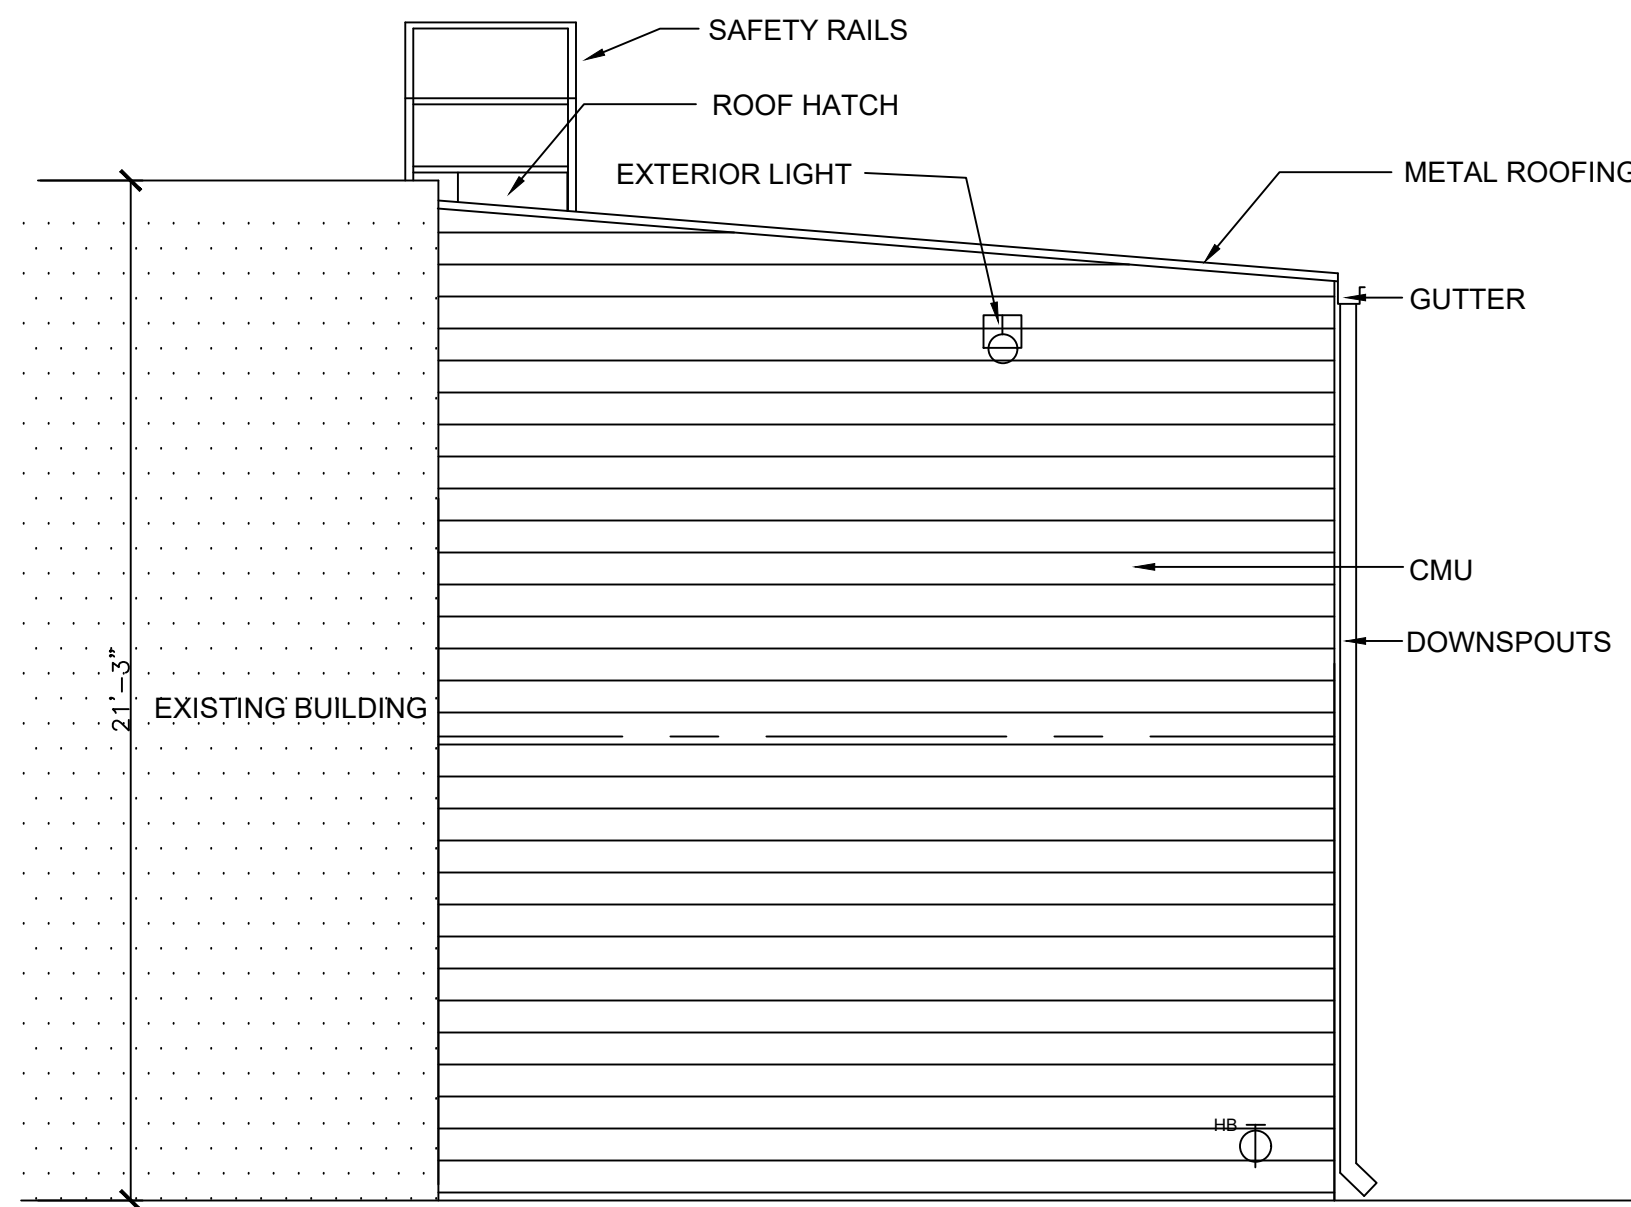

FRONT ELEVATION -NEW  
SCALE: 1/4"=1'-0"

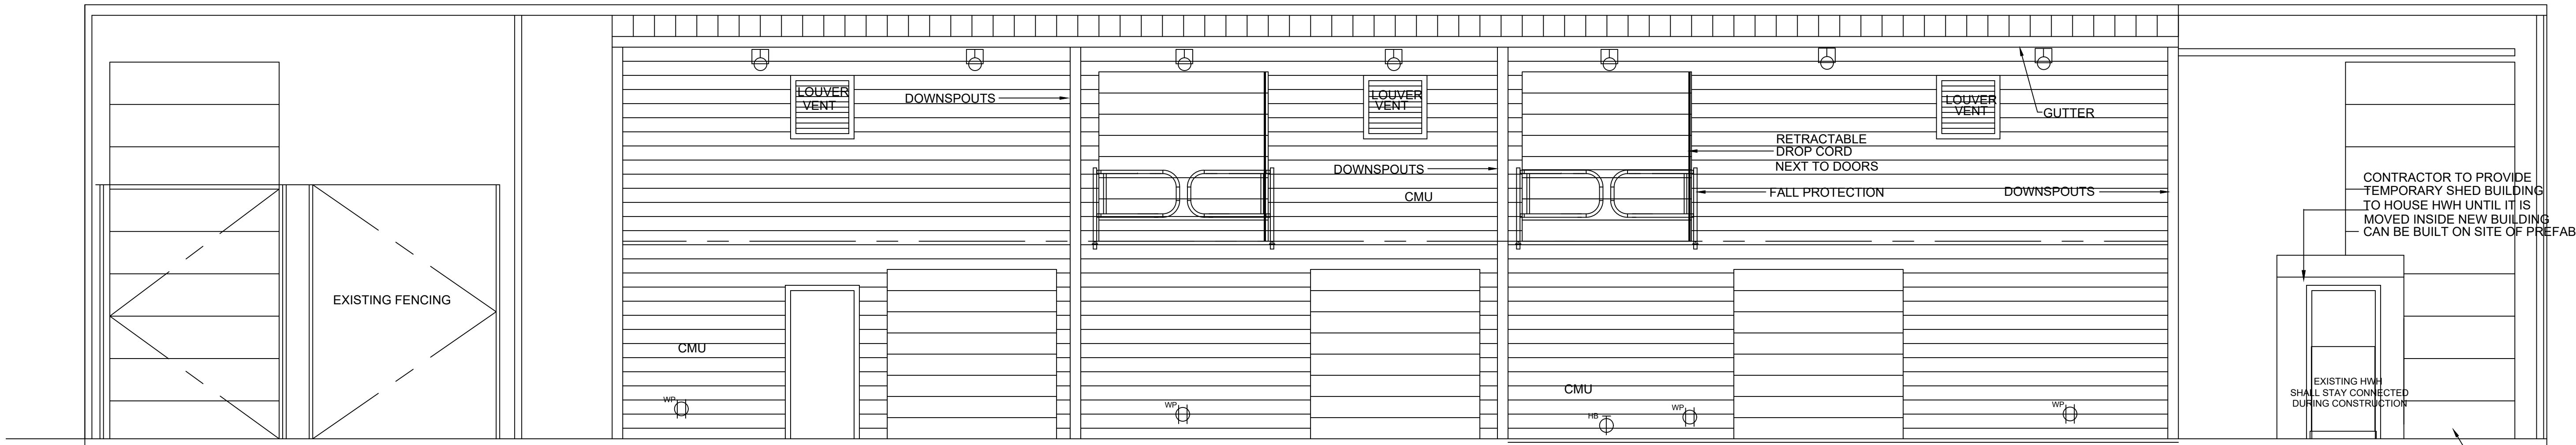
THE ZOO WILL BLOCK UP THIS DOOR AND INSTALL TEMPORARY STAIR FOR USE WHILE BUILDING IS UNDER CONSTRUCTION THIS WILL BE SEPERATE FROM THIS PROJECT'S SOW

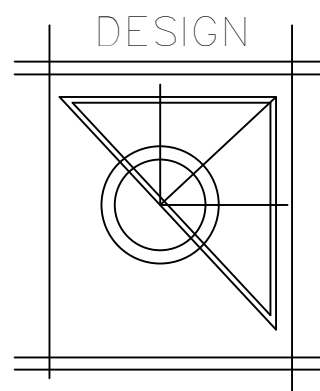


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3/01/22




SEAL

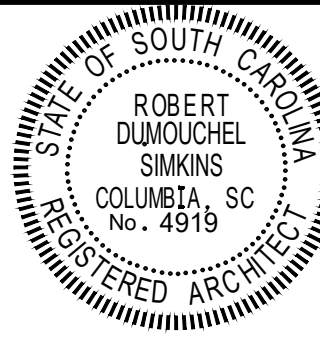RIVERBANKS ZOO – HAY BARN  
500 WILDLIFE PARKWAY  
COLUMBIA, SC


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ELEVATIONS

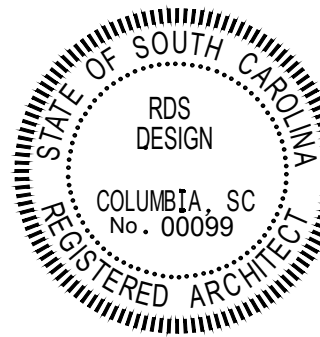DRAWN BY RS  
DATE 3/01/22

SHEET NO. OF  
A3

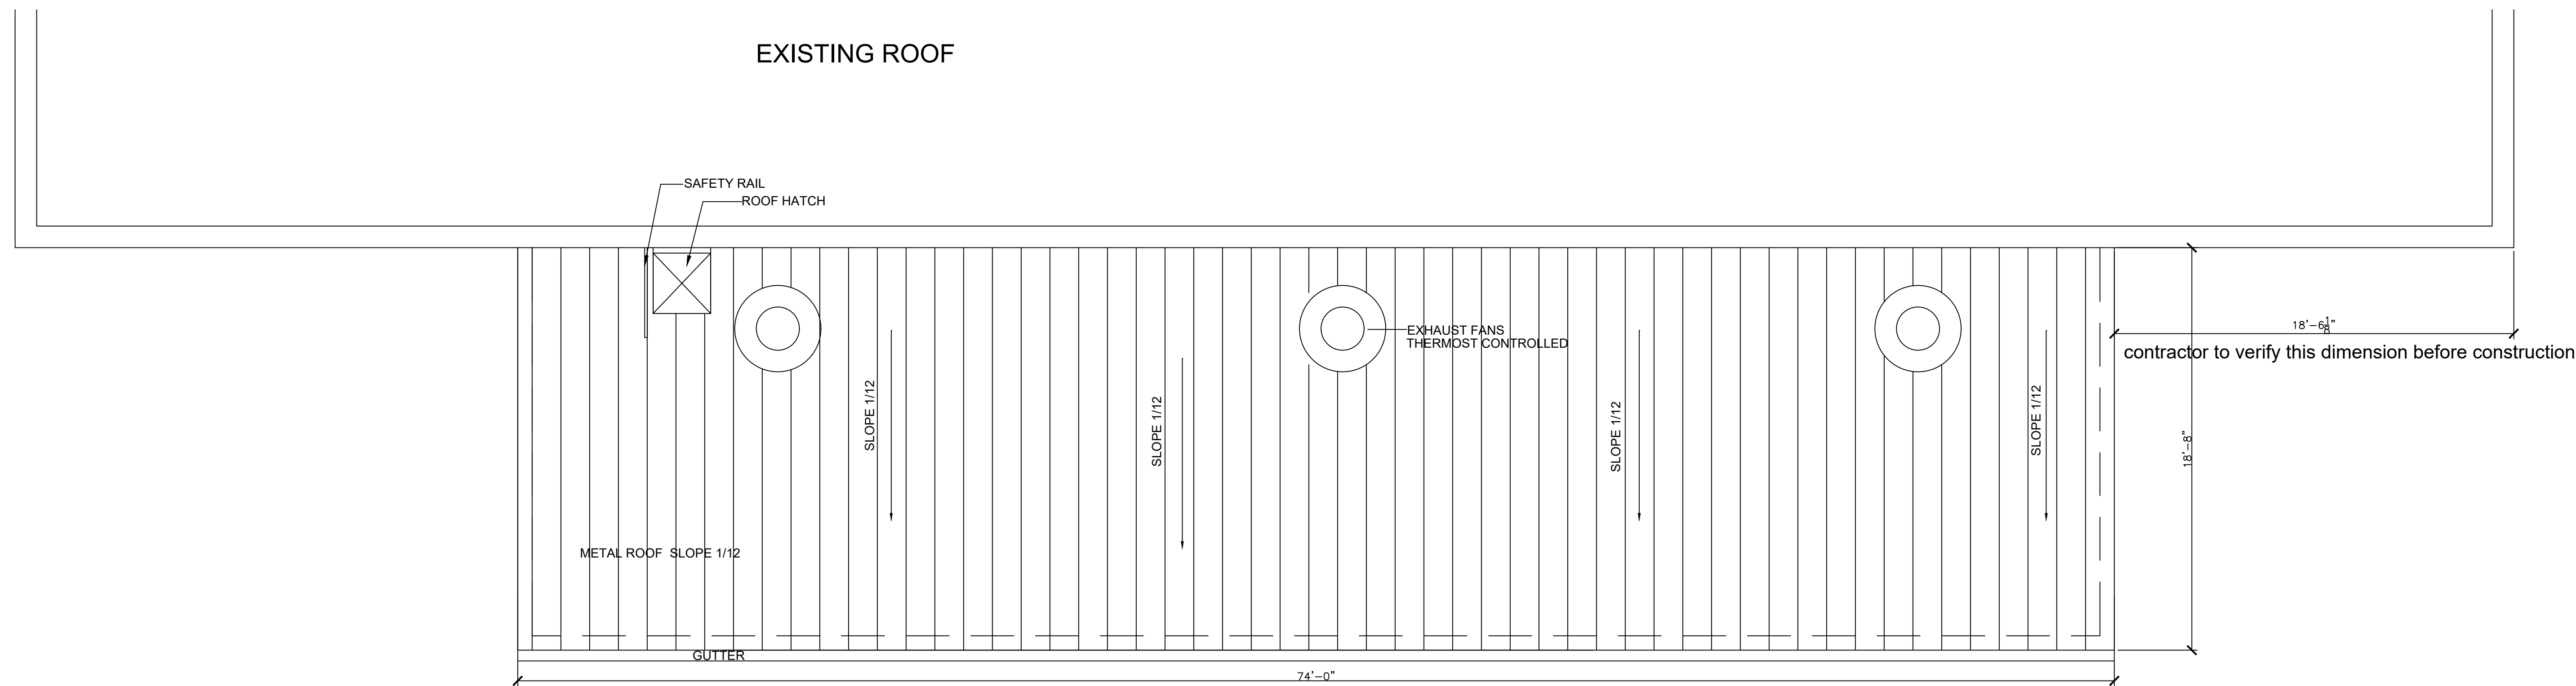


ROOF PLAN  
SCALE: 1/4"=1'-0"

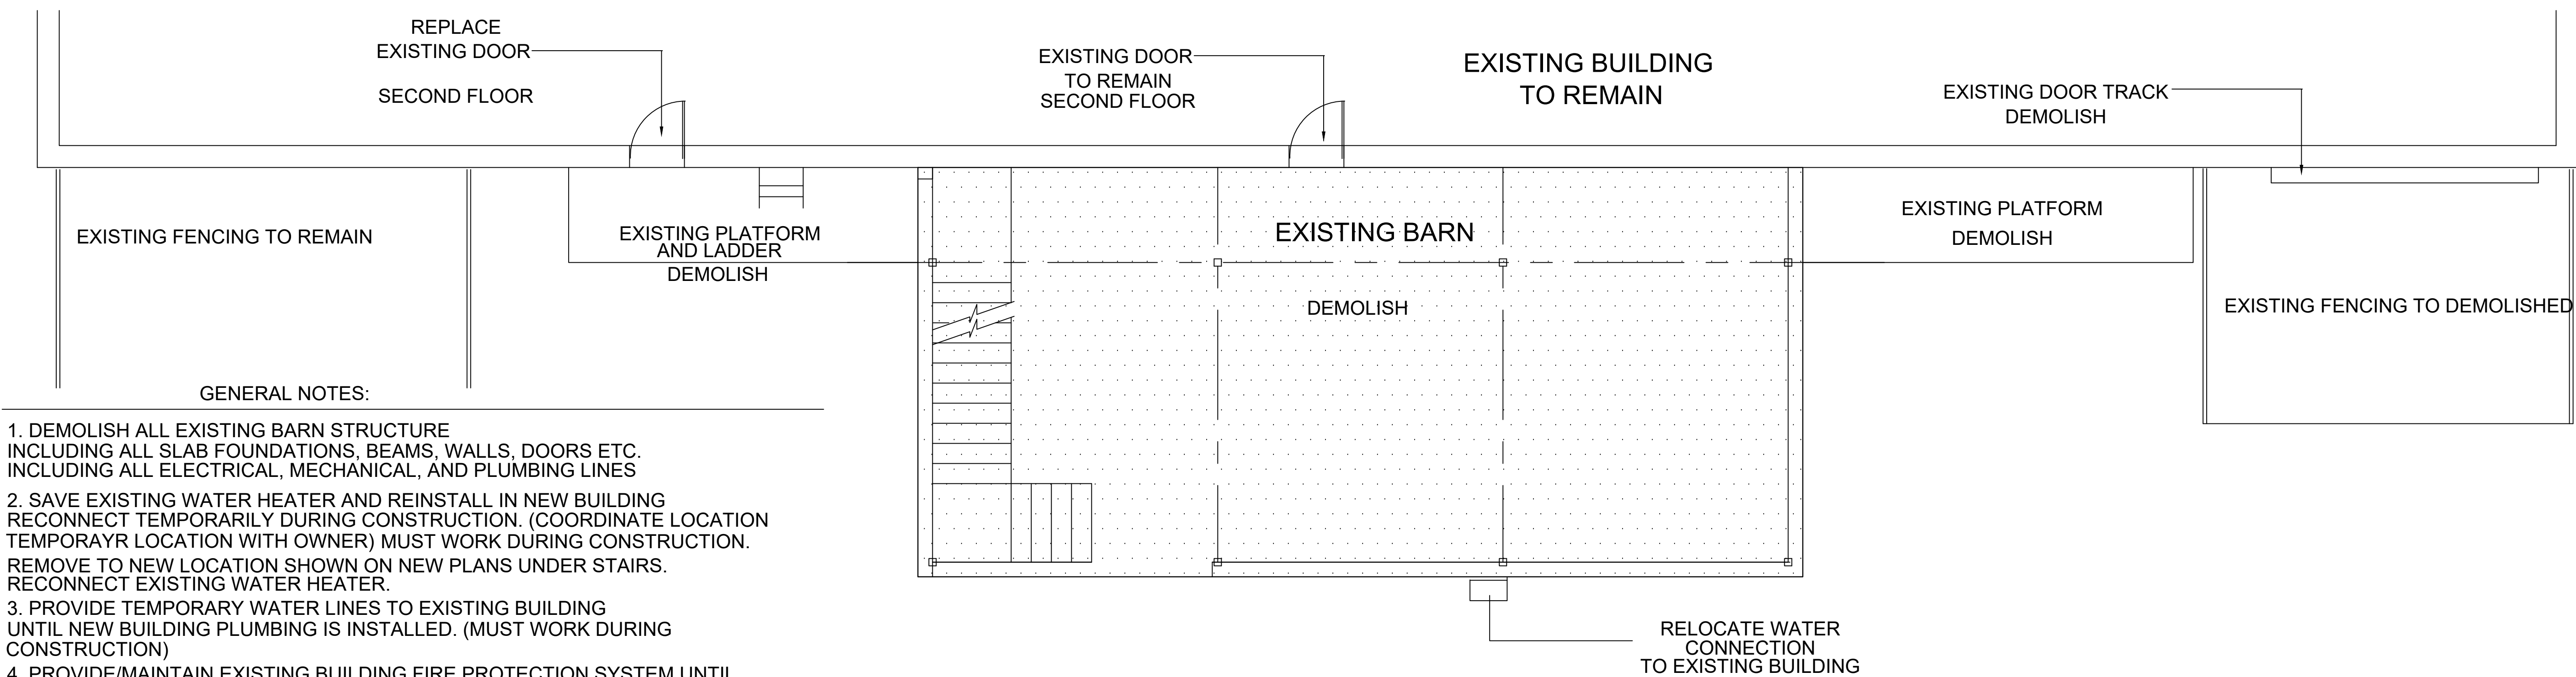

DEMOLITION PLAN  
SCALE: 1/4"=1'-0"

GENERAL NOTES:

1. DEMOLISH ALL EXISTING BARN STRUCTURE INCLUDING ALL SLAB FOUNDATIONS, BEAMS, WALLS, DOORS ETC. INCLUDING ALL ELECTRICAL, MECHANICAL, AND PLUMBING LINES
2. SAVE EXISTING WATER HEATER AND REINSTALL IN NEW BUILDING RECONNECT TEMPORARILY DURING CONSTRUCTION. (COORDINATE LOCATION TEMPORAYR LOCATION WITH OWNER) MUST WORK DURING CONSTRUCTION. REMOVE TO NEW LOCATION SHOWN ON NEW PLANS UNDER STAIRS. RECONNECT EXISTING WATER HEATER.
3. PROVIDE TEMPORARY WATER LINES TO EXISTING BUILDING UNTIL NEW BUILDING PLUMBING IS INSTALLED. (MUST WORK DURING CONSTRUCTION)
4. PROVIDE/MAINTAIN EXISTING BUILDING FIRE PROTECTION SYSTEM UNTIL NEW BUILDING FIRE PROTECTION SYSTEM IS INSTALLED IN BUILDING CONTRACTOR SHALL CONTRACT WITH EXISTING FIRE PROTECTION COMPANY FOR NEW UPGRADED SYSTEM AS REQUIRED PER CODE.
5. UTILIZE EXISTING FIRE ALARM EQUIPMENT TO PROVIDE COVERAGE OF NEW BUILDING PROVIDE ADDITIONAL EQUIPMENT EXTENDING SYSTEM AS REQUIRED BY CODE.
6. REMOVE EXISTING SECOND FLOOR PLATFORMS ON EACH SIDE OF BARN.
7. REMOVE EXISTING LADDER , PLATFORM, RAILS, COLUMN AND ALL ATTACHMENTS.
8. MAINTAIN POWER TO EXISTING BUILDING DURING AND AFTER CONSTRUCTION
9. REMOVE EXISTING FENCING AS REQUIRED FOR NEW CONSTRUCTION. TURN OVER TO OWNER.
10. CONTRACTOR SHALL PROVIDE CONSTRUCTION SAFETY FENCING AROUND CONSTRUCTION AREA. DURING CONSTRUCTION
11. CONTRACTOR SHALL VERIFY ALL DIMENSIONS INCLUDING FLOOR TO FLOOR HEIGHTS, OPENING CLEARANCES, LOCATIONS OF EXISTING BUILDING OPENINGS OR OBSTRUCTIONS, WATER LINES FIRE ALARM EQUIPMENT, ETC. BEFORE ANY CONSTRUCTION BEGINS.
12. CONTRACTOR SHALL WORK BETWEEN 9AM AND 4PM DURING REGULAR BUSINESS DAYS. ANY OTHER DAY OR TIME PERIODS SHALL BE REQUESTED 72 HOURS IN ADVANCE AND APPROVED BY OWNER.

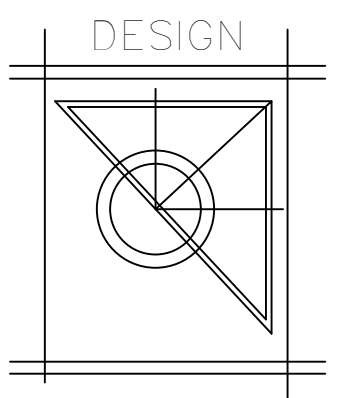


DESIGN

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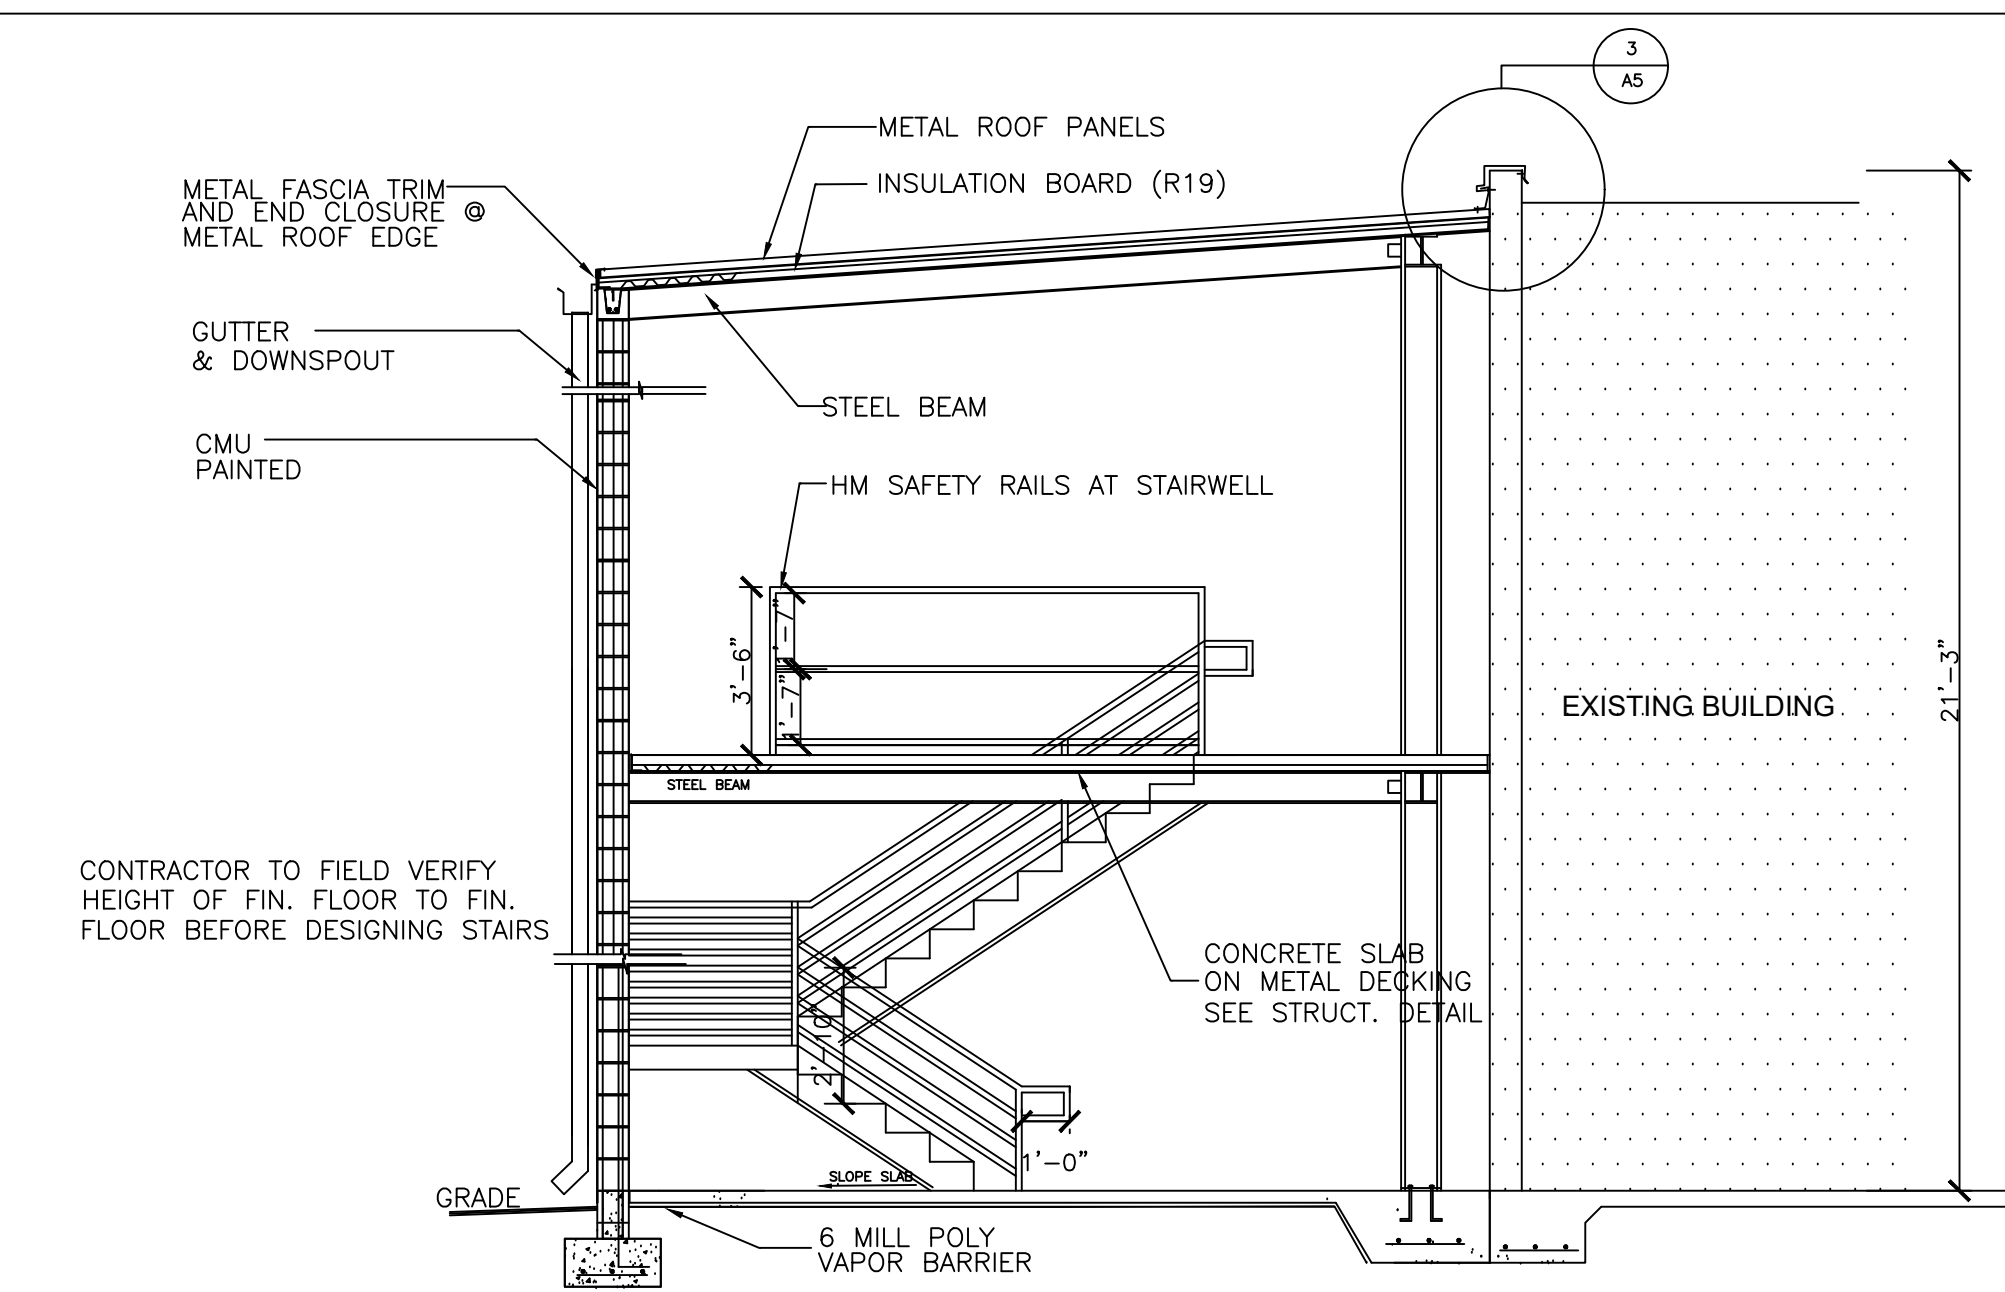
SEAL

RIVERBANKS ZOO - HAY BARN  
500 WILDLIFE PARKWAY  
COLUMBIA, SC


SHEET TITLE:  
DEMOLITION AND ROOF PLAN

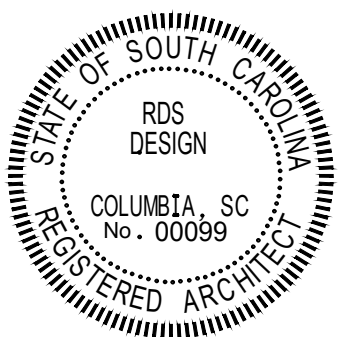DRAWN BY \_\_\_\_\_ RS  
DATE 3/01/22


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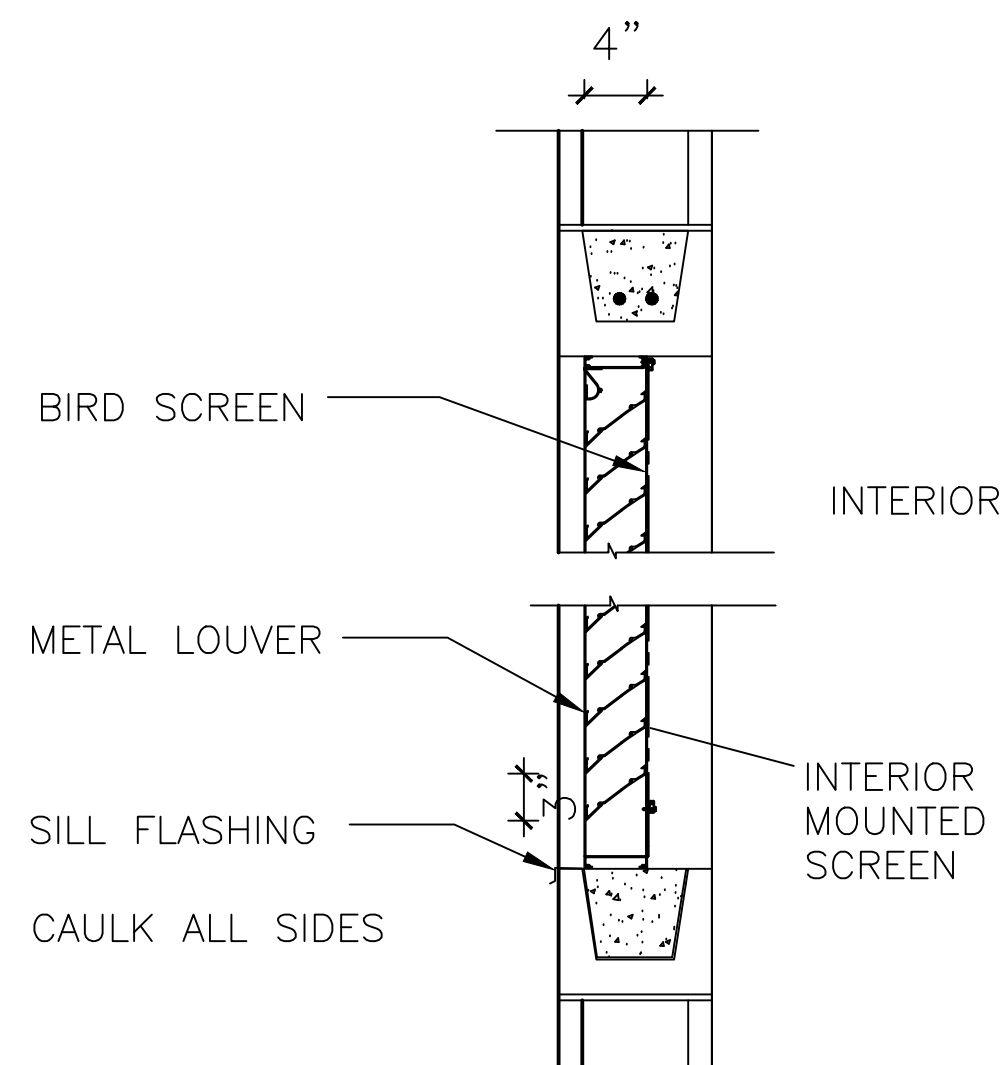
1 BUILDING SECTION  
SCALE: 1/4" = 1'-0"



2 TYPICAL EXTERIOR WALL SECTION  
SCALE: 3/4" = 1'-0"

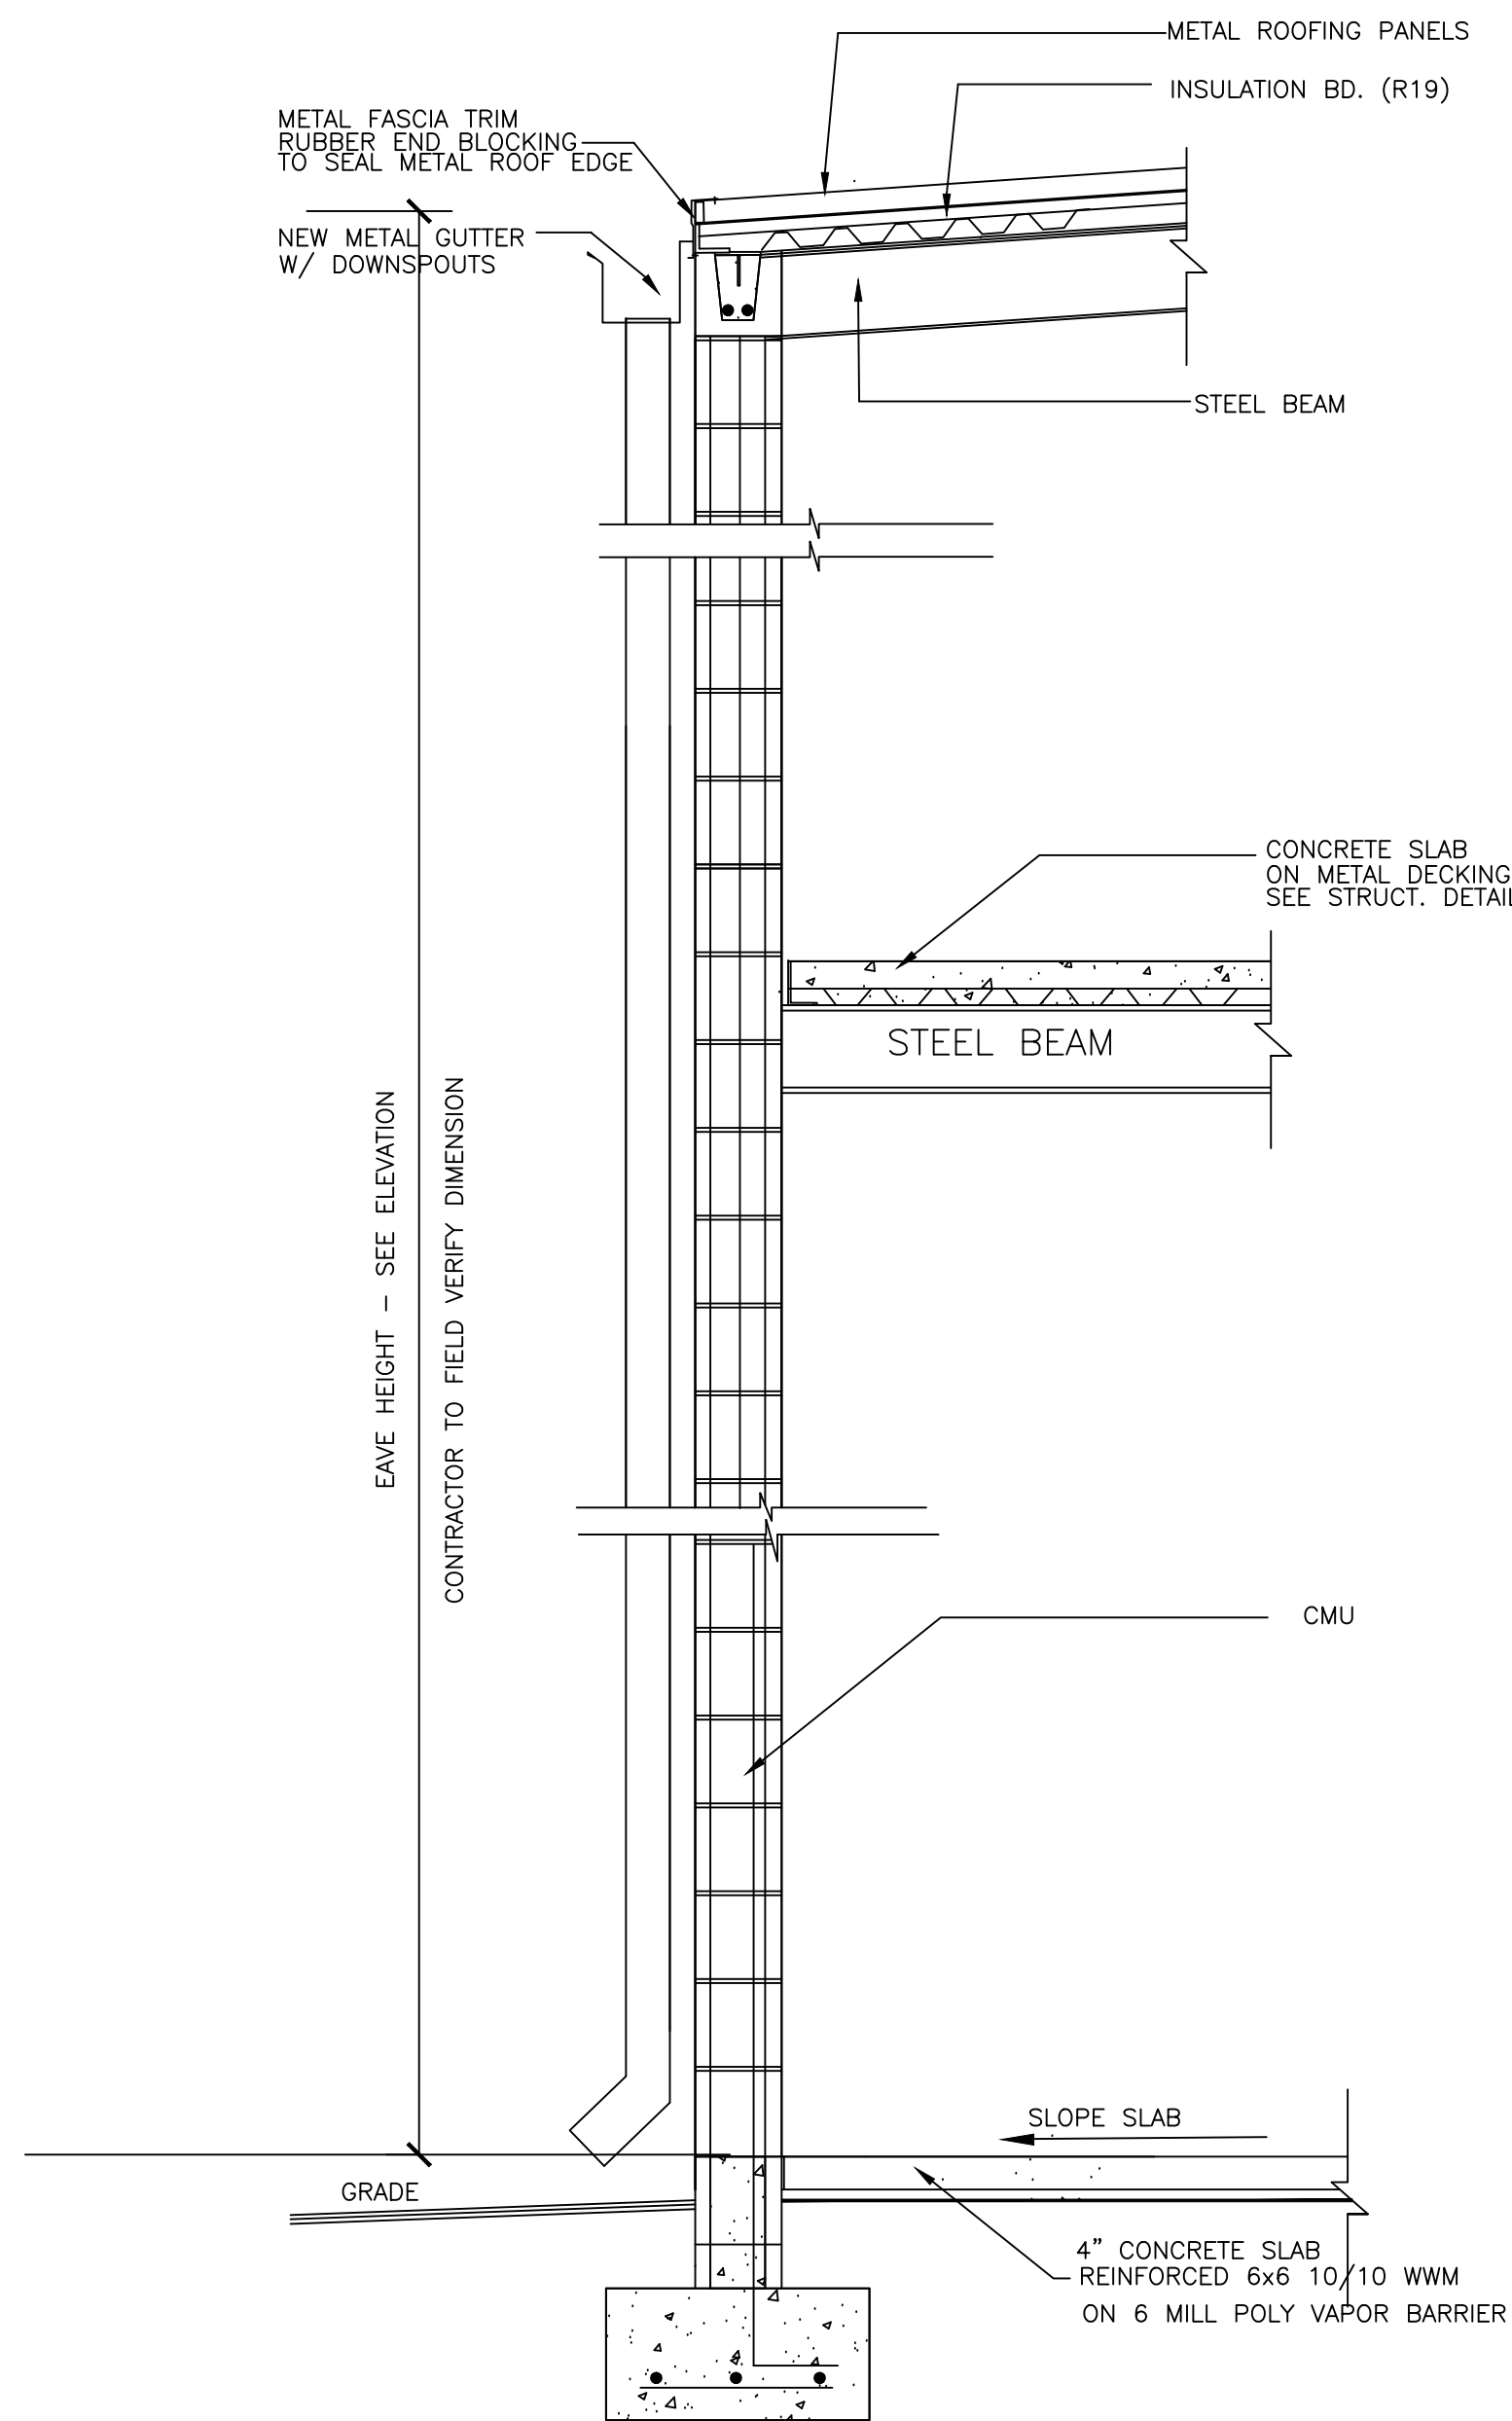


3 FLASHING DETAIL  
SCALE: NTS

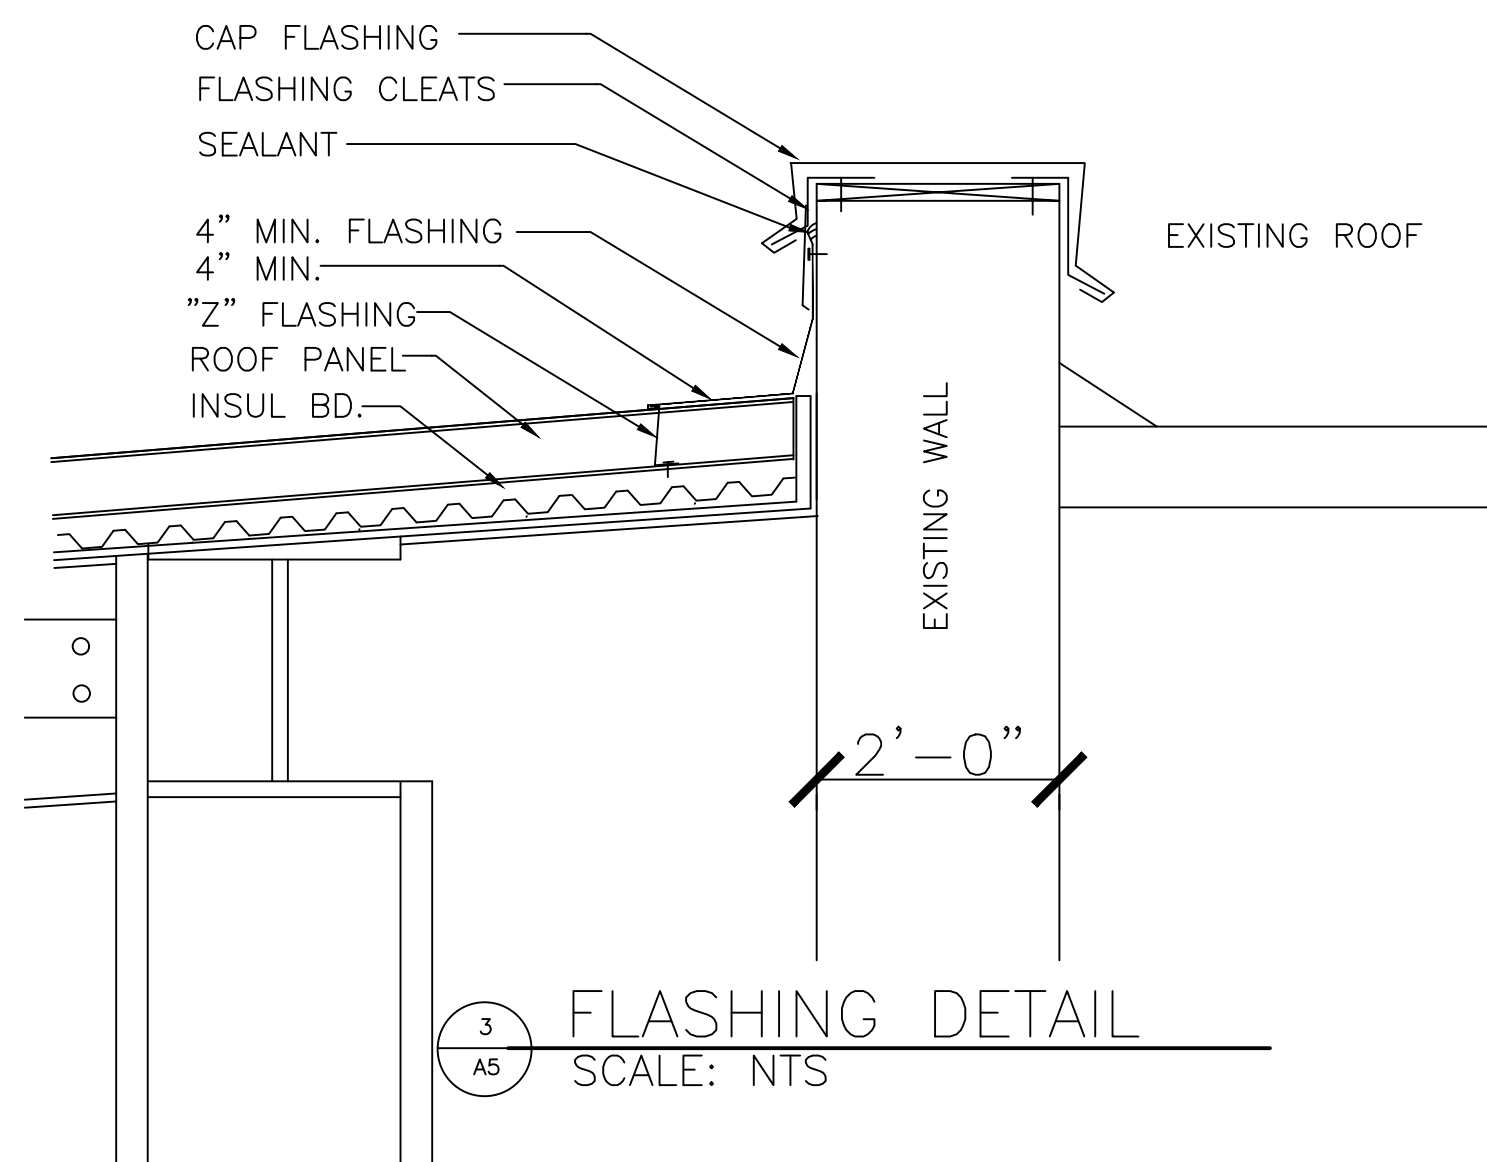


4 WALL LOUVER DETAIL  
SCALE: NTS

FINISH SCHEDULE						
	ROOM NAME	FLOOR	BASE	WALLS	CEILING	
				FINISH	FINISH	HEIGHT
	FIRST FLOOR	CONCRETE SEALED	-	CMU EPOXY PAINTED	-	-
	SECOND FLOOR	CONCRETE SEALED	-	CMU EPOXY PAINTED	-	OPEN

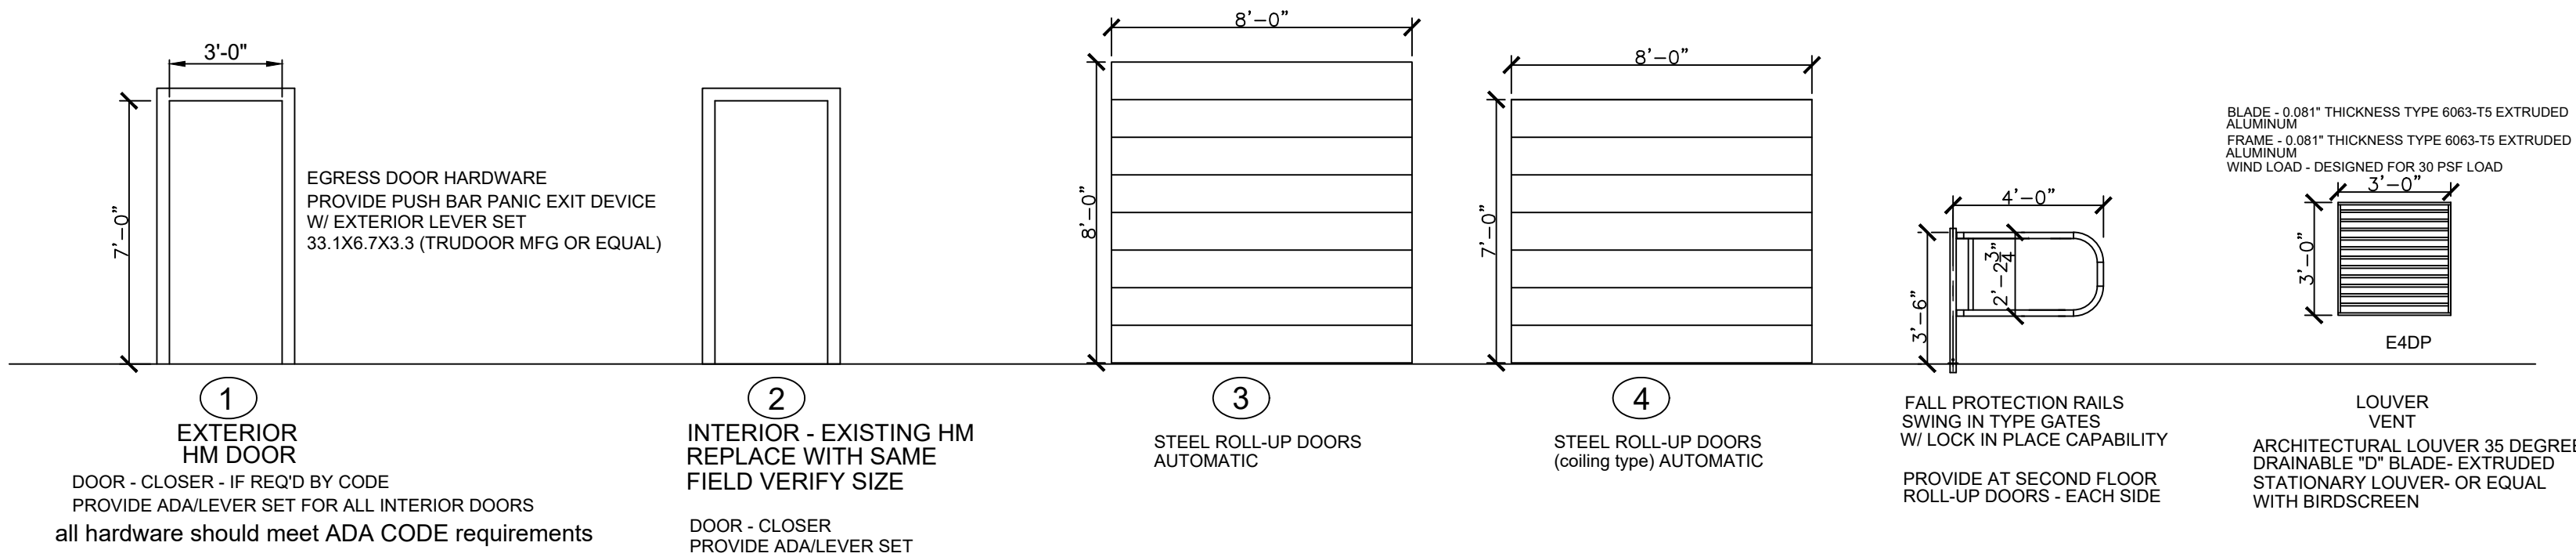

Door Elevations  
SCALE: 1/4" = 1'-0"

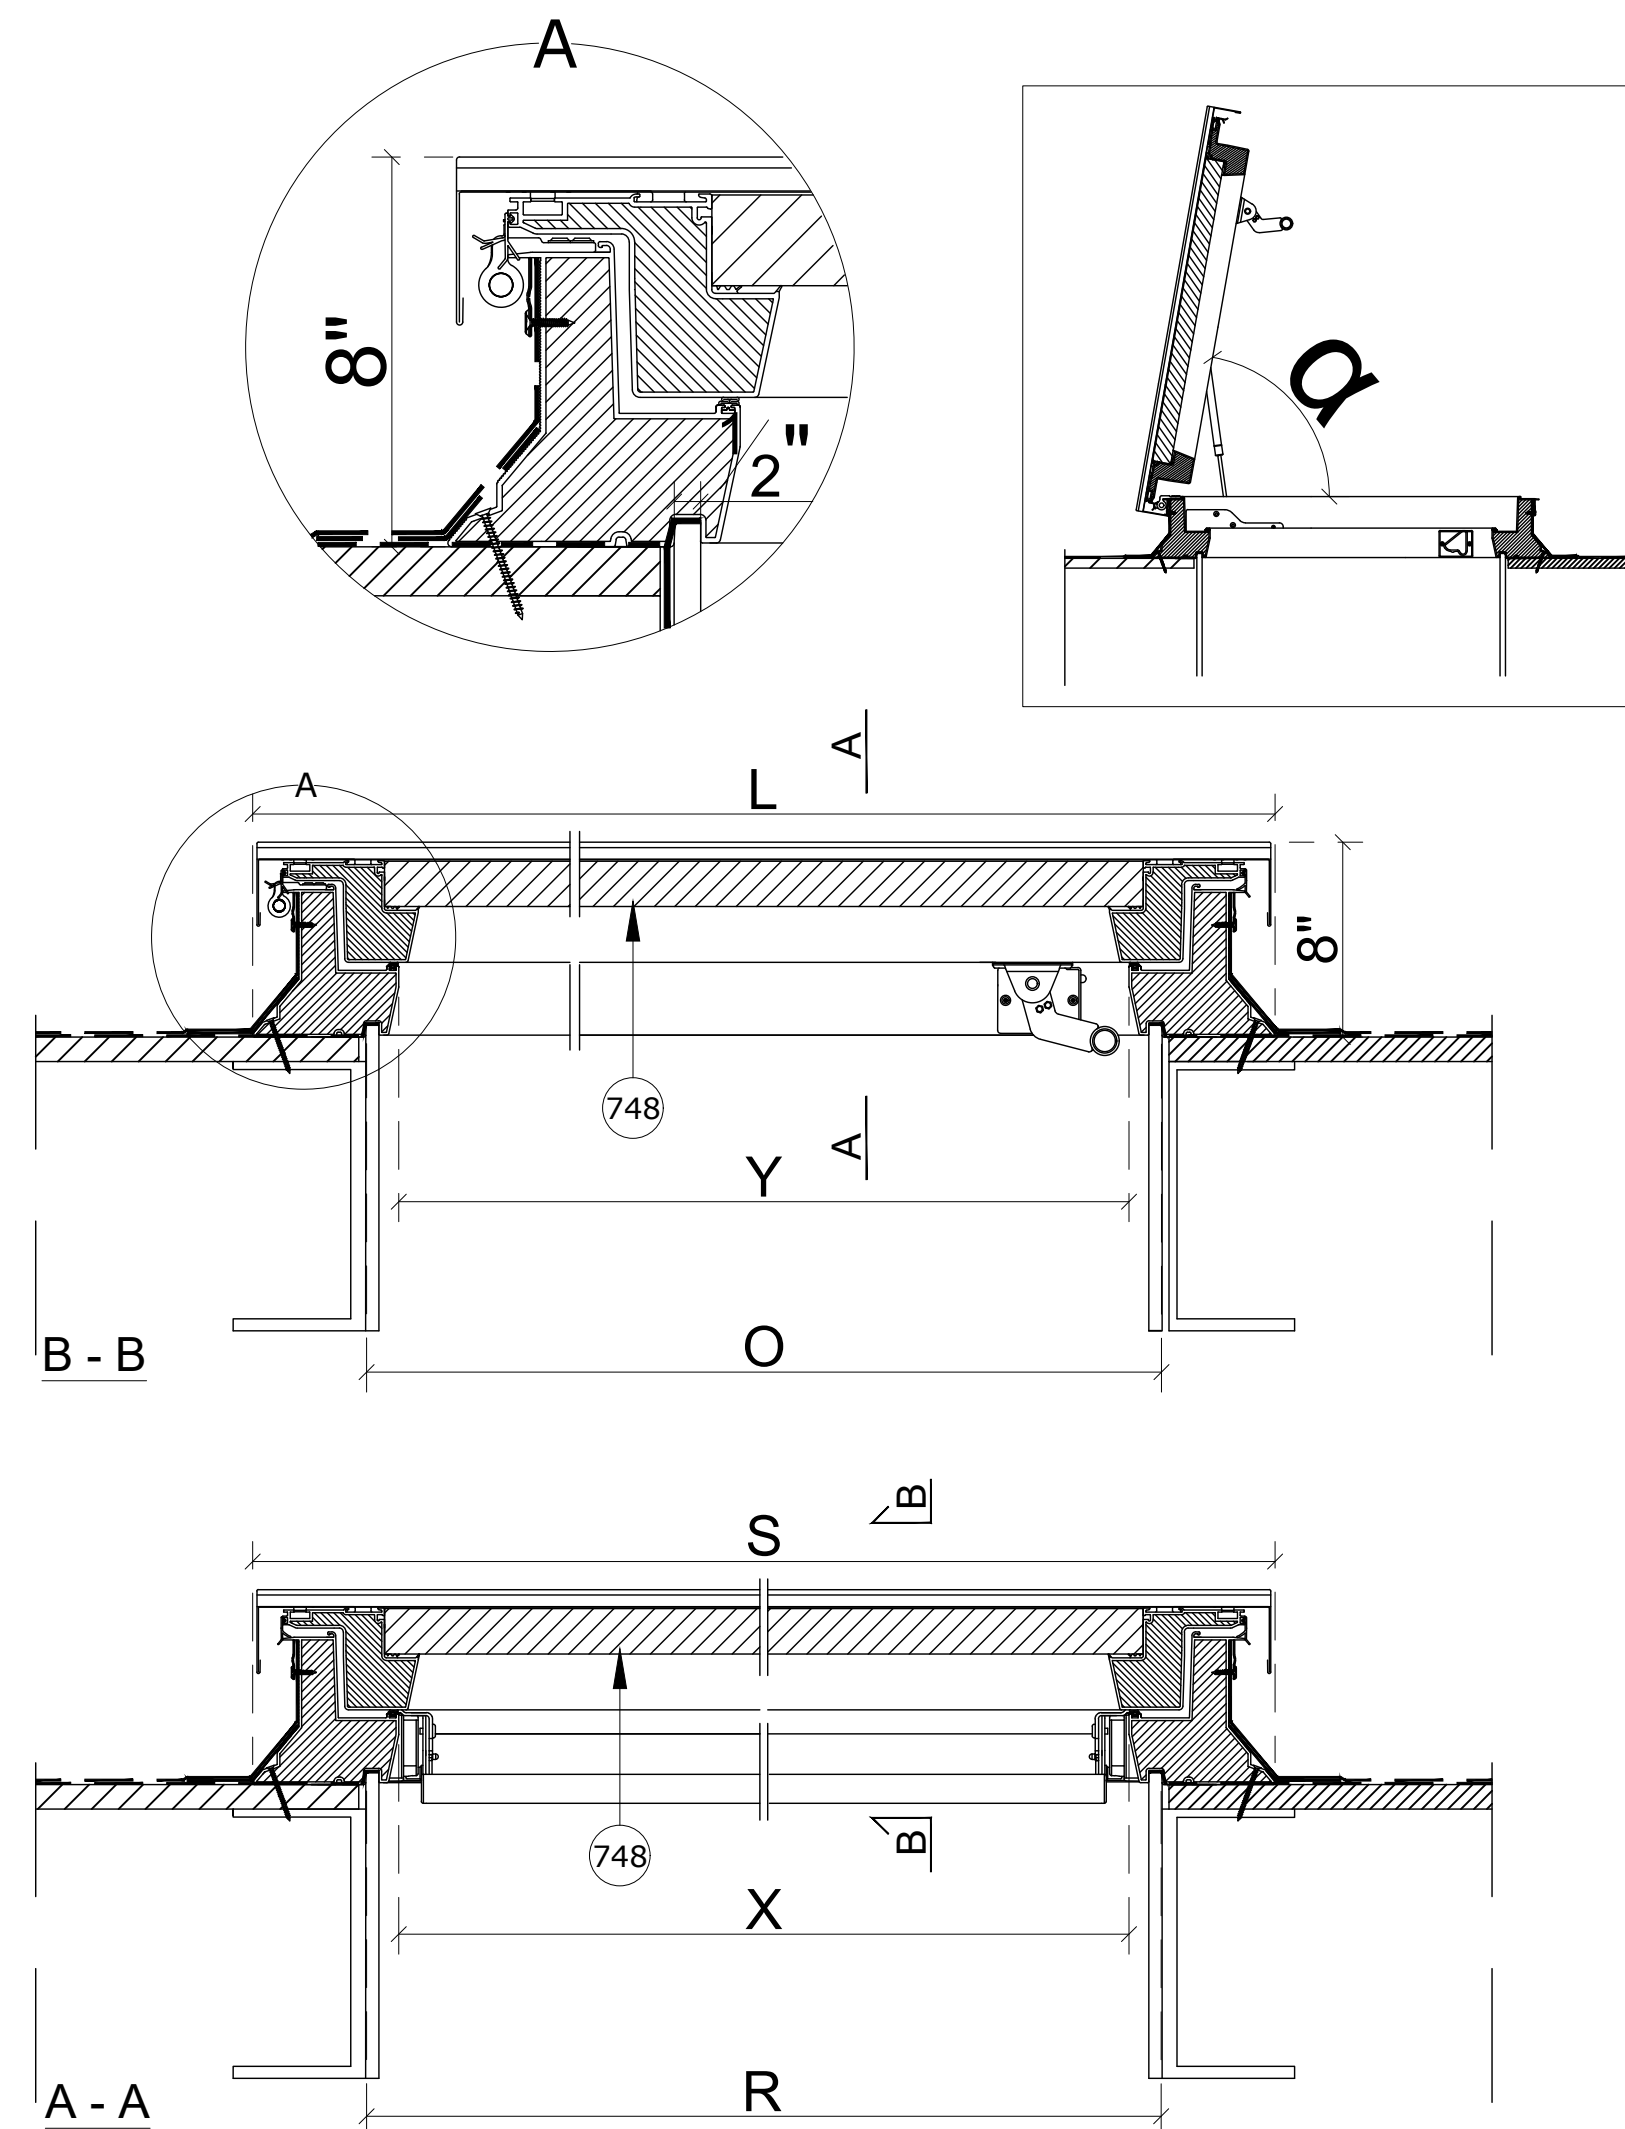


DRL	Rough opening		Outside frame		Max. clearance		a
	R[inch]	O[inch]	S[inch]	L[inch]	X[inch]	Y[inch]	
36"x36"	34 1/2"	34 1/2"	44 1/2"	44 1/2"	32 1/2"	32 1/2"	60"


Warning! The present drawing is for informational-demonstrative purposes only and as such cannot constitute a basis for performance. All dimensions presented in this drawing should be verified on site.

ROOF HATCH DETAIL  
SCALE: NTS


MFG DETAILS MAY VARY  
INSTALL PER MFG DETAILS.

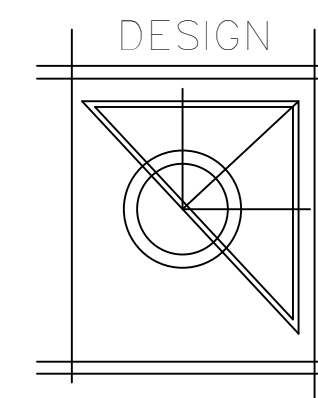

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RIVERBANKS ZOO - HAY BARN  
500 WILDLIFE PARKWAY  
COLUMBIA, SC  
SHEET TITLE:  
DETAILS

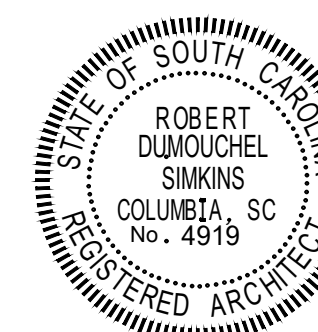DRAWN BY RS  
DATE 3/01/22

SHEET NO. OF  
A5

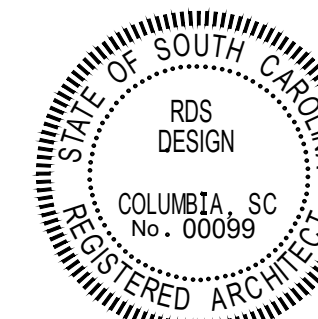SECTION 02361 - TERMITE CONTROL

PART 1 - GENERAL

1.1 RELATED DOCUMENTS

- A. Drawings and general provisions of the Contract, including General and Supplementary Conditions and Division 1 Specification Sections, apply to this Section.

1.2 SUMMARY

- A. This Section includes the following for termite control:

1. Soil treatment for new construction.

1.3 DEFINITIONS

- A. EPA: Environmental Protection Agency.
- B. PCO: Pest control operator.

1.4 SUBMITTALS

- A. Product Data: Treatments and application instructions, including EPA-Registered Label.
- B. Product Certificates: Signed by manufacturers of termite control products certifying that treatments furnished comply with requirements.
- C. Soil Treatment Application Report: After application of termiticide is completed, submit report for Owner's record information, including the following as applicable:
- Date and time of application.
  - Moisture content of soil before application.
  - Brand name and manufacturer of termiticide.
  - Quantity of undiluted termiticide used.
  - Dilutions, methods, volumes, and rates of application used.
  - Areas of application.
- D. Warranties: Special warranties specified in this Section.

1.5 QUALITY ASSURANCE

Applicator Qualifications: A PCO who is licensed according to regulations of authorities having jurisdiction to apply termite control treatment in jurisdiction where Project is located and

- A. who is experienced and has completed termite control treatment similar to that indicated for this Project and whose work has a record of successful in-service performance.
- B. Regulatory Requirements: Formulate and apply termiticides, and label with a Federal registration number, to comply with EPA regulations and authorities having jurisdiction.

1.2 PROJECT CONDITIONS

- A. Environmental Limitations: To ensure penetration, do not treat soil that is water saturated or frozen. Do not treat soil while precipitation is occurring. Comply with EPA-Registered Label requirements and requirements of authorities having jurisdiction.

1.3 COORDINATION

- A. Coordinate soil treatment application with excavating, filling, and grading and concreting operations. Treat soil under footings, grade beams, and ground-supported slabs, before construction.

1.4 WARRANTY

- A. General Warranty: Special warranty specified in this Article shall not deprive Owner of other rights Owner may have under other provisions of the Contract Documents and shall be in addition to, and run concurrent with, other warranties made by Contractor under requirements of the Contract Documents.
- B. Special Warranty: Written warranty, signed by applicator and Contractor certifying that termite control work, consisting of applied soil termiticide treatment, will prevent infestation of subterranean termites. If subterranean termite activity or damage is discovered during warranty period, re-treat soil and repair or replace damage caused by termite infestation.
- C. Warranty Period: Five years from date of Substantial Completion.

1.5 MAINTENANCE SERVICE

- A. Continuing Service: Provide a proposal for continuing service, including monitoring, inspection, and retreatment for occurrences of termite activity, from applicator to Owner, in the form of a standard yearly (or other period) continuing service agreement, starting on the date of Substantial Completion. State services, obligations, conditions, and terms for agreement period and for future renewal options.

PART 2 - PRODUCTS

2.1 SOIL TREATMENT

Termiticide: Provide an EPA-registered termiticide complying with requirements of authorities having jurisdiction, in a soluble or emulsible, concentrated formulation that dilutes with wate

- A. or foaming agent, and formulated to prevent termite infestation. Use only soil treatment solutions that are not harmful to plants. Provide quantity required for application at the label volume and rate for the maximum termiticide concentration allowed for each specific use, according to the product's EPA-Registered Label.
- B. Available Manufacturers: Subject to compliance with requirements, manufacturers offering products that may be incorporated into the Work include, but are not limited to, the following:
- AgriEvo Environmental Health, Inc.; a Company of Hoechst and Schering, Berlin.
  - American Cyanamid Co.; Agricultural Products Group, Specialty Products Department.
  - Bayer Corp.; Garden & Professional Care.
  - DowElanco.
  - FMC Corp.; Pest Control Specialties.

PART 2 - EXECUTION

2.1 EXAMINATION

- A. Examine substrates, areas, and conditions, with Applicator present, for compliance with requirements for moisture content of the soil, interfaces with earthwork, slab and foundation work, landscaping, and other conditions affecting performance of termite control. Proceed with application only after unsatisfactory conditions have been corrected.

2.2 PREPARATION

- A. General: Comply with the most stringent requirements of authorities having jurisdiction and with manufacturer's written instructions for preparing substrate. Remove all extraneous sources of wood cellulose and other edible materials such as wood debris, tree stumps and roots, stakes, formwork, and construction waste wood from soil and around foundations.
- B. Soil Treatment Preparation: Remove foreign matter and impermeable soil materials that could decrease treatment effectiveness on areas to be treated. Loosen, rake, and level soil to be treated, except previously compacted areas under slabs and footings. Termiticides may be applied before placing compacted fill under slabs if recommended by termiticide manufacturer.
- C. Fit filling hose connected to water source at the site with a backflow preventer, complying with requirements of authorities having jurisdiction.

2.3 APPLICATION, GENERAL


- A. General: Comply with the most stringent requirements of authorities having jurisdiction and with manufacturer's EPA-Registered Label for products.

2.4 APPLYING SOIL TREATMENT


Application: Mix soil treatment termiticide solution to a uniform consistency. Provide quantity required for application at the label volume and rate for the maximum specified concentration of

- A. termiticide, according to manufacturer's EPA-Registered Label, to the following so that a continuous horizontal and vertical termiticidal barrier or treated zone is established around and under building construction. Distribute the treatment evenly.
- Slabs-on-Grade: Under ground-supported slab construction, including footings, building slabs, and attached slabs as an overall treatment. For new construction treat soil materials before concrete footings and slabs are placed for existing construction drill holes in slabs as necessary to treat.
  - Foundations: Adjacent soil including soil along entire inside perimeter of foundation walls, along both sides of interior partition walls, around plumbing pipes and electric conduit penetrating slab, and around interior column footers, piers, and chimney bases; and along entire outside perimeter, from grade to bottom of footing. Avoid soil washout around footings.
  - Masonry: Treat voids.
  - Penetrations: At expansion joints, control joints, and areas where slabs will be penetrated.
- B. Avoid disturbance of treated soil after application. Keep off treated areas until completely dry.
- C. Protect termiticide solution, dispersed in treated soils and fills, from being diluted until ground-supported slabs are installed. Use waterproof barrier according to EPA-Registered Label instructions.
- D. Post warning signs in areas of application.
- E. Reapply soil treatment solution to areas disturbed by subsequent excavation, grading, landscaping, or other construction activities following application.

END OF SECTION 02361

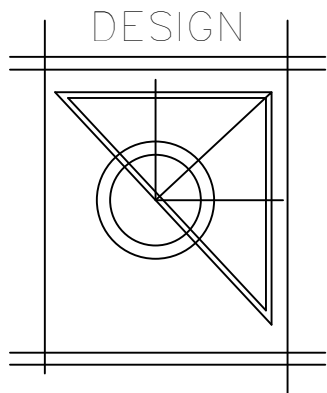


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3/01/22

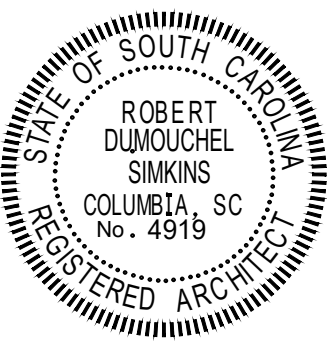Robert Simkins



SEAL

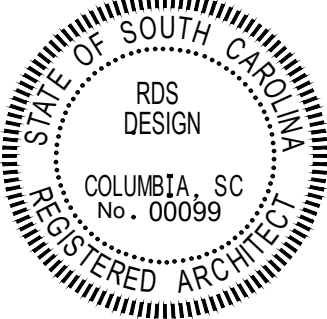RIVERBANKS ZOO – HAY BARN  
500 WILDLIFE PARKWAY  
COLUMBIA, SC

SHEET TITLE:  
SPECIFICATIONS

DRAWN BY \_\_\_\_\_RS\_\_\_\_\_  
DATE 3/01/22

SHEET NO.

OF

A6




SECTION 04810 - UNIT MASONRY ASSEMBLIES	
PART 1 - GENERAL	
1.1	RELATED DOCUMENTS
A.	Drawings and general provisions of the Contract, including General and Supplementary Conditions and Division 1 Specification Sections, apply to this Section.
1.2	SUMMARY
A.	This Section includes unit masonry assemblies consisting of the following: <div><div>1. Concrete masonry units.</div><div>2. Mortar and grout.</div><div>3. Reinforcing steel.</div><div>4. Masonry joint reinforcement.</div><div>5. Ties and anchors.</div><div>6. Embedded flashing.</div><div>7. Miscellaneous masonry accessories.</div></div>
B.	Related Sections include the following: <div><div>1. Division 7 Section "Sheet Metal Flashing and Trim" for exposed sheet metal flashing.</div></div>
C.	Products installed, but not furnished, under this Section include the following: <div><div>1. Steel lintels for unit masonry, furnished under Division 5 Section "Metal Fabrications."</div></div>
1.3	DEFINITIONS
A.	Reinforced Masonry: Masonry containing reinforcing steel in grouted cells.
1.4	PERFORMANCE REQUIREMENTS
A.	Provide unit masonry that develops the following net-area compressive strengths (f'm) at 28 days. Determine compressive strength of masonry from net-area compressive strengths of masonry units and mortar types according to Tables 1 and 2 in ACI 530.1/ASCE 6/TMS 602. <div><div>1. For Concrete Unit Masonry: f'm = 1500 psi (10.3 MPa).</div></div>
1.5	SUBMITTALS
A.	Product Data: For each different masonry unit, accessory, and other manufactured product
A.	Material Certificates: Signed by manufacturers certifying that each of the following items complies with requirements. <div><div>1. Each type of masonry unit required.<div><div>a. Include size-variation data for CMU, verifying that actual range of sizes falls within specified tolerances.</div><div>b. Include test data, measurements, and calculations establishing net-area compressive strength of masonry units.</div></div></div></div>
1.2	QUALITY ASSURANCE
A.	Source Limitations for Masonry Units: Obtain exposed masonry units of a uniform texture and color, or a uniform blend within the ranges accepted for these characteristics, through one source from a single manufacturer for each product required.
B.	Source Limitations for Mortar Materials: Obtain mortar ingredients of a uniform quality, including color for exposed masonry, from one manufacturer for each cementitious component and from one source or producer for each aggregate.
C.	Fire-Resistance Ratings: Where indicated, provide materials and construction identical to those of assemblies with fire-resistance ratings determined per ASTM E 119 by a testing and inspecting agency, by equivalent concrete masonry thickness, or by another means, as acceptable to authorities having jurisdiction.
1.3	DELIVERY, STORAGE, AND HANDLING
A.	Store masonry units on elevated platforms in a dry location. If units are not stored in an enclosed location, cover tops and sides of stacks with waterproof sheeting, securely tied. If units become wet, do not install until they are dry.
B.	Store cementitious materials on elevated platforms, under cover, and in a dry location. Do not use cementitious materials that have become damp.
C.	Store aggregates where grading and other required characteristics can be maintained and contamination avoided.
D.	Deliver preblended, dry mortar mix in moisture-resistant containers designed for lifting and emptying into dispensing silo. Store preblended, dry mortar mix in delivery containers on elevated platforms, under cover, and in a dry location or in a metal dispensing silo with weatherproof cover.
E.	Store masonry accessories, including metal items, to prevent corrosion and accumulation of dirt and oil.
PART 1 - PRODUCTS	
1.1	CONCRETE MASONRY UNITS
A.	General: Provide shapes indicated and as follows: <div><div>1. Provide special shapes for lintels, 90° corners and 135° corners, jambs, sash, control joints, headers, bonding, and other special conditions.</div></div>
B.	Concrete Masonry Units: ASTM C 90: <div><div>1. Unit Compressive Strength: Provide units with minimum average net-area compressive strength of 1900 psi (13.1 MPa).</div><div>2. Weight Classification: Normal weight, unless otherwise indicated.</div><div>3. Provide Type II, non-moisture-controlled units.</div><div>4. Size (Width): Manufactured to the following dimensions:<div><div>a. 8 inches (203 mm) nominal; 7-5/8 inches (194 mm) actual.</div></div></div><div>5. Exposed Faces: Manufacturer's standard color and texture, unless otherwise indicated.<div><div>a. Cinder units are not acceptable.</div></div></div></div>
1.2	MORTAR AND GROUT MATERIALS
A.	Portland Cement: ASTM C 150, Type I or II, except Type III may be used for cold-weather construction. Provide natural color or white cement as required to produce mortar color selected by the Architect.
B.	Hydrated Lime: ASTM C 207, Type S.
C.	Portland Cement-Lime Mix: Packaged blend of portland cement complying with ASTM C 150, Type I or Type III, and hydrated lime complying with ASTM C 207.
D.	Mortar Cement: ASTM C 1329.
E.	Masonry Cement: ASTM C 91. <div><div>1. Use a colored cement formulation as required to produce a color as selected by Architect. More than one color may be required.<div><div>a. Pigments shall not exceed 10 percent of portland cement by weight for mineral oxides nor 2 percent for carbon black.</div></div></div></div>

A.	Mortar Pigments: Natural and synthetic iron oxides and chromium oxides, compounded for use in mortar mixes. Use only pigments with a record of satisfactory performance in masonry mortar.
B.	Cold-Weather Admixture: Non-chloride, noncorrosive, accelerating admixture complying with ASTM C 494, Type C, and recommended by the manufacturer for use in masonry mortar of composition indicated.
C.	Water: Potable.
1.2	REINFORCING STEEL
A.	Uncoated Steel Reinforcing Bars: ASTM A 615/A 615M; ASTM A 616/A 616M, including Supplement 1; or ASTM A 617/A 617M, Grade 60 (Grade 400).
1.3	MASONRY JOINT REINFORCEMENT
A.	General: ASTM A 951 and as follows: <div><div>1. Hot-dip galvanized, carbon-steel wire for both interior and exterior walls.</div><div>2. Wire Size for Side Rods: W2.8 or 0.188-inch (4.8-mm) diameter.</div><div>3. Wire Size for Cross Rods: W2.8 or 0.188-inch (4.8-mm) diameter.</div><div>4. Provide in lengths of not less than 10 feet (3 m), with prefabricated corner and tee units.</div></div>
B.	For single-wythe masonry, provide either ladder type with single pair of side rods and cross rods spaced 16 inches (407 mm) o.c.
1.4	TIES AND ANCHORS, GENERAL
A.	General: Provide ties and anchors, specified in subsequent articles, made from materials that comply with this Article, unless otherwise indicated.
B.	Hot-Dip Galvanized Carbon-Steel Wire: ASTM A 82; with ASTM A 153, Class B-2 coating.
C.	Galvanized Steel Sheet: ASTM A 653/A 653M, G60 (Z180), commercial-quality, steel sheet zinc coated by hot-dip process on continuous lines before fabrication.
D.	Steel Sheet, Galvanized after Fabrication: ASTM A 366/A 366M cold-rolled, carbon-steel sheet hot-dip galvanized after fabrication to comply with ASTM A 153.
E.	Steel Plates, Shapes, and Bars: ASTM A 36/A 36M.
1.5	EMBEDDED FLASHING MATERIALS
A.	Concealed Flashing: For flashing not exposed to the exterior, use the following, unless otherwise indicated: <div><div>1. Copper-Laminated Flashing: Manufacturer's standard laminated flashing consisting of 5-oz./sq. ft. (1.5-kg/sq. m) sheet copper bonded with asphalt between 2 layers of glass-fiber cloth. Use only where flashing is fully concealed in masonry.</div></div>
B.	Adhesives, Primers, and Seam Tapes for Flashings: Flashing manufacturer's standard products or products recommended by the flashing manufacturer for bonding flashing sheets to each other and to substrates.
C.	Available Products: Subject to compliance with requirements, products that may be incorporated into the Work include, but are not limited to, the following: <div><div>1. Copper-Laminated Flashing:<div><div>a. Copper Fabric Flashing: Advanced Building Products, Inc.</div><div>b. Copper Fabric: AFCO Products, Inc.</div><div>c. H &amp; B C-Fab Flashing: Hohmann &amp; Barnard, Inc.</div><div>d. Type FCC-Fabric Covered Copper: Phoenix Building Products.</div><div>e. Copper Fabric Flashing: Polyrite Manufacturing Corp.</div><div>f. Copper Fabric Flashing: Sandell Manufacturing Co., Inc.</div><div>g. York Copper Fabric Flashing: York Manufacturing, Inc.</div></div></div></div>
1.2	MISCELLANEOUS MASONRY ACCESSORIES
A.	Preformed Control-Joint Gaskets: Material as indicated below, designed to fit standard sash block and to maintain lateral stability in masonry wall, size and configuration as indicated. <div><div>1. Styrene-Butadiene-Rubber Compound: ASTM D 2000, Designation M2AA-805.</div><div>2. PVC: ASTM D 2287, Type PVC-65406.</div></div>
1.3	MASONRY CLEANERS
A.	Cleaner: Masonry Manufacturer's recommended cleaner designed for removing mortar/grout stains, efflorescence, and other new construction stains from new masonry without discoloring or damaging masonry surfaces. Use product expressly approved for intended use by cleaner manufacturer and manufacturer of masonry units being cleaned.
1.4	MORTAR AND GROUT MIXES
A.	General: Do not use admixtures, including pigments, air-entraining agents, accelerators, retarders, water-repellent agents, antifreeze compounds, or other admixtures, unless otherwise indicated. <div><div>1. Do not use calcium chloride in mortar or grout.</div><div>2. Add cold-weather admixture (if used) at the same rate for all mortar, regardless of weather conditions, to ensure that mortar color is consistent.</div></div>
B.	Preblended, Dry Mortar Mix: Furnish dry mortar ingredients in the form of a preblended mix. Measure quantities by weight to ensure accurate proportions, and thoroughly blend ingredients before delivering to Project site.
B.	Mortar for Unit Masonry: Comply with ASTM C 270, Proportion Specification.
C.	Grout for Unit Masonry: Comply with ASTM C 476. <div><div>1. Use grout of type indicated or, if not otherwise indicated, of type (fine or coarse) that will comply with Table 5 of ACI 530.1/ASCE 6/TMS 602 for dimensions of grout spaces and pour height.</div><div>2. Provide grout with a slump of 8 to 11 inches (200 to 280 mm) as measured according to ASTM C 143.</div></div>
PART 2 - EXECUTION	
2.1	EXAMINATION
A.	Examine conditions, with Installer present, for compliance with requirements for installation tolerances and other conditions affecting performance. <div><div>1. For the record, prepare written report, endorsed by Installer, listing conditions detrimental to performance.</div><div>2. Verify that foundations are within tolerances specified.</div><div>3. Verify that reinforcing dowels are properly placed.</div><div>4. Proceed with installation only after unsatisfactory conditions have been corrected.</div></div>
B.	Before installation, examine rough-in and built-in construction to verify actual locations of piping connections.
2.2	INSTALLATION, GENERAL
A.	Thickness: Build cavity and composite walls and other masonry construction to the full thickness shown. Build single-wythe walls to the actual widths of masonry units, using units of widths indicated.

widths indicated.	
B.	Build chases and recesses to accommodate items specified in this Section and in other Sections of the Specifications.
C.	Leave openings for equipment to be installed before completing masonry. After installing equipment, complete masonry to match the construction immediately adjacent to the opening. Cut masonry units with motor-driven saws to provide clean, sharp, unchipped edges. Cut units as required to provide a continuous pattern and to fit adjoining construction. Where possible, use full-size units without cutting. Allow units cut with water-cooled saws to dry before <div><div>A. placing, unless wetting of units is specified. Install cut units with cut surfaces and, where possible, cut edges concealed.</div></div>
B.	Select and arrange units for exposed unit masonry to produce a uniform blend of colors and textures. <div><div>1. Mix units from several pallets or cubes as they are placed.</div></div>
1.2	CONSTRUCTION TOLERANCES
A.	Comply with tolerances in ACI 530.1/ASCE 6/TMS 602 and the following:
B.	For conspicuous vertical lines, such as external corners, door jambs, reveals, and expansion and control joints, do not vary from plumb by more than 1/4 inch in 20 feet (6 mm in 6 m), nor 1/2 inch (12 mm) maximum.
C.	For vertical alignment of exposed head joints, do not vary from plumb by more than 1/4 inch in 10 feet (6 mm in 3 m), nor 1/2 inch (12 mm) maximum.
D.	For conspicuous horizontal lines, such as exposed lintels, sills, parapets, and reveals, do not vary from level by more than 1/4 inch in 20 feet (6 mm in 6 m), nor 1/2 inch (12 mm) maximum.
E.	For exposed bed joints, do not vary from thickness indicated by more than plus or minus 1/8 inch (3 mm), with a maximum thickness limited to 1/2 inch (12 mm). Do not vary from bed-joint thickness of adjacent courses by more than 1/8 inch (3 mm).
F.	For exposed head joints, do not vary from thickness indicated by more than plus or minus 1/8 inch (3 mm). Do not vary from adjacent bed-joint and head-joint thicknesses by more than 1/8 inch (3 mm).
1.3	LAYING MASONRY WALLS
A.	Lay out walls in advance for accurate spacing of surface bond patterns with uniform joint thicknesses and for accurate location of openings, movement-type joints, returns, and offsets. Avoid using less-than-half-size units, particularly at corners, jambs, and, where possible, at other locations.
B.	Bond Pattern for Exposed Masonry: Lay exposed masonry in the following bond pattern; do not use units with less than nominal 4-inch (100-mm) horizontal face dimensions at corners or jambs. <div><div>1. One-half running bond with vertical joint in each course centered on units in courses above and below, unless otherwise indicated on drawings.</div></div>
C.	Lay concealed masonry with all units in a wythe in running bond or bonded by lapping not less than 2 inches (50 mm). Bond and interlock each course of each wythe at corners. Do not use units with less than nominal 4-inch (100-mm) horizontal face dimensions at corners or jambs.
A.	Stopping and Resuming Work: In each course, rack back one-half-unit length for one-half running bond or one-third-unit length for one-third running bond; do not tooth. Clean exposed surfaces of set masonry, wet clay masonry units lightly if required, and remove loose masonry units and mortar before laying fresh masonry.
B.	Built-in Work: As construction progresses, build in items specified under this and other Sections of the Specifications. Fill in solidly with masonry around built-in items.
C.	Fill space between hollow-metal frames and masonry solidly with mortar, unless otherwise indicated.
D.	Where built-in items are to be embedded in cores of hollow masonry units, place a layer of metal lath in the joint below and rod mortar or grout into core.
E.	Fill cores in hollow concrete masonry units with grout 24 inches (600 mm) under bearing plates, beams, lintels, posts, and similar items, unless otherwise indicated.
F.	Build non-load-bearing interior partitions full height of story to underside of solid floor or roof structure above, unless otherwise indicated. <div><div>1. Install compressible filler in joint between top of partition and underside of structure above.</div><div>2. At fire-rated partitions, install firestopping in joint between top of partition and underside of structure above to comply with Division 7 Section "Firestopping."</div></div>
1.2	MORTAR BEDDING AND JOINTING
A.	Lay hollow masonry units as follows: <div><div>1. With full mortar coverage on horizontal and vertical face shells.</div><div>2. Bed webs in mortar in starting course on footings and in all courses of piers, columns, and pilasters, and where adjacent to cells or cavities to be filled with grout.</div><div>3. For starting course on footings where cells are not grouted, spread out full mortar bed, including areas under cells.</div></div>
B.	Set precast concrete trim units in full bed of mortar with vertical joints slushed full. Fill dowel, anchor, and similar holes solid. Wet joint surface thoroughly before setting; for soiled precast surfaces, clean bedding and exposed surfaces with fiber brush and soap powder and rinse thoroughly with clear water.
C.	Tool exposed joints slightly concave when thumbprint hard, using a jointer larger than the joint thickness, unless otherwise indicated. <div><div>1.</div></div>
1.1	MASONRY JOINT REINFORCEMENT
A.	General: Provide continuous masonry joint reinforcement as indicated. Install entire length of longitudinal side rods in mortar with a minimum cover of 5/8 inch (16 mm) on exterior side of walls, 1/2 inch (13 mm) elsewhere. Lap reinforcement a minimum of 6 inches (150 mm). <div><div>1. Space reinforcement not more than 16 inches (406 mm) o.c.</div><div>2. Space reinforcement not more than 8 inches (203 mm) o.c. in foundation walls and parapet walls.</div><div>3. Provide reinforcement not more than 8 inches (203 mm) above and below wall openings and extending 12 inches (305 mm) beyond openings.<div><div>a. Reinforcement above is in addition to continuous reinforcement.</div></div></div></div>
B.	Cut or interrupt joint reinforcement at control and expansion joints, unless otherwise indicated.
C.	Provide continuity at corners and wall intersections by using prefabricated "L," and "T" sections. Cut and bend reinforcing units as directed by manufacturer for continuity at returns, offsets, column fireproofing, pipe enclosures, and other special conditions.

1.2	ANCHORING MASONRY TO STRUCTURAL MEMBERS
A.	Anchor masonry to structural members where masonry abuts or faces structural members to comply with the following: <div><div>1. Provide an open space not less than 1 inch (25 mm) in width between masonry and structural member, unless otherwise indicated. Keep open space free of mortar or other rigid materials.</div><div>2. Anchor masonry to structural members with flexible anchors embedded in masonry joints and attached to structure.</div><div>3. Space anchors as indicated, but not more than 24 inches (610 mm) o.c. vertically and 36 inches (915 mm) o.c. horizontally.</div></div>
1.3	CONTROL AND EXPANSION JOINTS
A.	General: Install control and expansion joints in unit masonry where indicated. Build-in related items as masonry progresses. Do not form a continuous span through movement joints unless provisions are made to prevent in-plane restraint of wall or partition movement.
B.	Form control joints in concrete masonry as follows: <div><div>1. Install preformed control-joint gaskets designed to fit standard sash block.</div></div>
1.4	LINTELS
A.	Install steel lintels where indicated or required by notes on drawings.
A.	Provide masonry lintels where shown and where openings of more than 12 inches (305 mm) for brick-size units and 24 inches (610 mm) for block-size units are shown without structural steel or other supporting lintels. <div><div>1. Provide prefabricated or built-in-place masonry lintels. Use specially formed bond beam units with reinforcing bars placed as indicated and filled with coarse grout. Cure precast lintels before handling and installing. Temporarily support built-in-place lintels until cured.</div></div>
B.	Provide minimum bearing of 8 inches (200 mm) at each jamb, unless otherwise indicated.
1.2	FLASHING, WEEP HOLES, AND VENTS
A.	General: Install embedded flashing and weep holes in masonry at shelf angles, lintels, ledges, other obstructions to downward flow of water in wall, and where indicated.
B.	Prepare masonry surfaces so they are smooth and free from projections that could puncture flashing. Unless otherwise indicated, place through-wall flashing on sloping bed of mortar and cover with mortar. Before covering with mortar, seal penetrations in flashing with adhesive, sealant, or tape as recommended by flashing manufacturer.
C.	Install flashing as follows: <div><div>1. At multiwythe masonry walls, including cavity walls, extend flashing from exterior face of outer wythe of masonry, through outer wythe, turned up a minimum of 8 inches (200 mm), and through inner wythe to within 1/2 inch (13 mm) of the interior face of the wall in exposed masonry.</div><div>2. At lintels and shelf angles, extend flashing a minimum of 4 inches (100 mm) into masonry at each end. At heads and sills, extend flashing 4 inches (100 mm) at ends and turn flashing up not less than 2 inches (50 mm) to form a pan.</div><div>3. Cut flashing off flush with face of wall after masonry wall construction is completed.</div></div>
D.	Install weep holes in the head joints in exterior wythes of the first course of masonry immediately above embedded flashing and as follows: <div><div>1. Use wicking material to form weep holes.</div><div>2. Space weep holes 24 inches o.c.</div></div>
E.	Trim wicking material used in weep holes flush with outside face of wall after mortar has set.
1.3	REINFORCED UNIT MASONRY INSTALLATION
A.	Temporary Formwork and Shores: Construct formwork and shores to support reinforced masonry elements during construction. <div><div>1. Construct formwork to conform to shape, line, and dimensions shown. Make it sufficiently tight to prevent leakage of mortar and grout. Brace, tie, and support forms to maintain position and shape during construction and curing of reinforced masonry.</div><div>1. Do not remove forms and shores until reinforced masonry members have hardened sufficiently to carry their own weight and other temporary loads that may be placed on them during construction.</div></div>
B.	Placing Reinforcement: Comply with requirements of ACI 530.1/ASCE 6/TMS 602.
C.	Grouting: Do not place grout until entire height of masonry to be grouted has attained sufficient strength to resist grout pressure. <div><div>1. Comply with requirements of ACI 530.1/ASCE 6/TMS 602 for cleanouts and for grout placement, including minimum grout space and maximum pour height.</div></div>
1.2	REPAIRING, POINTING, AND CLEANING
A.	Remove and replace masonry units that are loose, chipped, broken, stained, or otherwise damaged or that do not match adjoining units. Install new units to match adjoining units; install in fresh mortar, pointed to eliminate evidence of replacement.
B.	Pointing: During the tooling of joints, enlarge voids and holes, except weep holes, and completely fill with mortar. Point up joints, including corners, openings, and adjacent construction, to provide a neat, uniform appearance. Prepare joints for sealant application.
C.	In-Progress Cleaning: Clean unit masonry as work progresses by dry brushing to remove mortar fins and smears before tooling joints.
D.	Final Cleaning: After mortar is thoroughly set and cured, clean exposed masonry as follows: <div><div>1. Remove large mortar particles by hand with wooden paddles and nonmetallic scrape hoses or chisels.</div><div>2. Test cleaning methods on sample wall panel; leave one-half of panel uncleaned for comparison purposes. Obtain Architect's approval of sample cleaning before proceeding with cleaning of masonry.</div><div>3. Protect adjacent stone and non-masonry surfaces from contact with cleaner by covering them with liquid strippable masking agent, polyethylene film, or waterproof masking tape.</div><div>4. Clean masonry with a proprietary cleaner approved and applied according to masonry manufacturer's written instructions.</div></div>
1.3	MASONRY WASTE DISPOSAL
A.	Recycling: Unless otherwise indicated, excess masonry materials are Contractor's property. At completion of unit masonry work, remove from Project site.
END OF SECTION 04810	

DESIGN

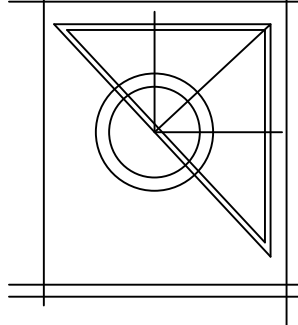

RDS DESIGN, LLC  
ARCHITECTURE  
821 KINLOCK CT.  
COLUMBIA, SOUTH CAROLINA 29223  
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STATE OF SOUTH CAROLINA  
ROBERT DIMOUCHEL  
SIMKINS  
COLUMBIA, SC  
No. 4919  
REGISTERED ARCHITECT

3/01/22  
*Robert Simkins*

STATE OF SOUTH CAROLINA  
RDS  
DESIGN  
COLUMBIA, SC  
No. 00089  
REGISTERED ARCHITECT

SEAL

RIVERBANKS ZOO – HAY BARN  
500 WILDLIFE PARKWAY  
COLUMBIA, SC  
SHEET TITLE: SPECIFICATIONS

DRAWN BY \_\_\_\_\_RS\_\_\_\_\_  
DATE 3/01/22

SHEET NO. OF  
A7



SECTION 07 72 33

ROOF HATCHES

PART 1 – GENERAL

1.1 SUMMARY

PRODUCT: ROOF ACCESS HATCH, 36" WIDE x 36" LONG OPENING, COLOR TO MATCH ROOF PANELS –14 GAUGE GALVANIZED STEEL COVER, FRAME & SELF FLASHING BASE.MADE IN USA BABCOCK–DAVIS.

FEATURES:  
FINISH: GLOSSY FINISH HIGH REFLECTANCE BRITE POLYESTER FINISH

CONSTRUCTION: 14 GUAGE GALVANIZED STEEL COVER, FRAME AND CURB WITH 12" HIGH CURB AND 3–1/2" WIDE FLANGE FOR SECURING TO ROOF DECK.  
COVER: 14 GUAGE GALVANIZED STEEL WITH TPE RUBBER DRAFT SEAL GASKET DOOR SEAL. ONE INCH THICK INSULATION LINER IS BUILT INTO THE COVER. INSIDE LINER IS 22 GUAGE GALVANIZED STEEL.  
CURB: 14 GUAGE GALVANIZED STEEL 12" HIGH CURB WITH 3–1/2" WIDE FLANGE.  
LOAD/DEFLECTION: ROOF HATCH COVERS HAVE BEEN TESTED AND APPROVED TO SUPPORT A MIN. LIVE LOAD OF 40 lbs./ft2 WITH A MAX. DEFLECTION OF 1/150TH OF THE SPAN, MAX. NEGATIVE LOAD OF 50 lbs./ft2 WIND UPFIT, AND 110 MPH WIND LOAD WHEN COVER IS IN AN OPEN POSITION.  
INSULATION: THE CURB INCLUDES A 1" FIBERBOARD INSULATION SURROUNDING THE BASE, AND 1" INSULATION BETWEEN THE EXTERIOR COVER AND LINER.  
HARDWARE: HARDWARE SHALL INCLUDE CORROSION RESISTANT HEAVY–DUTY HINGE, SLAM LATCH, HEAVY GAGE AUTOMATIC HOLD OPEN ARM WITH RED GRIP, COMPRESSION SPRING–OPERATED CYLINDERS, EXTERIOR HANDLE WITH INTERNAL PADLOCK HASP, AND INTERIOR LOCKING HANDLE WITH INTERIOR PADLOCK HASP.  
OPTIONS:  
HARDWARE: STAINLESS STEEL HARDWARE KIT (OUTSIDE COMPONENTS INCLUDING HINGE, LATCH/LOCK HASP, CERTAIN INSIDE ITEMS)

DIVISION 23 3470 ROOF EXHAUST FAN

GENERAL

1.1 SUMMARY

PRODUCT: ROOF EXHAUST FANS – DAYTON – ROOF EXHAUST FAN 18 1/2" WHEEL DIRECT DRIVE STAINLESS STEEL WITH AUTOMATIC AND CONTROLLABLE SPEED WITH DIRECT DRIVE. MODEL NUMBER 65D657, SPECS– 115V/208V, AC/230V AC, 1/2 HP 30"x30", 2994 CFM.

PROVIDE ALL CURBS, ATTACHMENT, ELECTRICAL AND STRUCTURAL SUPPORT AS REQUIRED BY MFG. PROVIDE ALL FLASHING AND INSTALLATION REQUIREMENTS BY MFG.  
OTHER MFG. MAY BE CONSIDERED BY ARCHITECT FOR AS EQUAL PRODUCT.  
CONTRACTOR SHALL PURCHASE AND INSTALL ROOF FANS WITH ALL NECESSARY ITEMS FOR A COMPLETE WORKING OPERABLE CONDITION.  
CONTRACTOR TO PROVIDE 1 YEAR WARRANTY ON PRODUCT AND INSTALLATION.

DIVISION 07100 RIGID BOARD ROOF INSULATION

GENERAL

1. ARCHITECTURAL METAL ROOFING SYSTEM INSULATION BOARD

MANUFACTURER – OWENS CORNING OR EQUAL  
TYPE: FOAMULAR? THERMAPINK? XPS RIGID INSULATION

RIGID INSULATION WITH R–value of 5 per inch. PROVIDE R–19 FOR ROOF APPLICATION

PRODUCT: THERMAPINK? insulation layers with sealed joints under roofing systems. Provide THERMAPINK? 25 insulation with 25 psi compressive strength. provide insulation board that has a moderate perm ratings and high with, long–lasting R–value.

DIVISION 07400 ROOFING – METAL

GENERAL

1.1 SUMMARY

PRODUCT: PETERSON PAC–CLAD 150, 90 DEGREE SINGLE LOCK SYSTEM OR EQUAL

A. FEATURES: 24 GA SMOOTH PANEL TYPE THAT IS MECHANICALLY FASTENED WITH A SINGLE LOCK SYSTEM.

B. WARRANTY: PROVIDE 30 YEAR FINISH WARRANTY, AND WEATHERTIGHTNESS WARRANTY.

C. PAINT FINISH – STANDARD COLORS AS SELECTED BY OWNER.  
KINAR 500 FINISH.

D. PROVIDE ALL FLASHING AND INSTALLATION REQUIREMENTS BY MFG.  
PROVIDE 24 GA ROOF FINISH TRIM PIECES TO MATCH ROOF AT EAVES AND RAKE OF ROOF TO MATCH ROOF FINISH COLOR, PROVIDE WEATHERTIGHTNESS TRIM AT ALL WALL TO ROOF INTERSECTIONS. EAVE GUTTERS AND DOWN SPOUTS SHALL BE PROVIDED BY CONTRACTOR. CLOSURE STRIPS SHALL BE PROVIDED AT EAVE AND RAKE CONDITIONS.

E. ROOF FASTENERS – ALL ROOF FASTENERS SHALL HAVE A ZINC COATED ALUMINUM CAST HEAD WITH A NEPOPRENE SEALING WASHER FOR WEATHERTIGHTNESS.

F. ROOF INSULATION BOARD – PROVIDE RIGID INSULATION BOARD WITH A MINIMUM TO MEET IBC 2018 BUILDING CODE REQUIREMENTS.

DIVISION 08100 DOORS – METAL

GENERAL

DOOR SPECIFICATIONS:

1–3/4" THICK STEEL DOORS SHALL BE MFG. BY CECO DOOR PRODUCTS OR EQUAL. DOORS SHALL CONFORM TO THE STEEL DOOR INSTITUTE GUIDE SPECIFICATIONS, ANSI A250.8.

REGENT DOORS ARE MADE FULL–FLUSH OR (OPTIONAL) SEAMLESS STYLE. FACE SHEETS ARE COMMERCIAL QUALITY COLD ROLLED STEEL CONFORMING TO ASTM A1008 OR (OPTIONAL) HOT–DIPPED GALVANIZED STEEL CONFORMING TO ASTM A924 AND A653

REGENT FULL–FLUSH DOORS HAVE MECHANICALLY INTERLOCKED, HEMMED, HAIRLINES ON VERTICAL EDGES AND HAVE NO VISIBLE SEAMS ON FACES. DOORS SPECIFIED "SEAMLESS" HAVE NO VISIBLE SEAMS ON FACES OR VERTICAL EDGES

14 GAGE DOORS WITH OIB=NE PIECE, KRAFT HONEYCOMB CORE SECURLY BONDED TO BOTH FACE PLATES.

HARDWARE PROVISIONS: HINGE PREPARATIONS ARE HANDED. HINGE EDGES ARE MORTISED FOR 4–1/2" OR 5" HIGH, HEAVY WEIGHT HINGES. 7 GAGA STEEL HINGE REINFORCEMENTS ARE WELDED INSIDE THE DOOR EDGE AND ARE DRILLED AND TAPPED FOR FASTENERS IN ACCORDANCE WITH ANSI A156.7. THE LOCK EDGE HAS A STANDARD BEVEL (1:16) AND IS PREPARED FOR HARDWARE

PAINT: 1–3/4" STEEL DOORS SHALL BE PROVIDED WITH ONE COAT OF OVEN–CURED NEUTRAL COLOR PRIMER PAINT. PRIMER COAT SHALL CONFORM WITH ANSI A250.10. THE PRIMER COAT IS A PREPARATORY BASE FOR NECESSARY FINISH PAINTING.

"COLORSTYLE" FINISH COAT IS ALSO AVAILABLE FROM A SELECTION OF STANDARD COLORS. COLORSTYLE FINISH IS ELECTROSTATICALLY APPLIED, OVEN–CURED URETHANE ENAMEL, AND SHALL CONFORM TO ANSI A250.3. FOR ACCURATE COLOR SELECTORS FOR A CECO COLORSTYLE CHART.

DOOR HARDWARE:

RIM EXIT DEVICE 4700 SERIES OR EQUAL. COMMERCIAL HEAVY DUTY TYPE.

"BEST", – ADA LEVER LOCK SET STAINLESS EXTERIOR TYPE.

Ventilator:  
B. Wall Louvers: type -blade design, same finish as adjacent material, with steel mesh bird screen and frame, blank sheet metal at unused portions. Louvers shall be designed by their manufacturer to meet the wind load provisions as specified in Section 1.4H. See drawings

Architectural Louvers - http://www.archlouvers.com - phone: 888-568-8371  
*Specifier Note: Fill in all highlighted areas or delete as necessary to meet your requirements.*  
SECTION 08 90 00 - LOUVERS AND VENTS

GENERAL

SUMMARY  
A. Section Includes:  
1. Fixed, extruded-aluminum wall louvers.  
2. Wall vents (brick vents).  
B. See Division 8 Section "Steel Doors and Frames" for louvers in hollow-metal doors.  
C. See Division 8 Section "Flush Wood Doors" for louvers in flush wood doors.  
D. See Division 15 Sections for louvers that are a part of mechanical equipment.

PERFORMANCE REQUIREMENTS  
E. Design: Design louvers, including comprehensive engineering analysis by a qualified engineer, using structural performance requirements and design criteria indicated.  
F. Structural Performance: Louvers shall withstand the effects of gravity loads and the following loads and stresses within limits and under conditions indicated without permanent deformation of louver components, noise or metal fatigue caused by louver blade rattle or flutter, or permanent damage to fasteners and anchors.  
1. Wind Loads: Determine loads based on a uniform pressure of 30 lb./sq. ft. (1435 Pa), acting inward or outward.  
G. Louver Performance Ratings: Provide louvers complying with requirements specified, as demonstrated by testing manufacturer's stock units identical to those provided, except for length and width according to AMCA 500-L.

SUBMITTALS  
H. Product Data: For each type of product indicated.  
1. For louvers specified to bear AMCA seal, include printed catalog pages showing specified models with appropriate AMCA Certified Ratings Seals.  
A. Shop Drawings: For louvers and accessories. Include plane, elevations, sections, details, and attachments to other work. Show frame profiles and blade profiles, angles, and spacing.  
B. Samples: For each type of metal finish required.  
C. Submittal: For louvers indicated to comply with structural performance requirements and design criteria indicated.  
D. Product Test Reports: Based on tests performed according to AMCA 500-L.

PRODUCTS

MATERIALS  
E. Aluminum Extrusions: ASTM B 221M, Alloy 6063-T5.  
F. Aluminum Sheet: ASTM B 209M, Alloy 3003 with temper as required for forming.  
G. Fasteners: Use types and sizes to suit unit installation conditions.  
1. For fastening aluminum, use aluminum or 300 series stainless-steel fasteners.

FABRICATION, GENERAL  
H. Fabricate frames, including integral sills, to fit in openings of sizes indicated, with allowances made for fabrication and installation tolerances, adjoining material tolerances, and perimeter sealant joints.  
I. Join frame members to each other and to fixed louver blades with fillet welds concealed from view welds, threaded fasteners, or both, as standard with louver manufacturer unless otherwise indicated or size of louver assembly makes bolted connections between frame members necessary.

FIXED, EXTRUDED-ALUMINUM LOUVERS  
J. Horizontal High Performance Drainable-Blade Louver <Insert louver type, e.g., L1>:  
1. Basis-of-Design Product: Architectural Louvers Co. (Harray, LLC); Model E4DP. Subject to compliance with requirements, provide the specified product or comparable product by one of the following:  
a. Manufacturers of equivalent products submitted and approved in accordance with Section 01630 - Product Substitution Procedures.  
2. Louver Depth: 4 inches (100 mm)  
1. Frame and Blade Nominal Thickness: Not less than 0.080 inch (2.03 mm) for blades and frames.  
2. Louver Performance Ratings:  
a. Free Area: Not less than 8.0 sq. ft. (0.74 sq. m) for 48-inch- (1220-mm-) wide by 48-inch- (1220-mm-) high louver.  
b. Point of Beginning Water Penetration: Not less than 925 fpm (4.7 m/s).  
c. Air Performance: Not more than 0.10-inch wg (25-Pa) static pressure drop at 800 fpm (4.1-m/s) free-area velocity.  
3. AMCA Seal: Mark units with AMCA Certified Ratings Seal.

LOUVER SCREENS  
B. General: Provide screen at each exterior louver.  
C. Louver Screen Frames: Same kind and form of metal as indicated for louver to which screens are attached.  
D. Louver Screening: Same kind of metal as indicated for louver.  
1. Insect Screening: Aluminum, 16 x 18 square mesh, 0.011-inch (0.28-mm) wire.  
2. Bird Screening: Flattened, expanded aluminum, 3/4 by 0.050 inch (19 by 1.27 mm) thick.

ALUMINUM FINISHES  
E. High-Performance Organic Finish: 3-coat fluoropolymer finish complying with AAMA 2605 and containing not less than 70 percent PVDF resin by weight in color coat. Prepare, pre-treat, and apply coating to exposed metal surfaces to comply with coating and resin manufacturers' written instructions.  
1. Color and Gloss: As selected by Architect from manufacturer's full range.

EXECUTION

INSTALLATION  
F. Locate and place louvers and vents level, plumb, and at indicated alignment with adjacent work.  
G. Use concealed anchorages where possible. Provide brass or lead washers fitted to screws where required to protect metal surfaces and to make a weather-tight connection.  
A. Provide perimeter reveals and openings of uniform width for sealants and joint fillers, as indicated.  
B. Repair damaged finishes so no evidence remains of corrective work. Return items that cannot be refinished in the field to the factory and refinish entire unit or provide new units.  
C. Protect galvanized and nonferrous-metal surfaces that will be in contact with concrete, masonry, or dissimilar metals from corrosion and galvanic action by applying a heavy coating of bituminous paint.

END OF SECTION 08 90 00

SECTION 09123 - INTERIOR PAINTING

1.1 SUMMARY  
A. Section includes surface preparation and the application of paint systems on **the following interior substrates:**  
1. Concrete.  
2. Concrete masonry units (CMU).  
B. Related Requirements:  
1. Section 091113 "Exterior Painting" for surface preparation and the application of paint systems on exterior substrates.

1.2 ACTION SUBMITTALS  
A. Product Data: For each type of product. Include preparation requirements and application instructions.

1.3 CLOSEOUT SUBMITTALS.  
1. Coating Maintenance Manual: Provide coating including area summary with finish schedule, area detail designating location where each product/color/finish was used.

1.4 MAINTENANCE MATERIAL SUBMITTALS  
A. Furnish extra material[s], **from the same product run,**] that match products installed and that are packaged with protective covering for storage and identified with labels describing contents.  
1. Paint: [2 gal (3.8 L)] of each paint material and color applied.

1.5 QUALITY ASSURANCE  
A. Mockups: Apply mockups of each paint system indicated and each color and finish selected to verify preliminary selections made under Sample submittals and to demonstrate aesthetic effects and set quality standards for materials and execution.  
1. Architect will select one surface to represent surfaces and conditions for application of each paint system specified.  
a. Vertical and Horizontal Surfaces: Provide samples of at least 100 sq. ft. (9 sq. m).  
2. Final approval of color selections will be based on mockups.  
a. If preliminary color selections are not approved, apply additional mockups of additional colors selected by Architect at no added cost to Owner.

1.1 DELIVERY, STORAGE, AND HANDLING  
A. Delivery and Handling: Deliver products to Project site in an undamaged condition in manufacturer's original sealed containers, complete with labels and instructions for handling, storing, unpacking, protecting, and installing. Packaging shall bear the manufacturer's label with the following information:  
1. Product name and type (description).Batch date,Color number,VOC content.  
2. Surface preparation requirements.  
3. Application instructions.  
B. Store materials not in use in tightly covered containers in well-ventilated areas with ambient temperatures continuously maintained at not less than 45 deg F (7 deg C).  
1. Maintain containers in clean condition, free of foreign materials and residue.  
2. Remove rags and waste from storage areas daily.

1.2 FIELD CONDITIONS  
A. Apply paints only when temperature of surfaces to be painted and ambient air temperatures are between 50 and 95 deg F (10 and 35 deg C).  
B. Do not apply paints when relative humidity exceeds 85 percent; at temperatures less than 5 deg F (3 deg C) above the dew point, or to damp or wet surfaces.

1.3 MANUFACTURERS  
A. Basis-of-Design Product: Subject to compliance with requirements, provide BEHR ULTRA OR EQUAL; products indicated or comparable product from one of the following:  
1. <BEHR ULTRA PAINT AND PRIMER OR EQUAL>.  
B. Comparable Products: Comparable products of approved manufacturers will be considered in accordance with Section 016000 "Product Requirements," and the following:  
1. Products are approved by manufacturer in writing for application specified.  
2. Products meet performance and physical characteristics of basis of design product including published ratio of solids by volume, plus or minus two percent.  
C. Source Limitations: Obtain paint materials from single source from single listed manufacturer.  
1. Manufacturer's designations listed on a separate color schedule are for color reference only and do not indicate prior approval.

1.4 PAINT, GENERAL  
A. Material Compatibility:  
  
1. Provide materials for use within each paint system that are compatible with one another and substrates indicated, under conditions of service and application as demonstrated by manufacturer, based on testing and field experience.  
2. For each coat in a paint system, provide products recommended in writing by manufacturers of topcoat for use in paint system and on substrate indicated.  
  
3. Flat Paints and Coatings: 50 g/L.  
4. Nonflat Paints and Coatings: 150 g/L.  
5. Primers, Sealers, and Undercoaters: 200 g/L.  
6. Floor Coatings: 100 g/L.  
7. Shellacs, Clear: 730 g/L.  
  
B. Low-Emitting Materials: Interior paints and coatings shall comply with the testing and product requirements of the California Department of Health Services' "Standard Practice for the Testing of Volatile Organic Emissions from Various Sources Using Small Scale Environmental Chambers."

C. Colors: **As selected by Architect from manufacturer's full range.**

D. EXAMINATION  
1. Examine substrates and conditions, with Applicator present, for compliance with requirements for maximum moisture content and other conditions affecting performance of the Work. Verify suitability of substrates, including surface conditions and compatibility with existing finishes and primers. Where acceptability of substrate conditions is in question, apply samples and perform in-situ testing to verify

compatibility, adhesion, and film integrity of new paint application.

E. Substrate Conditions:  
1. Maximum Moisture Content of Substrates: When measured with an electronic moisture meter as follows:  
a. Concrete: 12 percent.  
b. Masonry (Clay and CMU): 12 percent.  
F. Proceed with coating application only after unsatisfactory conditions have been corrected; application of coating indicates acceptance of surfaces and conditions.

1.2 PREPARATION  
A. Comply with manufacturer's written instructions and recommendations in "MPI Manual" applicable to substrates indicated.  
B. Remove hardware, covers, plates, and similar items already in place that are removable and are not to be painted. If removal is impractical or impossible because of size or weight of item, provide surface-applied protection before surface preparation and painting.  
1. After completing painting operations, use workers skilled in the trades involved to reinstall items that were removed. Remove surface-applied protection if any.  
B. Clean substrates of substances that could impair bond of paints, including dust, dirt, oil, grease, and incompatible paints and encapsulants.  
1. Remove incompatible primers and reprime substrate with compatible primers or apply tie coat as required to produce paint systems indicated.  
C. Concrete Substrates: Remove release agents, curing compounds, efflorescence, and chalk. Do not paint surfaces if moisture content or alkalinity of surfaces to be painted exceeds that permitted in manufacturer's written instructions.  
1. Concrete Floors: Remove oil, dust, grease, dirt, and other foreign materials. Comply with SSPC-SP-13/NACE 6 or ICR1 03732.  
D. Masonry Substrates: Remove efflorescence and chalk. Do not paint surfaces if moisture content or alkalinity of surfaces or mortar joints exceed that permitted in manufacturer's written instructions.


1.2 APPLICATION  
A. Apply paints according to manufacturer's written instructions and to recommendations in "MPI Manual."  
1. Use applicators and techniques suited for paint and substrate indicated.  
2. Paint surfaces behind movable equipment and furniture same as similar exposed surfaces. Before final installation, paint surfaces behind permanently fixed equipment or furniture with prime coat only.  
3. Do not paint over labels of independent testing agencies or equipment name, identification, performance rating, or nomenclature plates.

1.3 CLEANING AND PROTECTION  
A. At end of each workday, remove rubbish, empty cans, rags, and other discarded materials from Project site.  
B. After completing paint application, clean spattered surfaces. Remove spattered paints by washing, scraping, or other methods. Do not scratch or damage adjacent finished surfaces.  
C. Protect work of other trades against damage from paint application. Correct damage to work of other trades by cleaning, repairing, replacing, and refinishing, as approved by Architect, and leave in an undamaged condition.  
D. At completion of construction activities of other trades, touch up and restore damaged or defaced painted surfaces.



1.4 INTERIOR PAINTING SCHEDULE  
A. Concrete Substrates, Nontraffic Surfaces[ **and Clay Masonry**]:  
1. Clear seal coating: Submit for approval Sherwin Williams or equal  
B. CMU Substrates:  
1. Latex System: Sherwin Williams or equal  
a. Block Filler: Block filler, latex, interior/exterior:  
1) S-W PrepRite Block Filler, B25W25, at 75-125 sq. ft. per gal. (1.84 to 3.07 sq. m per liter).  
b. Intermediate Coat: Latex, interior, matching topcoat.  
c. Topcoat: Latex, interior, low sheen:  
1) S-W ProMar 200 Zero VOC Latex Low Sheen Enamel, B24-2600 Series, at 4.0 mls (0.102 mm) wet, 1.6 mls (0.041 mm) dry, per coat.

END OF SECTION 091123

DESIGN

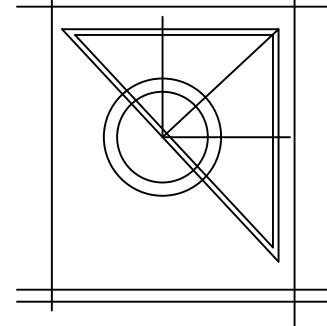

RDS DESIGN, LLC  
ARCHITECTURE  
821 KINLOCK CT.  
COLUMBIA, SOUTH CAROLINA 29223  
803.447.4817 Simkins@aol.com

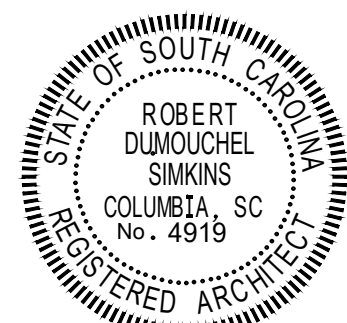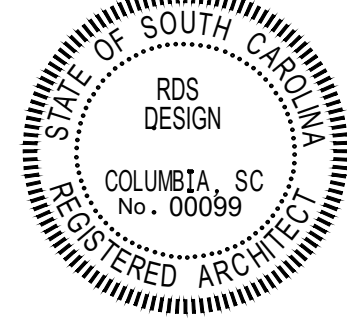  
3/01/22  


SEAL

RIVERBANKS ZOO – HAY BARN  
500 WILDLIFE PARKWAY  
COLUMBIA, SC  
SHEET TITLE: SPECIFICATIONS

DRAWN BY \_\_\_\_\_RS\_\_\_\_\_  
DATE 3/01/22

SHEET NO. OF  
A8




SECTION 08330	
ROLLING SERVICE DOORS	
STORMTITE™ MODEL 625	
PART 1 GENERAL	
1.1 SECTION INCLUDES	A. Insulated rolling service doors.
1.2 RELATED SECTIONS	A. Section 05500 - Metal Fabrications: Support framing and framed opening. B. Section 08710 - Door Hardware: Product Requirements for cylinder core and keys. C. Section 09900 - Painting: Field applied finish. D. Section 16130 - Raceway and Boxes: Conduit from electric circuit to door operator and from door operator to control station. E. Section 16150 - Wiring Connections: Power to disconnect.
1.3 REFERENCES	A. ANSI/DASMA 108 - American National Standards Institute Standard Method For Testing Sectional Garage Doors And Rolling Doors: Determination Of Structural Performance Under Uniform Static Air Pressure Difference. A. NEMA 250 - Enclosures for Electrical Equipment (1000 Volts Maximum).  B. NEMA MG 1 - Motors and Generators.
1.2 DESIGN / PERFORMANCE REQUIREMENTS	A. Single-Source Responsibility: Provide doors, tracks, motors, and accessories from one manufacturer for each type of door. Provide secondary components from source acceptable to manufacturer of primary components.  B. Products Requiring Electrical Connection: Listed and classified by Underwriters Laboratories, Inc. acceptable to authority having jurisdiction as suitable for purpose specified.
1.3 SUBMITTALS	A. Submit under provisions of Section 01300.  B. Product Data: Manufacturer's data sheets on each product to be used, including: 1. Preparation instructions and recommendations. 2. Storage and handling requirements and recommendations. 3. Details of construction and fabrication. 4. Installation instructions.  C. Shop Drawings: Include detailed plans, elevations, details of framing members, anchoring methods, required clearances, hardware, and accessories. Include relationship with adjacent construction. D. Selection Samples: For each finish product specified, two complete sets of color chips representing manufacturer's full range of available colors and patterns.  E. Verification Samples: For each finish product specified, two samples, minimum size 6 inches (150 mm) long, representing actual product, color, and patterns. A. Manufacturer's Certificates: Certify products meet or exceed specified requirements.  B. Operation and Maintenance Data: Submit lubrication requirements and frequency, and periodic adjustments required.
1.2 QUALITY ASSURANCE	A. Manufacturer Qualifications: Company specializing in performing Work of this section with a minimum of five years experience in the fabrication and installation of security closures. B. Installer Qualifications: Installer Qualifications: Company specializing in performing Work of this section with minimum three years and approved by manufacturer.

C. Mock-Up: Provide a mock-up for evaluation of surface preparation techniques and application workmanship. 1. Finish areas designated by Architect. 2. Do not proceed with remaining work until workmanship, color, and sheen are approved by Architect. 3. Refinish mock-up area as required to produce acceptable work.	3 DELIVERY, STORAGE, AND HANDLING  ore products in manufacturer's unopened packaging until ready for installation  A. Protect materials from exposure to moisture. Do not deliver until after wet work is complete and dry.  B. Store materials in a dry, warm, ventilated weathertight location.
2 PROJECT CONDITIONS  A. Maintain environmental conditions (temperature, humidity, and ventilation) within limits recommended by manufacturer for optimum results. Do not install products under environmental conditions outside manufacturer's absolute limits.	3 COORDINATION  A. Coordinate Work with other operations and installation of adjacent materials to avoid damage to installed materials.
4 WARRANTY  A. Warranty: Manufacturer's limited door and operator system, except the counterbalance spring and finish, to be free from defects in materials and workmanship for 3 years or 20,000 cycles, whichever occurs first.  B. Warranty: Manufacturer's limited door system warranty for 2 years for all parts and components.  C. PowderGuard Finish 1. PowderGuard Premium Applied to curtain, guides, bottom bar, headplates: Manufacturer's limited Premium Finish warranty for 2 years.  1. PowderGuard Zinc Base Coat applied to guides, bottom bar, headplates plus PowderGuard Premium applied to curtain and top coat for guides, bottom bar, headplates: Manufacturer's limited Zinc Finish warranty for 4 years.	ART 2 PRODUCTS  1 MANUFACTURERS  A. Acceptable Manufacturer: Overhead Door Corporation, 2501 S. State Hwy. 121, Suite 200, Lewisville, TX 75067. ASD. Tel. Toll Free: (800) 275-3290. Phone: (469) 549-7100. Fax: (972) 906-1499. Web Site: <a href="http://www.overheaddoor.com">www.overheaddoor.com</a> . E-mail: <a href="mailto:info@overheaddoor.com">info@overheaddoor.com</a> . Or equal  B. Substitutions: Not permitted.  C. Requests for substitutions will be considered in accordance with provisions of Section 01600.
2 INSULATED ROLLING SERVICE DOORS  A. Stormtite Insulated Rolling Service Doors: Overhead Door Corporation Model 625. 1. Curtain: Interlocking roll-formed slats as specified following. Endlocks shall be attached to each end of alternate slats to prevent lateral movement. a. Flat profile type F-265i for doors up to 40 feet (12.19 m) wide. b. Front slat fabricated of: 1) 22 gauge galvanized steel. c. Back slat fabricated of:	


1) 22 gauge galvanized steel. b. Slat cavity filled with CFC-free foamed-in-place, polyurethane insulation. 1) R-Value: 7.7, U-Value: 0.13. 2) Sound Rating: STC-21.	2. Performance: a. Through Curtain Sound Rating: Sound Rating: STC-28 (STC-30+ with HZ noise generator) as per ASTM E 90. b. Installed System Sound Rating: STC-21 as per ASTM E 90. c. U-factor: 0.91 NFRC test report, maximum U-factor of no higher than 1.00. d. Air Infiltration: Meets ASHRAE 90.1 & IECC 2012/2015 C402.4.3 Air leakage <1.00 cfm/ft2.
3. Slats and Hood Finish: a. Galvanized Steel: Slats and hood galvanized in accordance with ASTM A 653 and receive rust-inhibitive, roll coating process, including 0.2 mils thick baked-on prime paint, and 0.6 mils thick baked-on polyester top coat. 1) Polyester Top Coat. (a) White polyester. 2) Powder Coat: (a) PowderGuard Premium powder coat color as selected by the Architect. 3) Non-galvanized exposed ferrous surfaces shall receive one coat of rust-inhibitive primer. b. Stainless Steel: Slats and hood shall be stainless steel finished as follows. 1) Finish: No. 4 satin finish. c. Aluminum: Slats and hood shall be aluminum finished as follows. 1) Finish: Powder Coat: (a) PowderGuard Premium powder coat color as selected by the Architect.	4. Weatherseals: 1. a. Vinyl bottom seal, exterior guide and internal hood seals. b. Interior guide weatherseal. c. Lintel weatherseal. d. Air Infiltration Package, IECC 2012/2015 listed; product to meet C402.4.3 2012 Air leakage <1.00 cfm/ft2. 1) Air infiltration perimeter seal package includes: guide cover, guide cap, dual brush exterior guide seal, 4 inch finned lintel brush seal and vinyl bottom seal.
2. Bottom Bar: a. Two prime painted steel angles minimum thickness 1/8 inch (3 mm) bolted back to back to reinforce curtain in the guides.	3. Guides: Three structural steel angles.
4. Brackets: a. Hot rolled prime painted steel to support counterbalance, curtain and hood. b. Galvanized steel to support counterbalance, curtain and hood. c. Stainless steel to support counterbalance, curtain and hood.	5. Finish: Bottom Bar, Guides, Headplate and Brackets: a. PowderGuard Zinc base coat with PowderGuard Premium powder coat color as selected by the Architect. b. Finish: PowderGuard Max powder coat color as selected by the Architect.
1. Counterbalance: Helical torsion spring type housed in a steel tube or pipe barrel, supporting the curtain with deflection limited to 0.03 inch per foot of span. Counterbalance is adjustable by means of an adjusting tension wheel. 2. Hood: Provide with internal hood baffle weatherseal. a. 24 gauge galvanized steel with intermediate supports as required.	3. Manual Operation: a. Chain hoist. b. Crank operation.
4. Electric Motor Operation: Provide UL listed electric operator, size as recommended by manufacturer to move door in either direction at not less than 2/3 foot nor more than 1 foot per second.	

a. Sensing Edge Protection: 1) Pneumatic sensing edge. 2) Electric sensing edge. b. Operator Controls: 1) Push-button and key operated control stations with open, close, and stop buttons. 2) Controls for interior location. 3) Controls surface mounted. c. Motor Voltage: 115/230 single phase, 60 Hz. 5. Wind Load Design: a. Standard wind load shall be 20 PSF. 6. Operation: Design door assembly, including operator, to operate for not less than 20,000 cycles. 7. Locking: a. Chain keeper locks for chain hoist operation. b. Interior slide bolt lock for electric operation with interlock switch. c. Cylinder lock for electric operation with interlock switch. 8. Wall Mounting Condition: a. Face-of-wall mounting.	PART 1 EXECUTION  1.1 EXAMINATION  A. Verify opening sizes, tolerances and conditions are acceptable.  B. Examine conditions of substrates, supports, and other conditions under which the work is to be performed.  C. If substrate preparation is the responsibility of another installer, notify Architect of unsatisfactory preparation before proceeding.
	1.2 PREPARATION  A. Clean surfaces thoroughly prior to installation.  B. Prepare surfaces using the methods recommended by the manufacturer for achieving the best result for the substrate under the project conditions.
	1.3 INSTALLATION  A. Install in accordance with manufacturer's instructions. B. Use anchorage devices to securely fasten assembly to wall construction and building framing without distortion or stress.  Securely and rigidly brace components suspended from structure. Secure guides A. Securely and rigidly brace components suspended from structure. Secure guides and structural members only. B. Fit and align assembly including hardware; level and plumb, to provide smooth operation. C. Coordinate installation of electrical service with Section 16150. Complete wiring from disconnect to unit components. D. Coordinate installation of sealants and backing materials at frame perimeter as specified in Section 07900. E. Install perimeter trim and closures. F. Instruct Owner's personnel in proper operating procedures and maintenance schedule.
	1.2 ADJUSTING  A. Test for proper operation and adjust as necessary to provide proper operation without binding or distortion. B. Adjust hardware and operating assemblies for smooth and noiseless operation.
	1.3 CLEANING  A. Clean curtain and components using non-abrasive materials and methods recommended by manufacturer. B. Remove labels and visible markings. C. Touch-up, repair or replace damaged products before Substantial Completion.


DESIGN

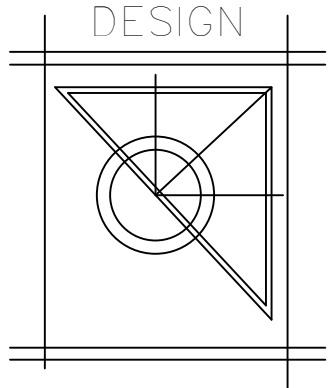

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3/01/22  
*Robert Simkins*

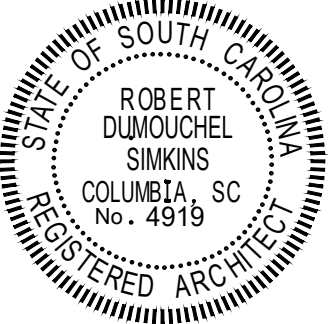


SEAL

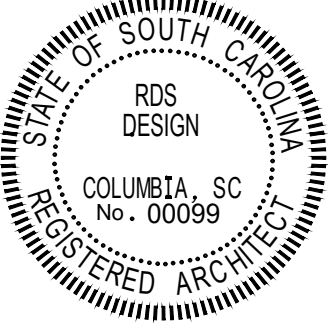RIVERBANKS ZOO – HAY BARN  
500 WILDLIFE PARKWAY  
COLUMBIA, SC


SHEET TITLE:  
SPECIFICATIONS

DRAWN BY       RS  
DATE 3/01/22



SHEET NO.        OF         
**A9**

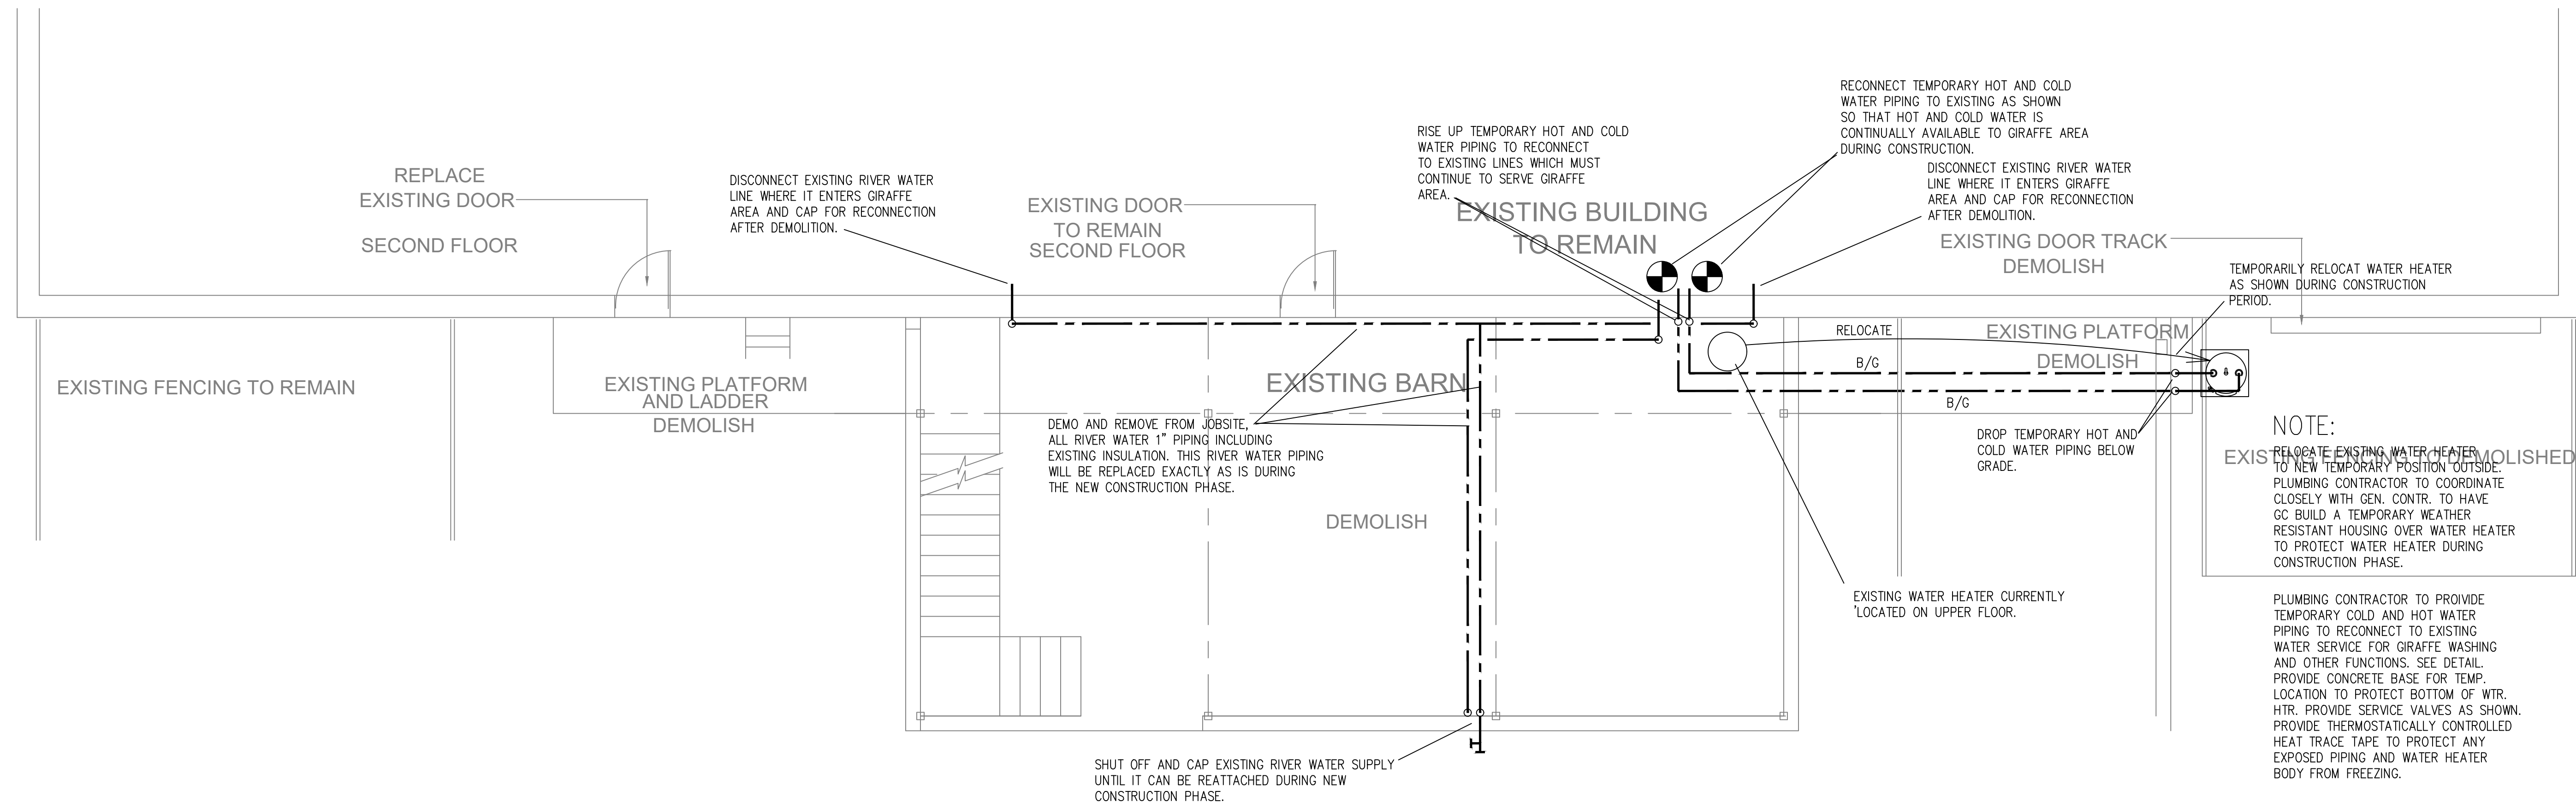

DEMOLITION  
PLUMBING FLOOR PLAN  
BUILDING SCALE: 1/4" = 1'-0"

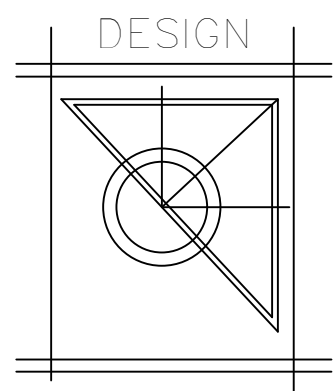

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SEAL

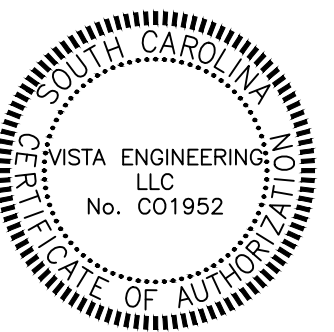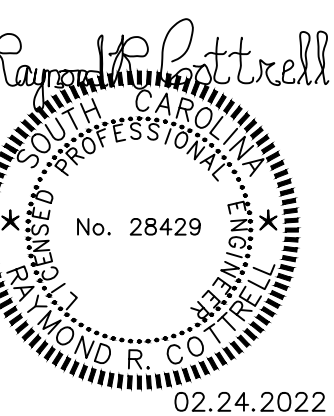RIVERBANKS ZOO - HAY BARN  
500 WILDLIFE PARKWAY  
COLUMBIA, SC

SHEET TITLE:  
PLUMBING DEMOLITION FLOOR PLAN

DRAWN BY RRC  
DATE 2/24/2022


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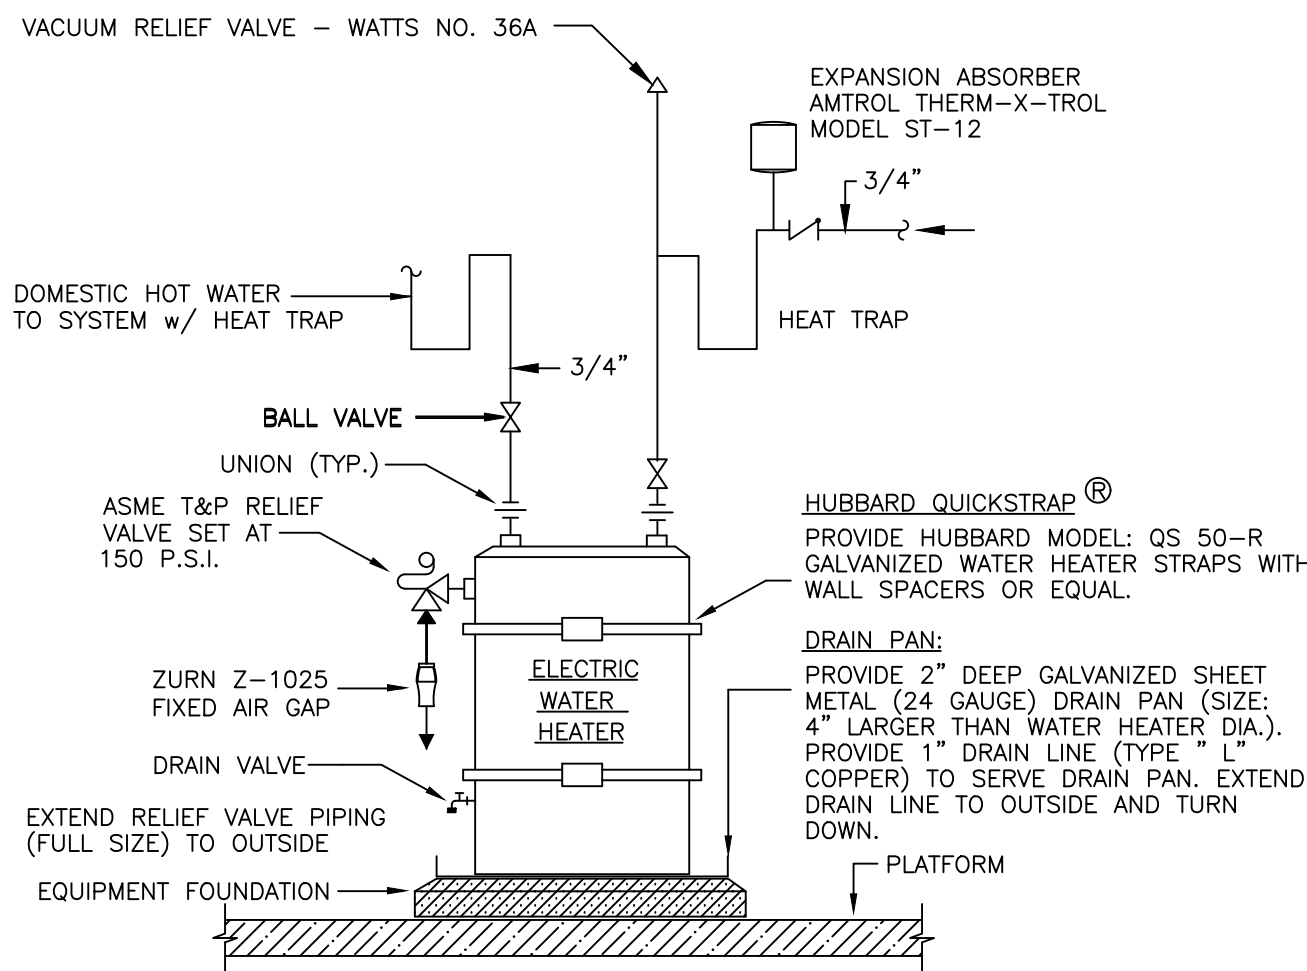
**VISTA**  
**ENGINEERING, LLC**  
CONSULTING MECHANICAL ENGINEERING  
530 S. SALUDA AVE. COLUMBIA, SC 29205  
TEL: (803) 799-8900 FAX: (803) 799-8960  
E-MAIL: rcottrell@vistacengineering.net









INDOOR EQUIPMENT FOUNDATION  
N.T.S.

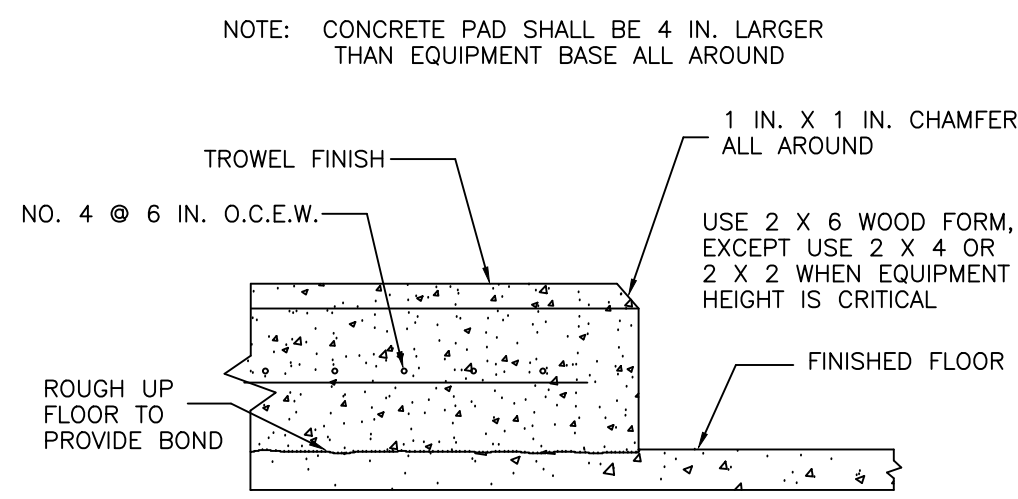

WATER HEATER DETAIL  
N.T.S.

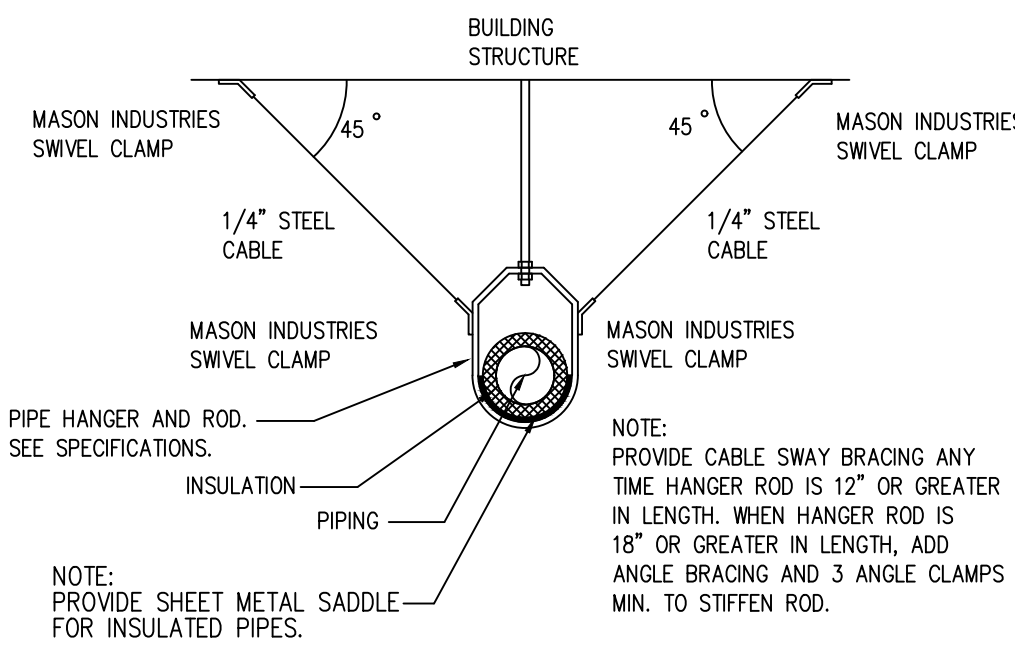

SEISMIC PIPE BRACING DETAIL  
N.T.S.

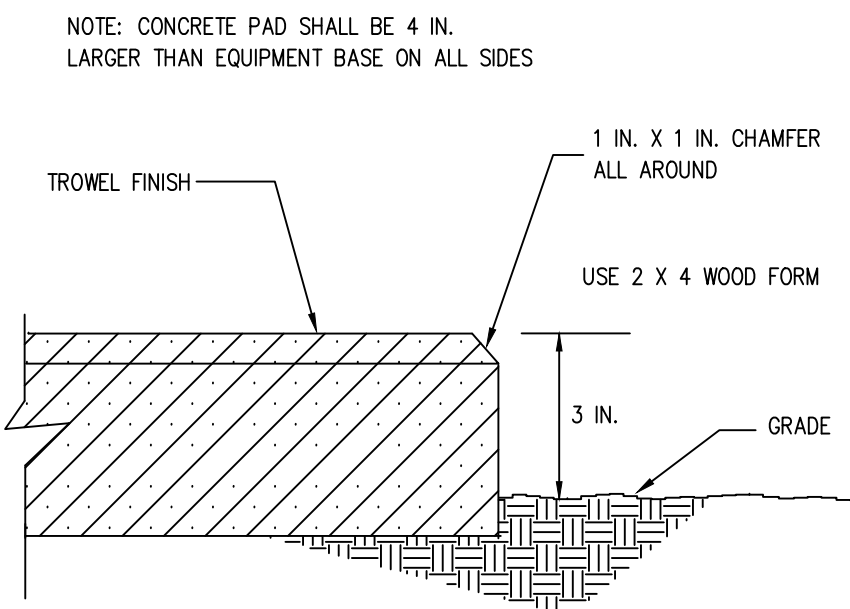

OUTDOOR EQUIPMENT FOUNDATION  
N.T.S.

## PLUMBING FIXTURE SCHEDULE


MARK	BASIS OF DESIGN	CW	HW	W	V
WH	WALL HYDRANT: WOODFORD MODEL 65 ANTI-SIPHON AUTOMATIC DRAINING FREEZELESS WALL HYDRANT, SHALL MEET ASSE STANDARD 1019-B, LISTED BY IAPMO, AND MEET GOVERNMENT SPECIFICATION WW-541B TYPE 205, COMPLETE WITH NIDEL MODEL 34HA VACUUM BREAKER WITH 3/4" THREAD MALE HOSE ADAPTOR, UNDER NOZZLE DRAIN, LOOSE KEY OPERATED (DELIVER KEYS TO OWNER) AND WITH CHROME FINISH ON BRASS CASTING.	3/4"			
FIXTURES LISTED ABOVE ARE FOR BIDDING PURPOSES ONLY. FIXTURE MANUFACTURER, MODEL, STYLE, COLOR ETC. SHALL BE APPROVED BY ARCHITECT AND OWNER. NOTE:					

## PLUMBING NOTES


- DO NOT SCALE PLUMBING DRAWINGS. ROUGH FROM ARCHITECTURAL DRAWINGS AND EQUIPMENT MANUFACTURER'S CERTIFIED DRAWINGS. SEE ARCHITECTURAL DRAWINGS FOR EXACT DIMENSIONS, FIXTURE LOCATIONS, ETC.
- DIMENSIONS ARE IN INCHES UNLESS OTHERWISE NOTED.
- UNLESS OTHERWISE SHOWN OR NOTED, LOCATE ALL PIPING ABOVE CEILING.
- WHEREVER THE WORD "PROVIDE" IS USED, IT SHALL MEAN "FURNISH AND INSTALL COMPLETE AND READY FOR USE."
- EXCEPT WHERE PIPE SPACE IS PROVIDED, OR UNLESS OTHERWISE NOTED, ALL SUPPLY, WASTE, SOIL AND VENT RISERS SHALL RUN IN WALLS OR PARTITIONS.
- LOCATE HOSE BIBBS, AND / OR WALL HYDRANTS 2'-0" ABOVE FINISHED FLOOR AND / OR GRADE.
- COORDINATE CLOSELY WITH ALL OTHER TRADES FOR WORK DONE UNDER THIS CONTRACTOR TO AVOID INTERFERENCE OR CONFLICT.
- ALL HOSE BIBBS AND VALVES WITH THREADED HOSE CONNECTIONS SHALL BE EQUIPPED WITH A WATTS REGULATOR COMPANY NO. 8 BACK SIPHONAGE BACKFLOW PREVENTER, AND VACUUM BREAKER OF FINISH TO MATCH HOSE BIBB OR WALL HYDRANT.
- COORDINATE WITH SITE CONTRACTOR FOR CONTINUATION OF UTILITIES.
- PROVIDE ACCESS TO ALL EQUIPMENT REQUIRING CLEANING OR ADJUSTMENT. IF ACCESS DOORS ARE REQUIRED, THEY SHALL BE EQUAL TO KEES, INC. STYLE K IN NON RATED APPLICATIONS AND KEES, INC. STYLE AP-FR IN RATED APPLICATIONS.
- SEE ELECTRICAL DRAWINGS FOR ELECTRICAL CHARACTERISTICS. ELECTRICAL CHARACTERISTICS SHALL BE VERIFIED BEFORE ORDERING EQUIPMENT.
- EXPOSED WASTE AND WATER PIPING UNDER HANDICAPPED LAVATORIES SHALL INSULATED WITH TRUE-BRO, INC. #103 PROTECTIVE UNDER SINK DRAIN PIPING AND ANGLE VALVE SUPPLY COVERS IN WHITE.
- ALL PIPING IS SHOWN DIAGRAMMATIC. HOWEVER, CONTRACTOR SHALL PROVIDE ALL REQUIRED FITTINGS, PIPING AND INSULATION FOR ALL OFFSETS, AND / OR CHANGES IN ELEVATION.
- ALL PIPING SHALL BE SUPPORTED IN ACCORDANCE WITH THE SPECIFICATIONS AND FURTHER SUPPORTS OR HANGERS SHALL BE PROVIDED TO PREVENT THE WEIGHT OF THE PIPING BEING PLACED ON THE EQUIPMENT.
- CONTRACTOR SHALL VERIFY ACTUAL LOCATIONS AND INVERTS OF EXISTING UTILITIES PRIOR TO START OF CONSTRUCTION.
- COORDINATE LOCATION OF NEW PIPING LOCATED BELOW BUILDING WITH STRUCTURAL PLANS AND OTHER TRADES TO AVOID CONFLICT.

## PLUMBING SYMBOLS

SYMBOL	DESCRIPTION
	ROOF DRAIN
	WASTE PIPING
	WASTE VENT PIPING
	VENT THRU ROOF
	140 °F) HOT WATER PIPING
	HOT WATER PIPING
	HOT WATER RECIRCULATION PIPING
	COLD OR RIVER WATER PIPING
	PIPE TURNS TO, AWAY
	CAP AT END OF LINE
	HOSE BIBB
	WALL HYDRANT
	BALL VALVE
	GAS PIPING
	BALL VALVE IN VALVE BOX
	LOW PREASURE GAS METER
	SHOCK ARRESTOR
	WALL CLEANOUT
	GRADE CLEANOUT
	FLOOR CLEANOUT
	FLOOR DRAIN WITH FUNNEL
	FLOOR DRAIN
	FLOOR SINK
	COLD WATER
	HOT WATER
	ABOVE CEILING
	BELOW SLAB
	BELOW GRADE
	RECIRCULATION PUMP
	TRAP PRIMER VALVE
	CONNECT TO EXISTING

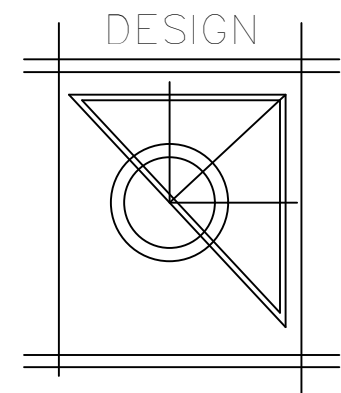

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RIVERBANKS ZOO - HAY BARN  
500 WILDLIFE PARKWAY  
COLUMBIA, SC

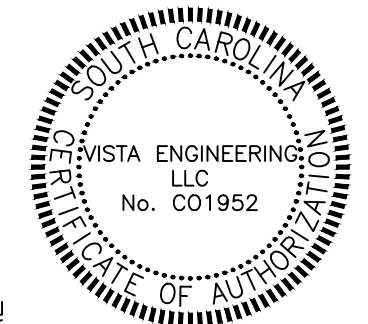

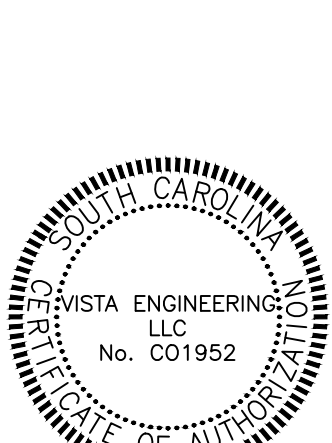
SHEET TITLE:  
PLUMBING SCHEDULES, DETAILS

DRAWN BY RRC  
DATE 2/24/2022

SHEET NO. OF

P3

VISTA  
ENGINEERING LLC  
CONSULTING MECHANICAL ENGINEERING  
530 S. SALUDA AVE. COLUMBIA, SC 29205  
TEL: (803) 799-8900 FAX: (803) 799-8960  
E-MAIL: rpittrell@vistaengineering.net
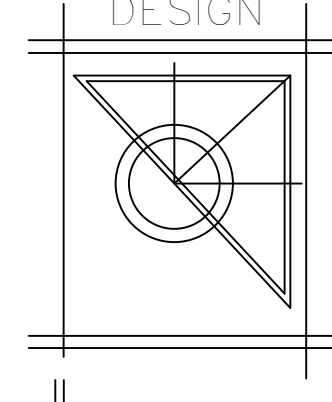
<div><div>DESIGN</div></div>		<div>RDS DESIGN, LLC ARCHITECTURE 821 KINLOCK CT. COLUMBIA, SOUTH CAROLINA 29223 803.447.4817    <a href="mailto:Simkins8@aol.com">Simkins8@aol.com</a></div>	
<div> 02.24.2022</div>		<div> 02.24.2022</div>	
<div>RIVERBANKS ZOO – HAY BARN 500 WILDLIFE PARKWAY COLUMBIA, SC</div>		<div>SHEET TITLE: PLUMBING SPECIFICATIONS</div>	
<div>DRAWN BY <u>          RRC          </u> DATE <u>          2/24/2022          </u></div>			
<div>SHEET NO. <b>P4</b></div>		<div>OF</div>	



STRUCTURAL DESIGN CRITERIA:

1. APPLICABLE BUILDING CODES:

2018 INTERNATIONAL BUILDING CODE  
ASCE 7-10 MINIMUM DESIGN LOADS FOR BUILDINGS AND OTHER STRUCTURES  
ACI 318-14 BUILDING CODE REQUIREMENTS FOR STRUCTURAL CONCRETE  
BUILDING CODE REQUIREMENTS FOR MASONRY STRUCTURES

2. RISK FACTOR: II

3. LIVE LOADS: LIGHT STORAGE ..... 125 PSF

NOTE: IT IS UNLAWFUL TO PLACE, CAUSE OR PERMIT TO BE PLACED,  
ON ANY FLOOR OR ROOF OF A BUILDING, STRUCTURE, OR PORTION  
THEREOF, A LOAD GREATER THAN PERMITTED BY THESE REQUIREMENTS  
AND THE APPLICABLE BUILDING CODE(S).

ROOF:

ORDINARY, PITCHED AND CURVED ROOFS ..... 20 PSF

AWNINGS:

FABRIC WITH SKELETON STRUCTURE ..... 5 PSF

ALL OTHER AWNINGS ..... 20 PSF

4. BASIC LATERAL SYSTEM:

BEARING WALL SYSTEM,

ORDINARY REINFORCED MASONRY SHEAR WALLS R=2

5. DEAD LOADS: USE ACTUAL LOADS OF ALL BUILDING MATERIALS

6. WIND LOADS:

BASIC DESIGN WIND VELOCITY .... V = 130 MPH (Vasd = 101 MPH)

WIND IMPORTANCE FACTOR (Iw) ..... 1.0

WIND EXPOSURE CATEGORY ..... B

INTERNAL PRESSURE COEFFICIENTS:

ENCLOSED BUILDING +/- 18%

PARTIALLY ENCLOSED +/- 55%

OPEN BUILDING +/- 0

7. SNOW LOADS:

GROUND SNOW LOAD (PSF) .... Pg = 10 PSF

8. SEISMIC LOADS:

SOIL SITE CLASS ..... D

IMPORTANCE FACTOR (Ie) ..... 1.0 [FOR RISK II]

SPECTRAL RESPONSE ACCELERATIONS .... Ss = 0.43 S1 = 0.15

SPECTRAL RESPONSE COEFFICIENTS .... Sds = 0.42 Sd1 = 0.22


SEISMIC BUILDING DESIGN CATEGORY ... D

RESPONSE MODIFICATION FACTOR ... R = 2

SEISMIC RESPONSE COEFFICIENT ... Cs = 0.21

DESIGN BASE SHEAR ..... V = 42 KIPS

SEISMIC ANALYSIS ..... EQUIVALENT FORCE PROCEDURE

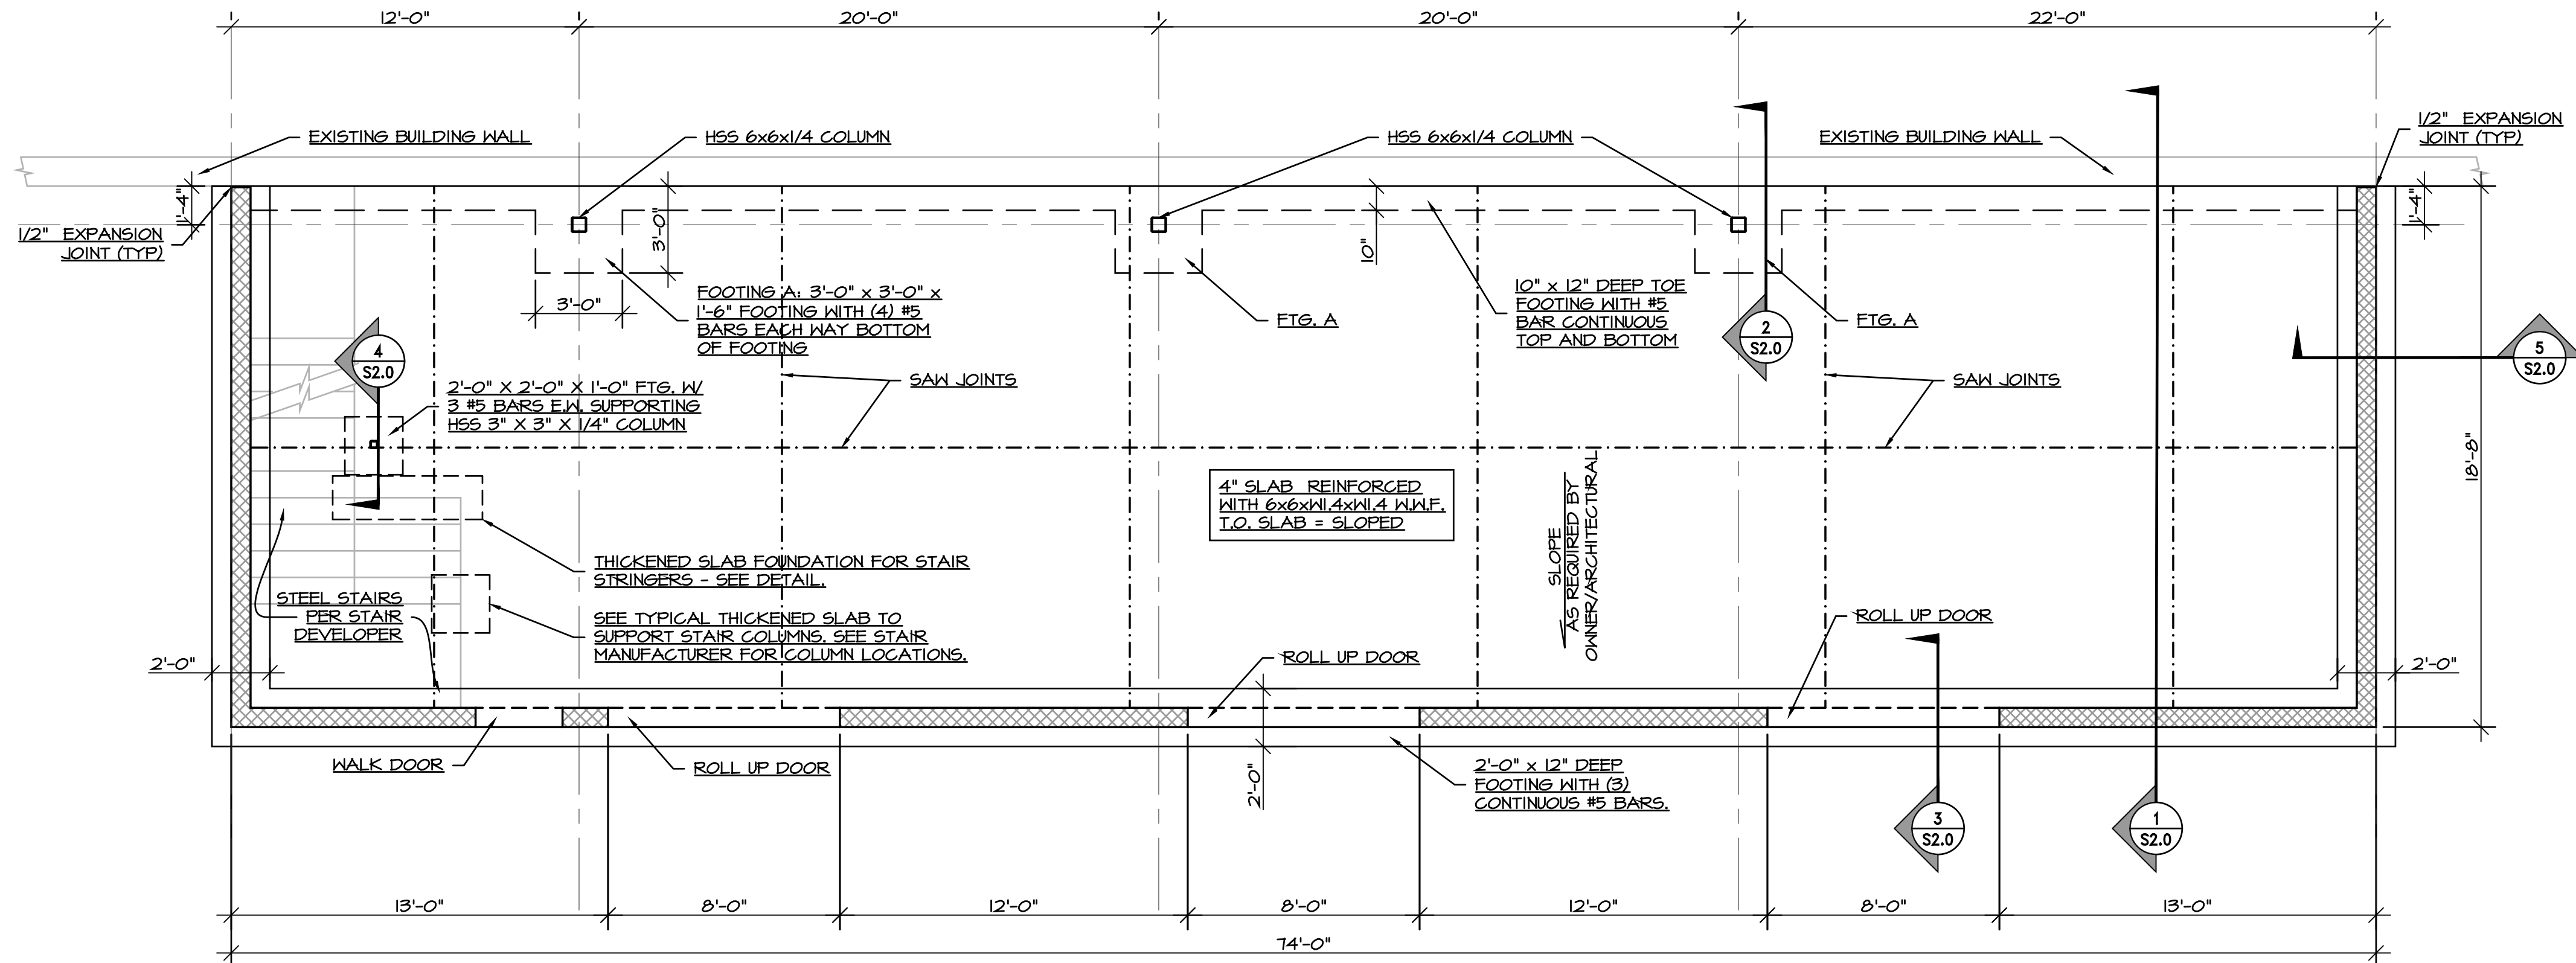


SEE OWNER/ARCHITECT  
REQUIREMENTS FOR  
CONCRETE SLABS, WALKS,  
AND EQUIPMENT PADS.


FOUNDATION / SLAB PLAN  
SCALE: 1/4" = 1'-0"

FOR CONSTRUCTION

Revisions	
Revision	By

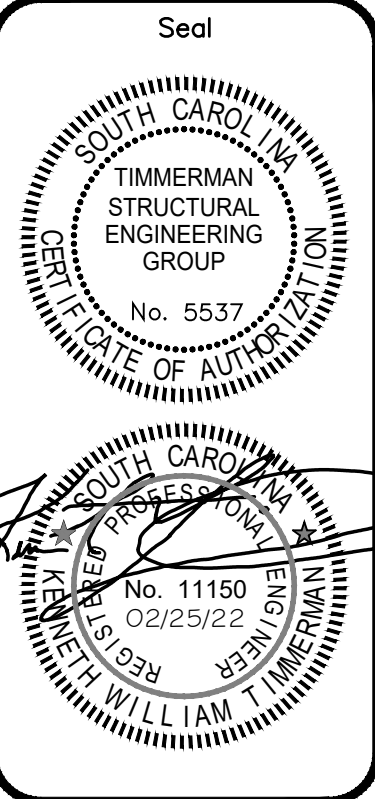


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**RIVERBANKS ZOO & GARDEN BARN ADDITION**  
500 WILDLIFE PARKWAY  
COLUMBIA, SOUTH CAROLINA 29210

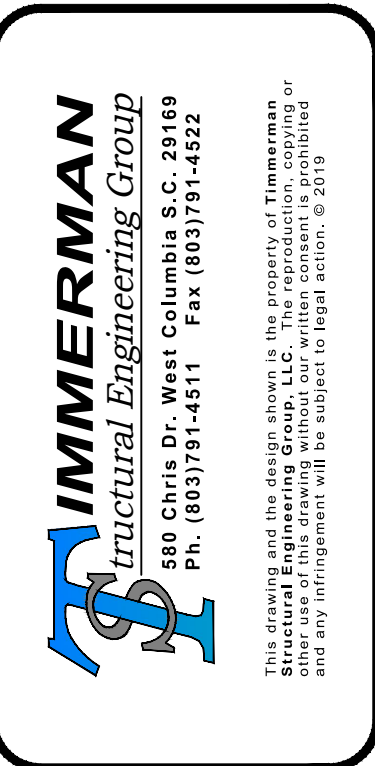


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Scale:	AS NOTED
Job Number:	22-102
Designed By:	KWT
Drawn By:	TJD
Checked By:	KWT
Date:	02/25/2022

Sheet Number  
**S1.0**  
Sheet 1 of 7



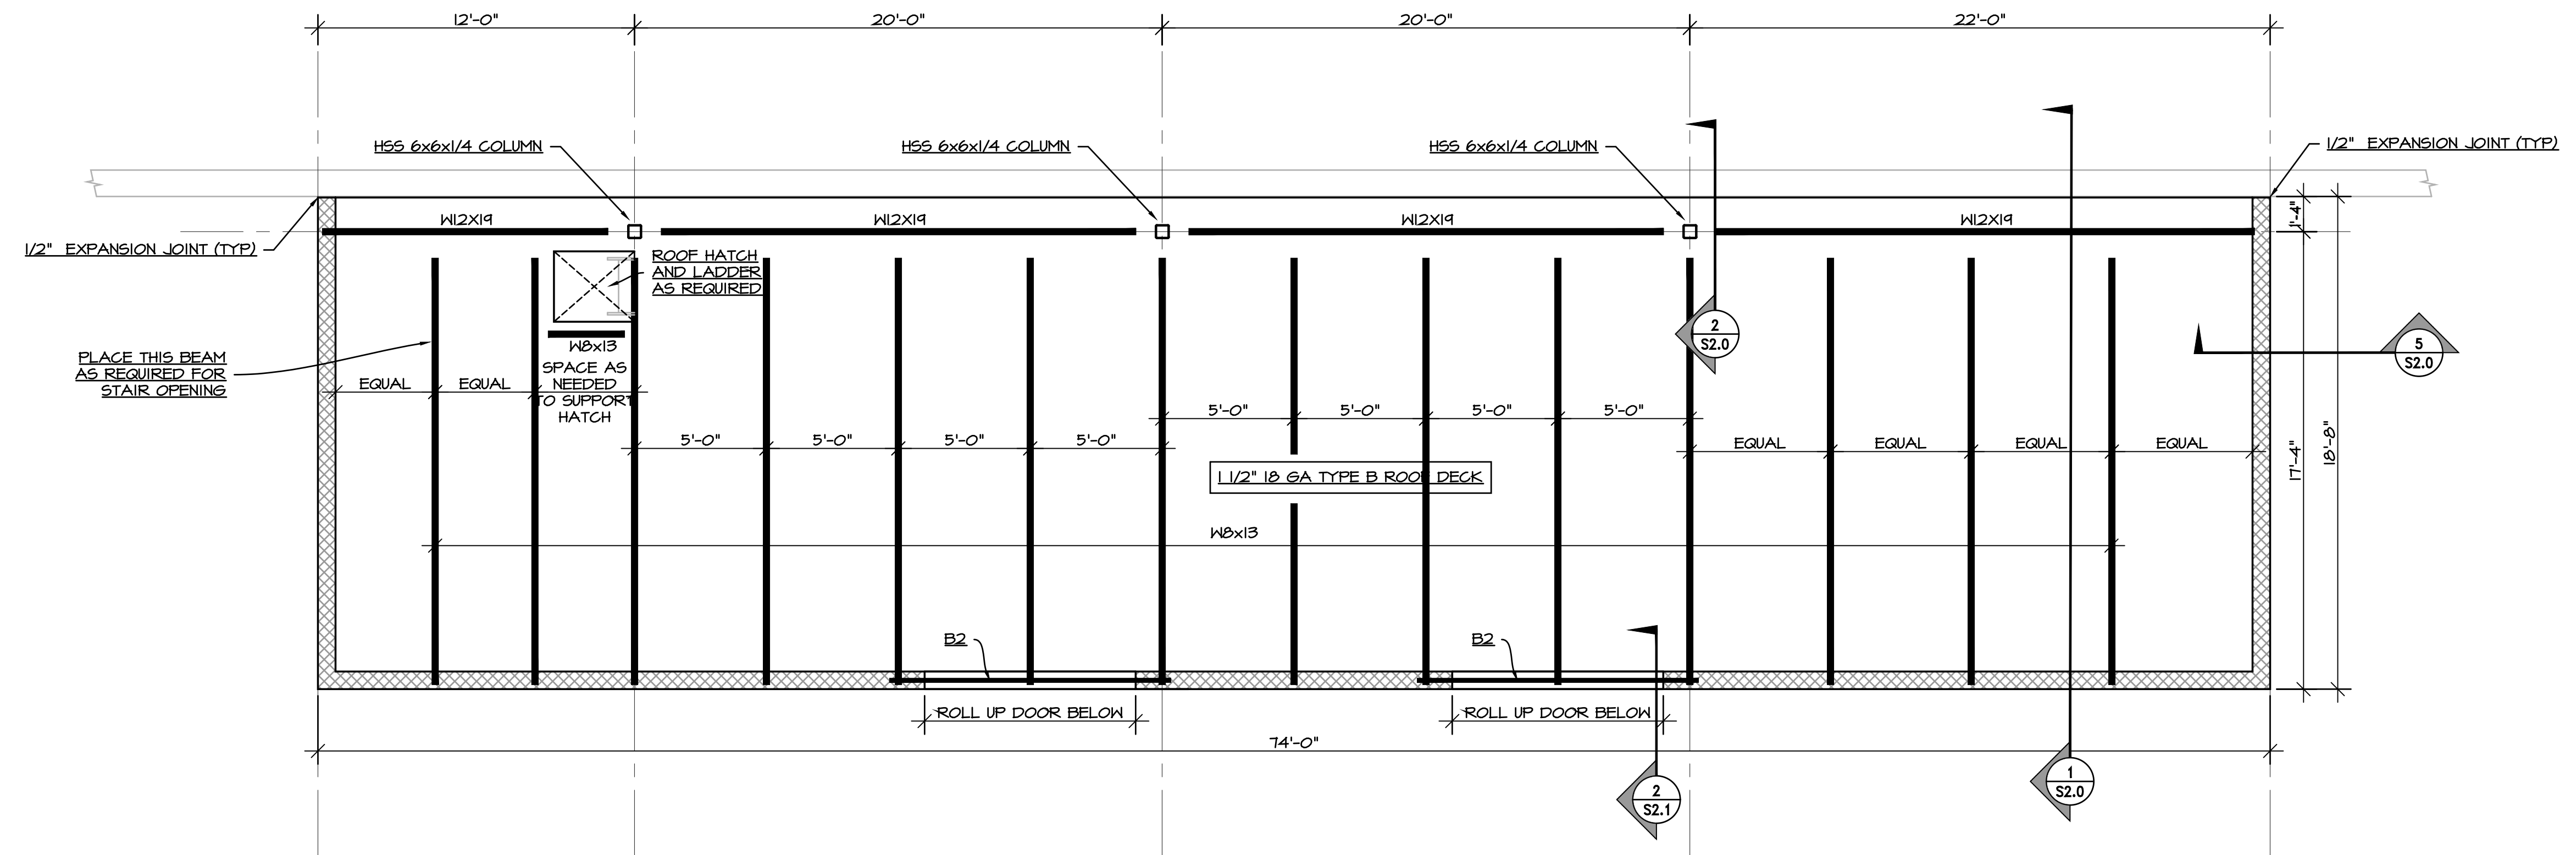


ROOF FRAMING PLAN  
SCALE: 1/4" = 1'-0"

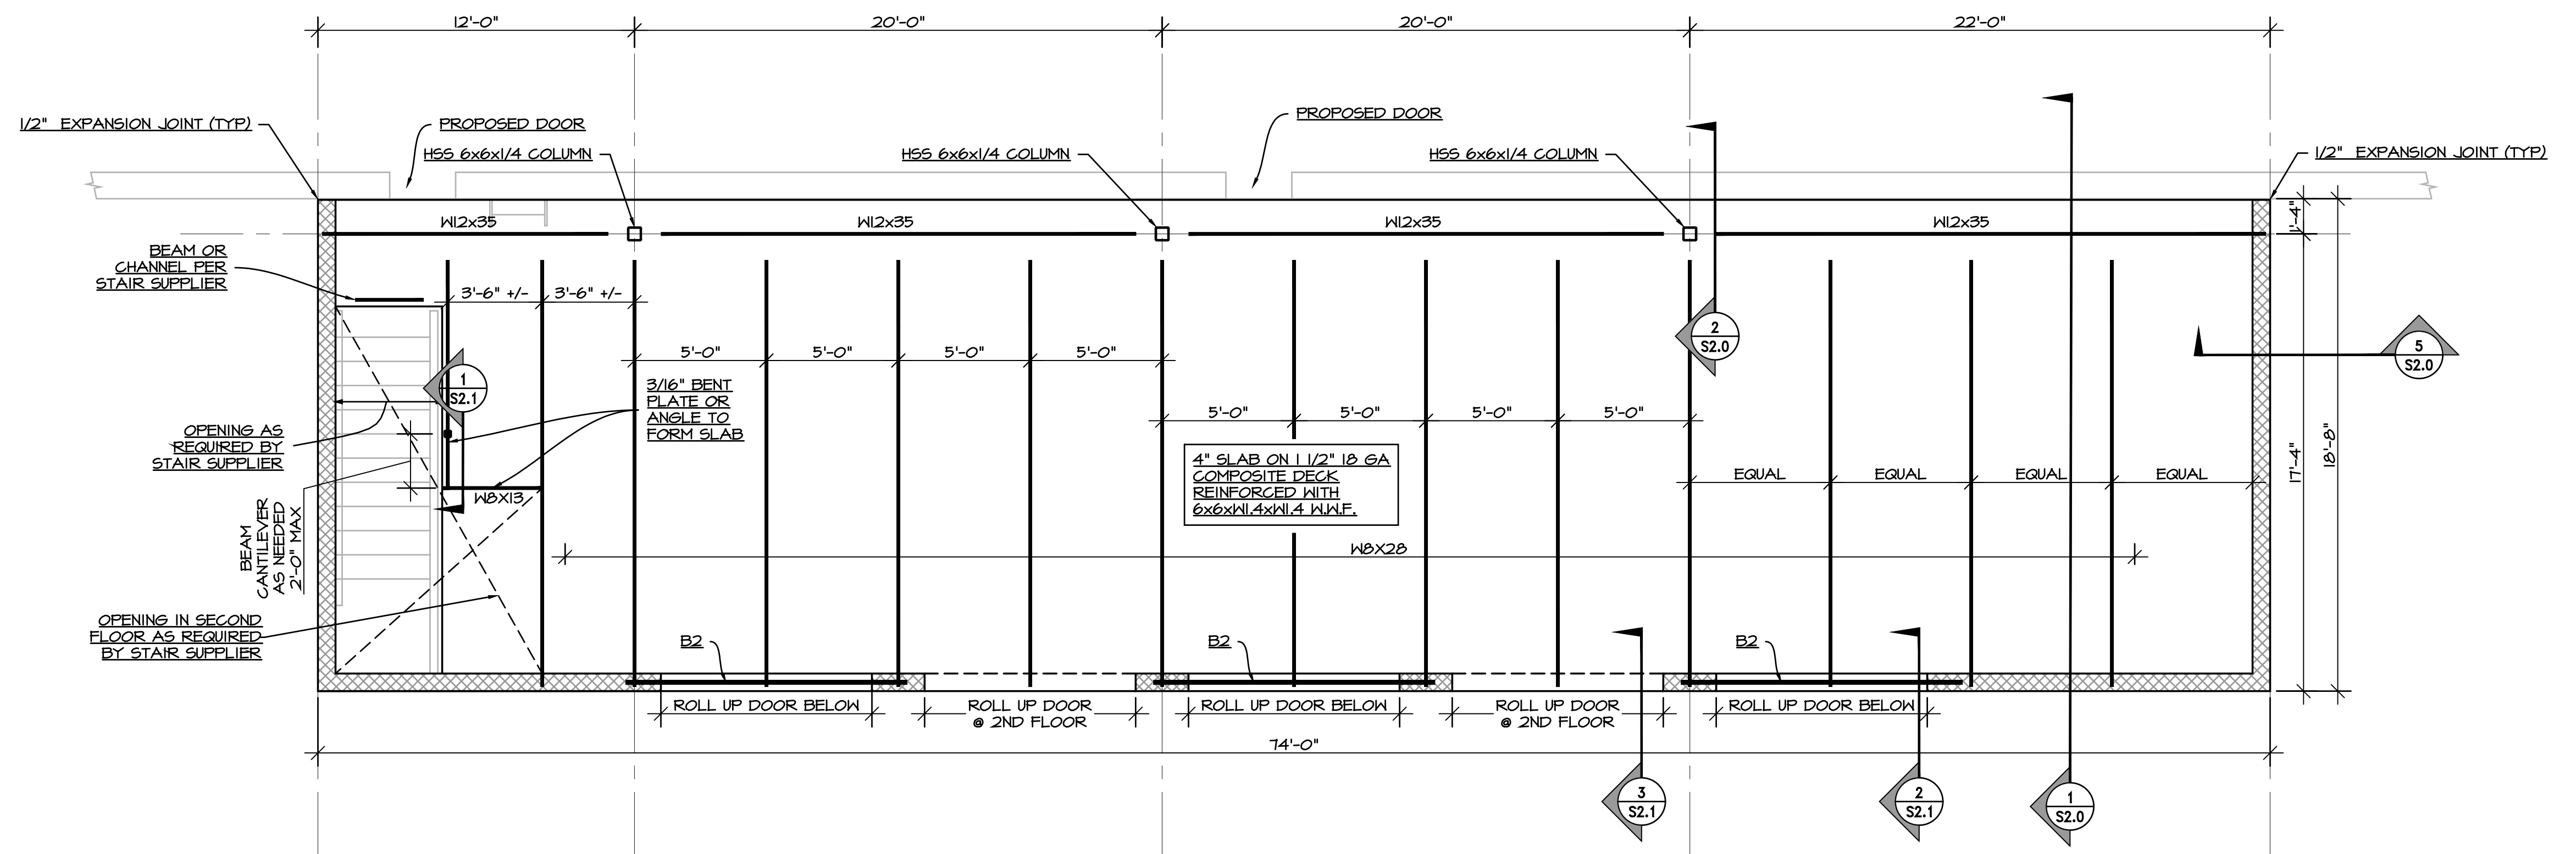


SECOND FLOOR FRAMING PLAN  
SCALE: 1/4" = 1'-0"

Revisions		
Revision	By	

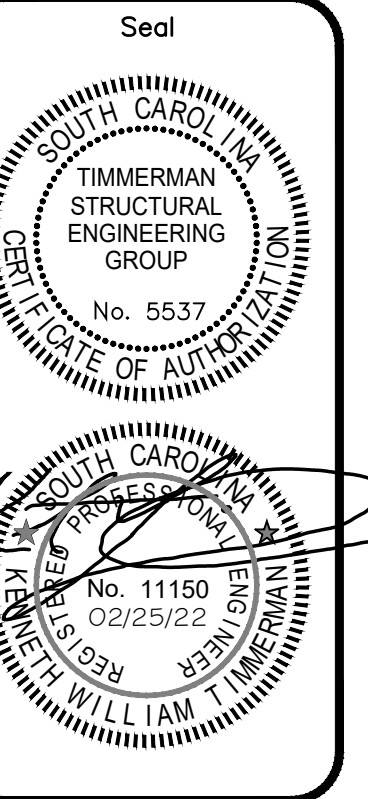

**RIVERBANKS ZOO & GARDEN BARN ADDITION**  
500 WILDLIFE PARKWAY  
COLUMBIA, SOUTH CAROLINA 29210





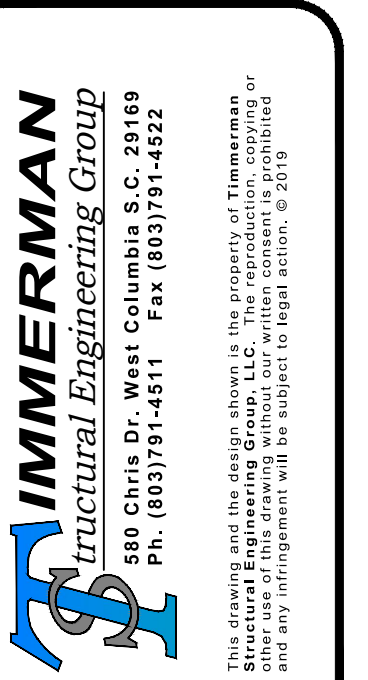


Drawing Title:	FRAMING PLAN
Scale:	AS NOTED
Job Number:	22-102
Designed By:	KWT
Drawn By:	TJD
Checked By:	KWT
Date:	02/25/2022

Sheet Number  
**S1.1**  
Sheet 2 of 7


FOR CONSTRUCTION



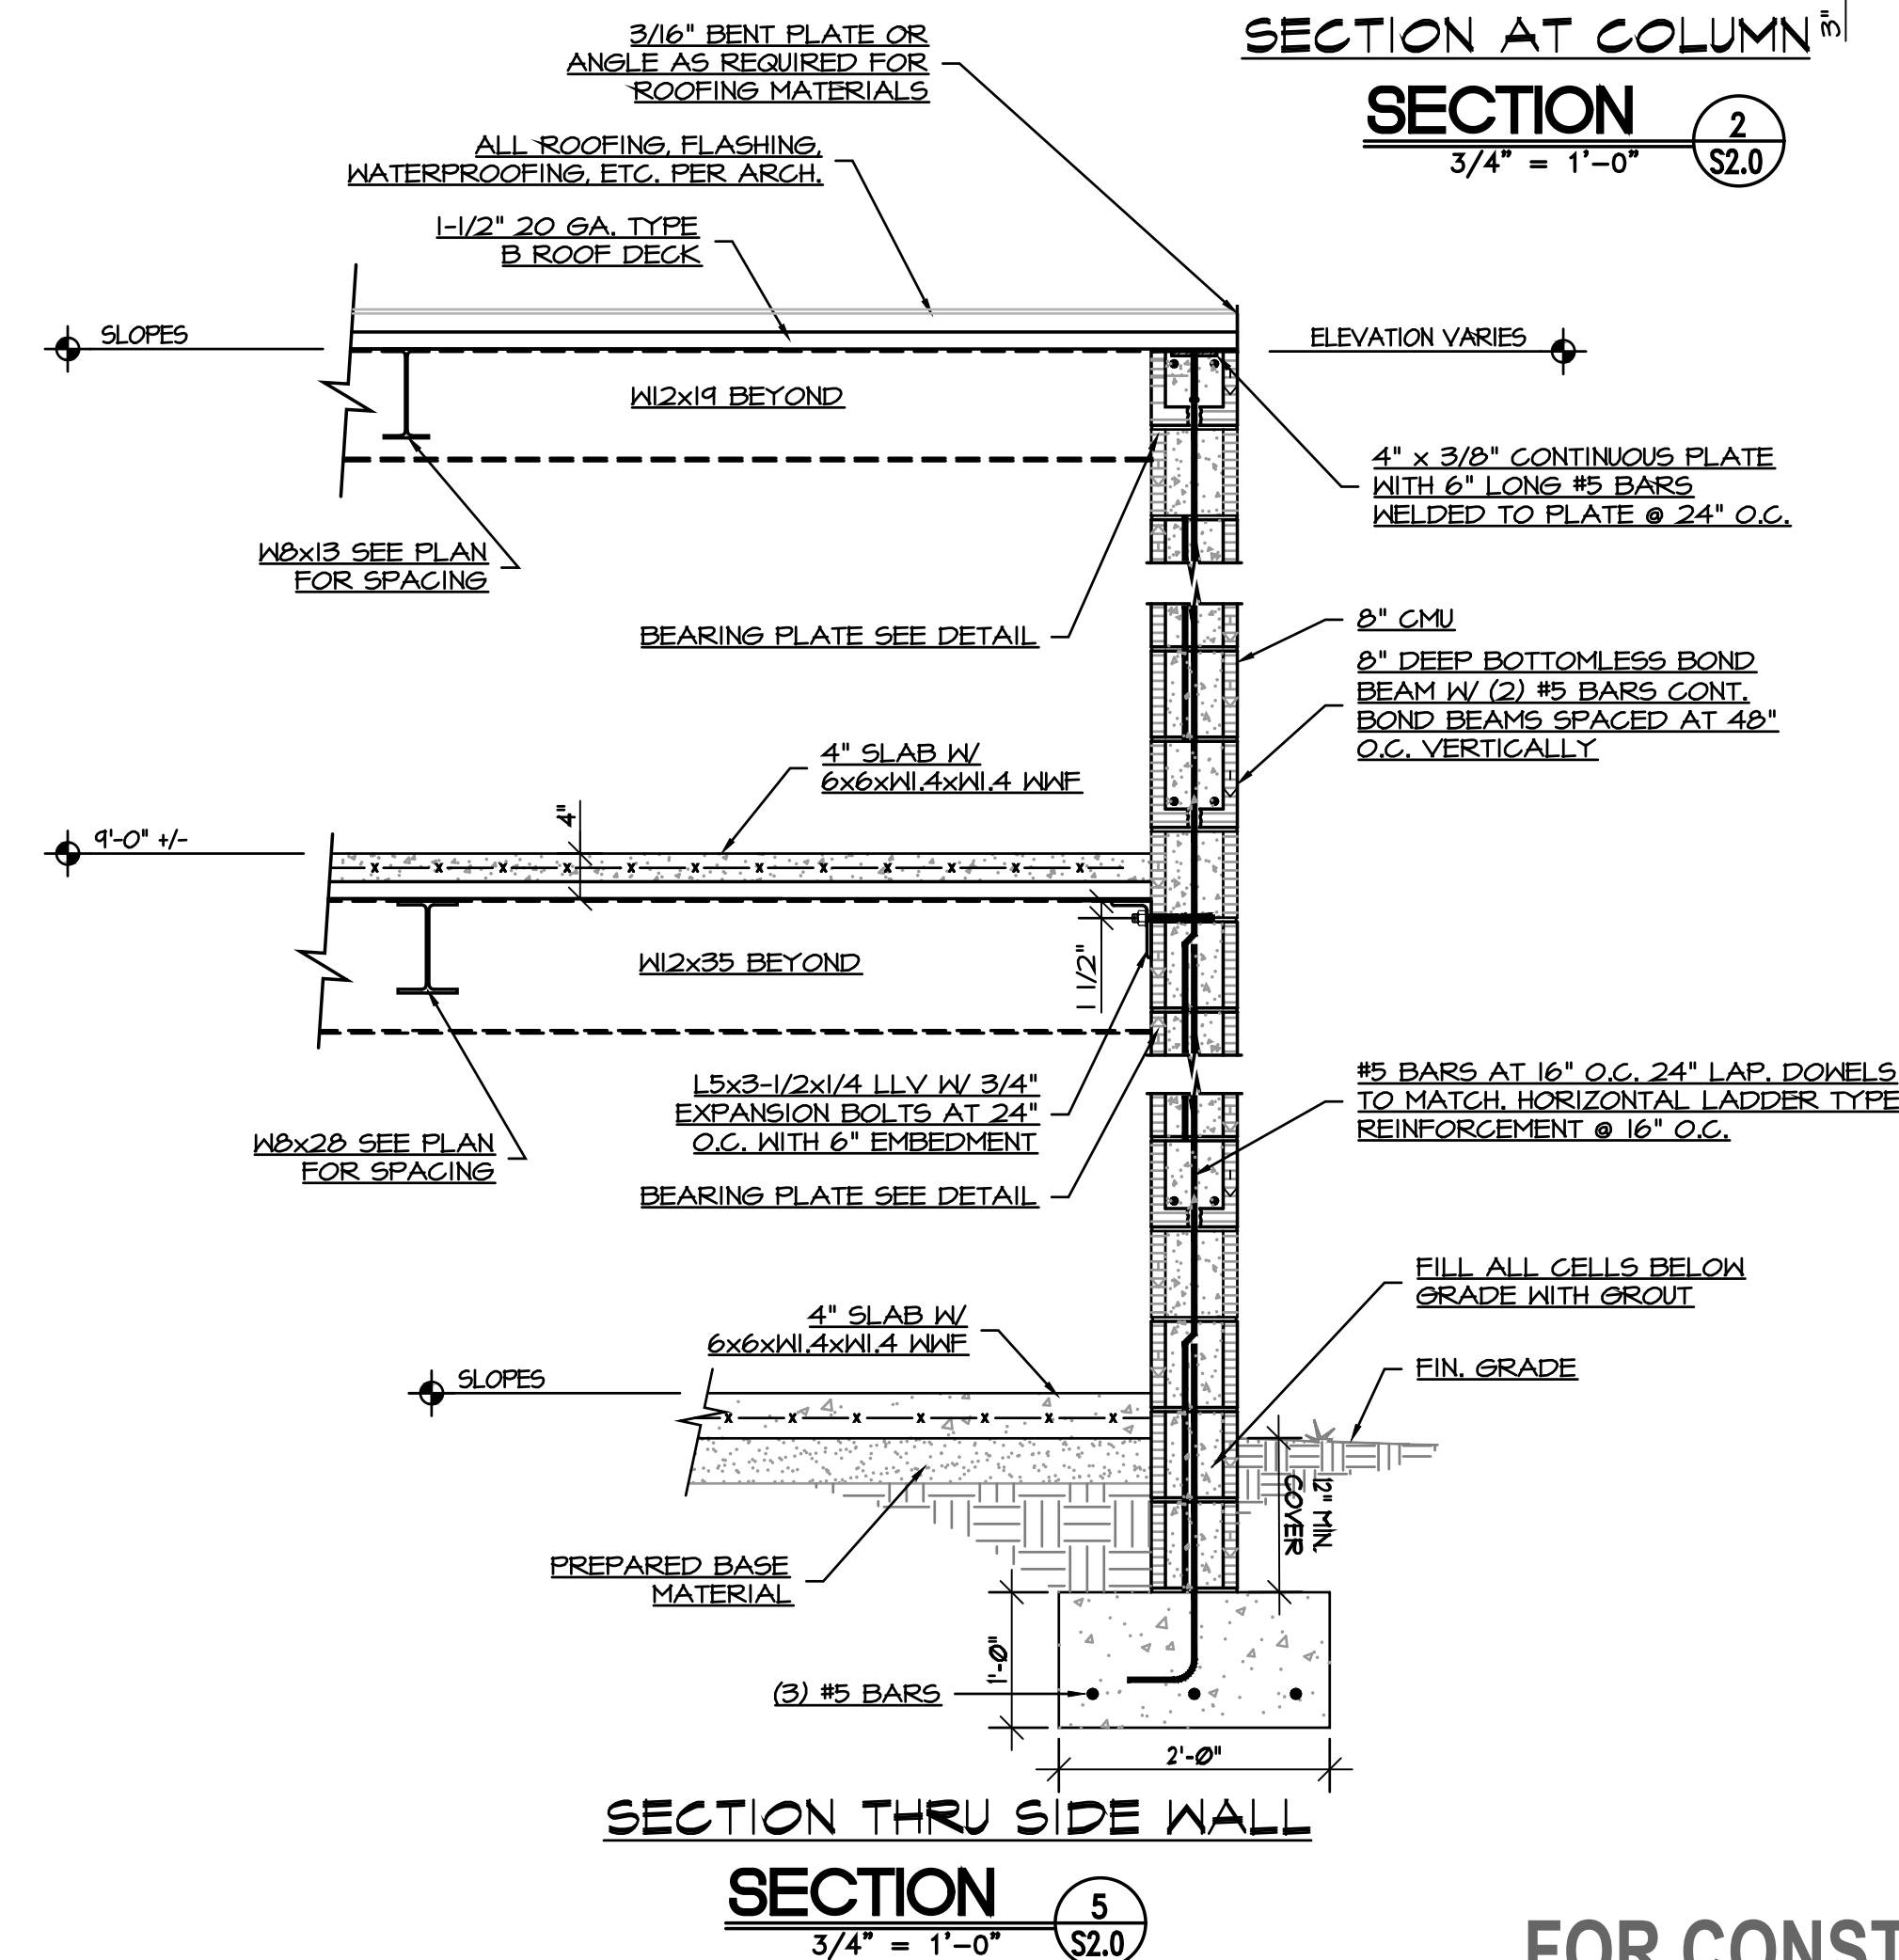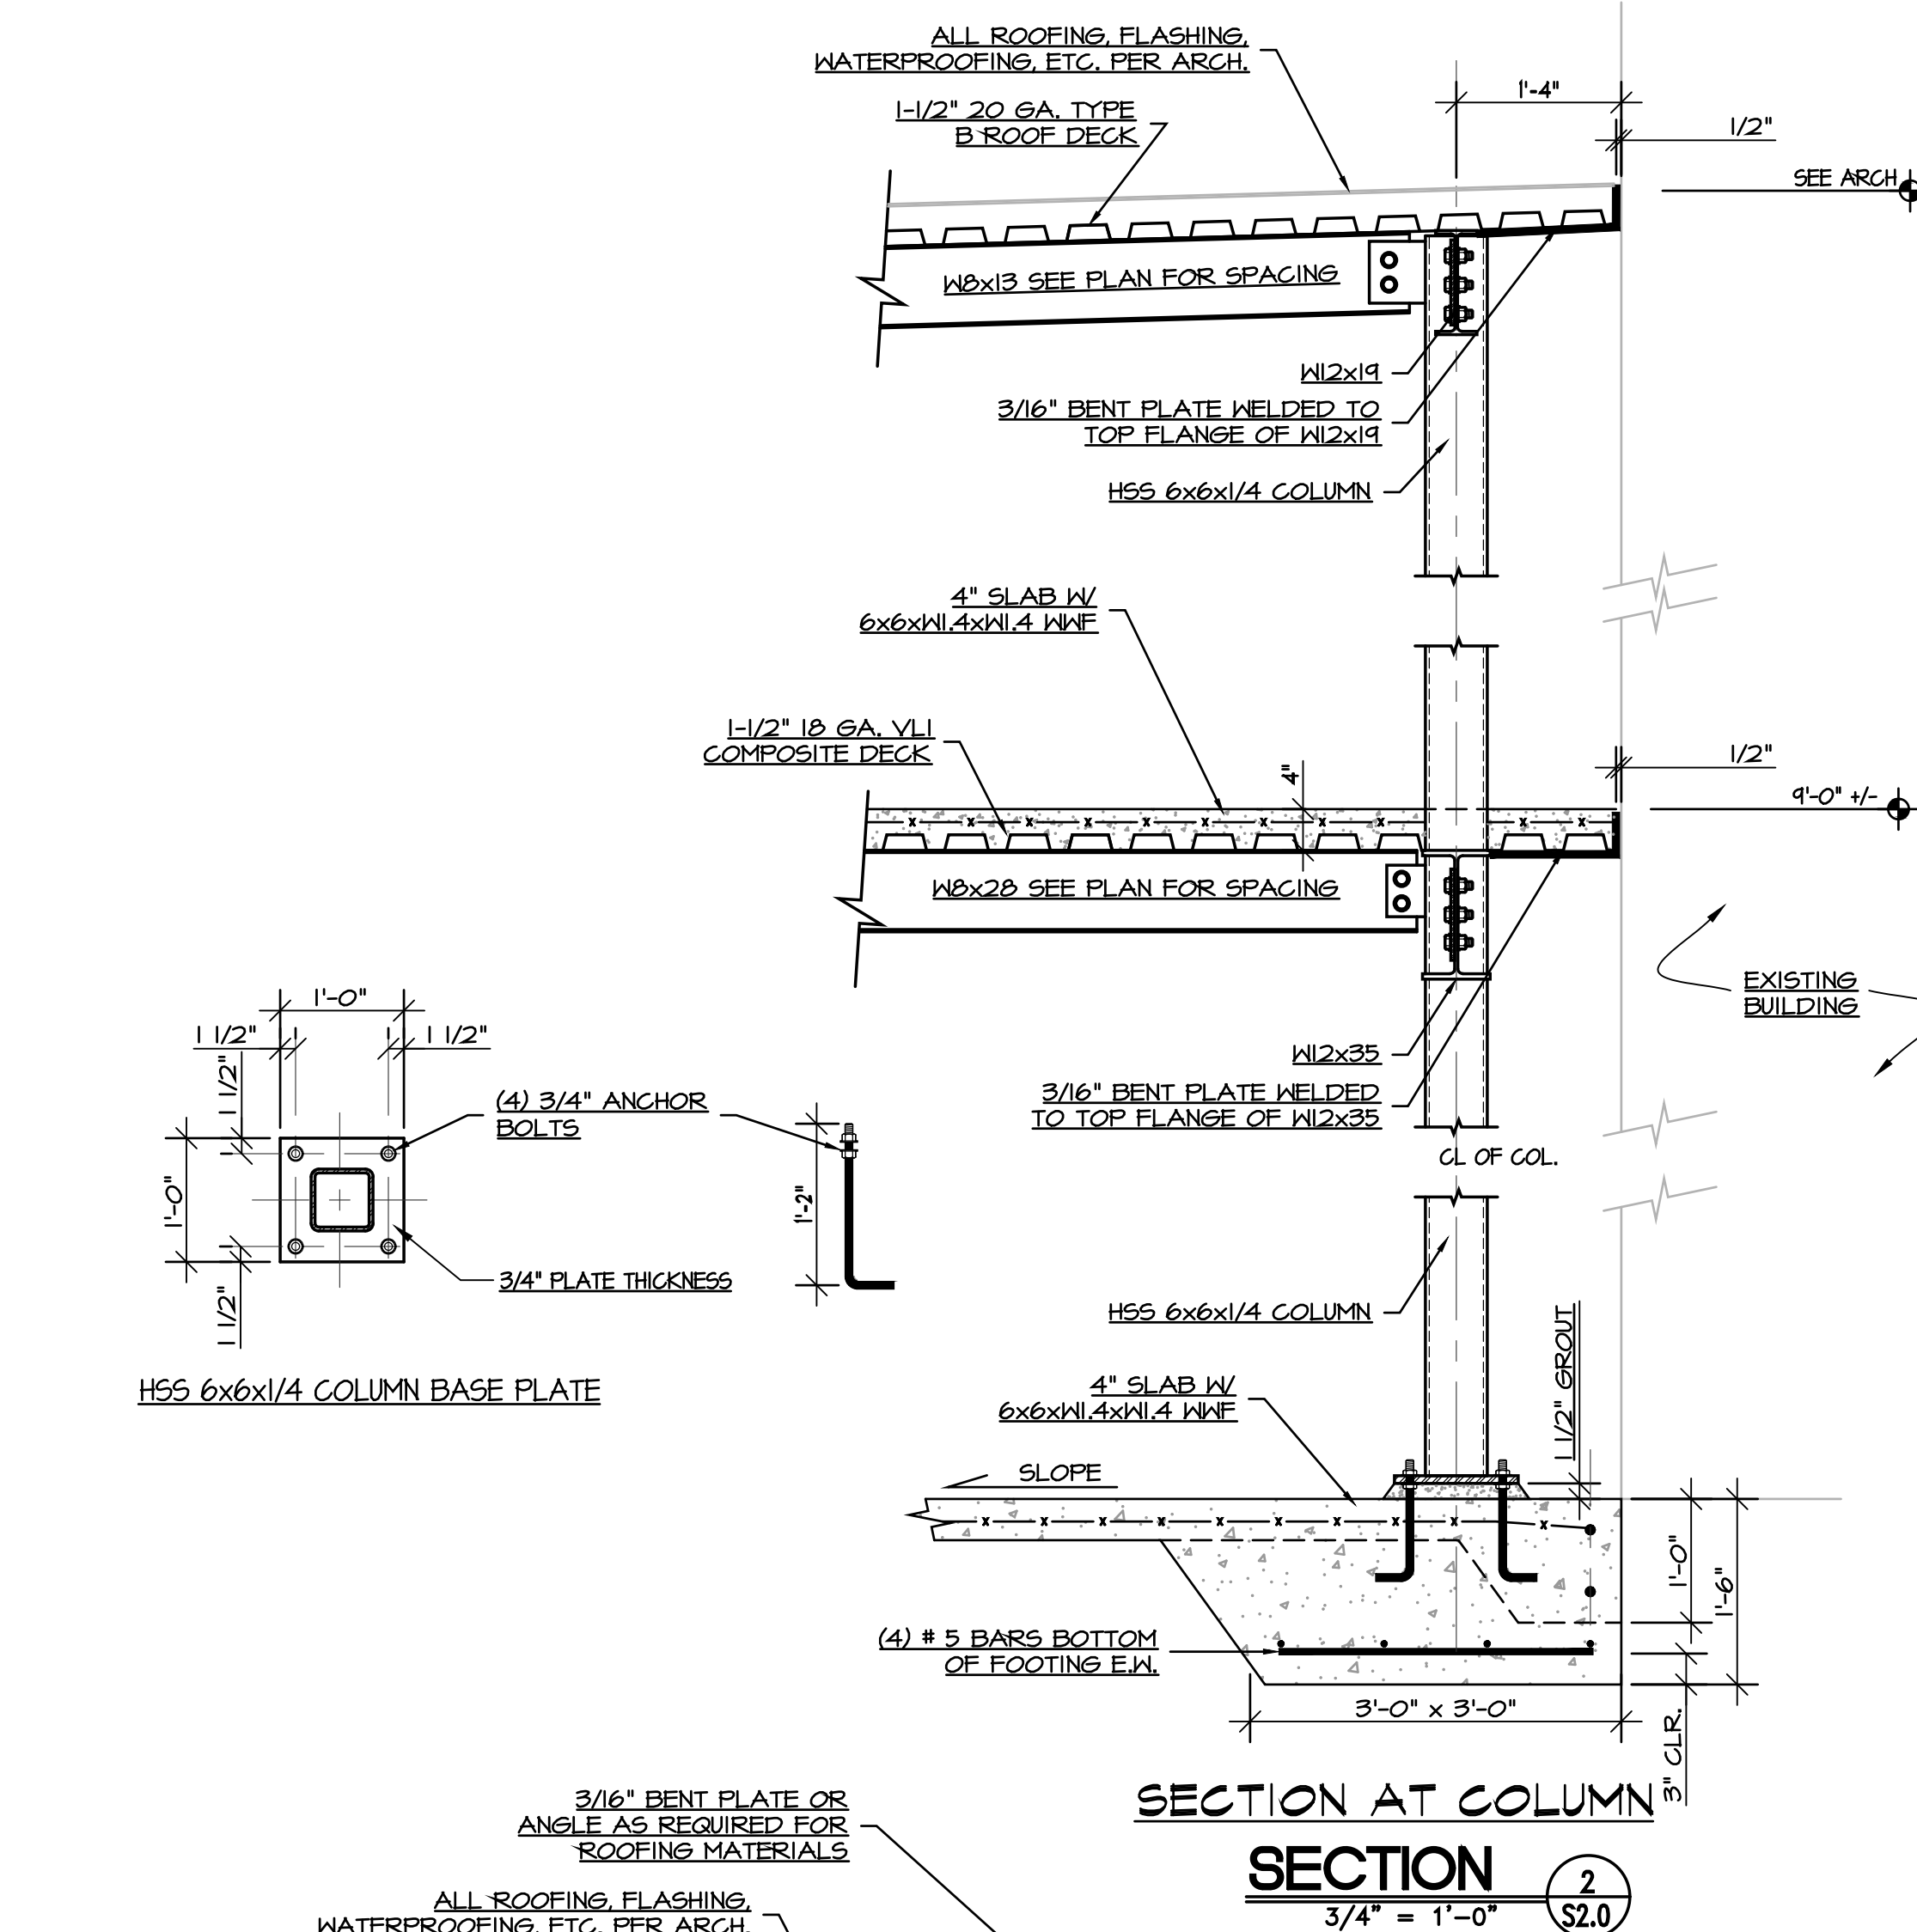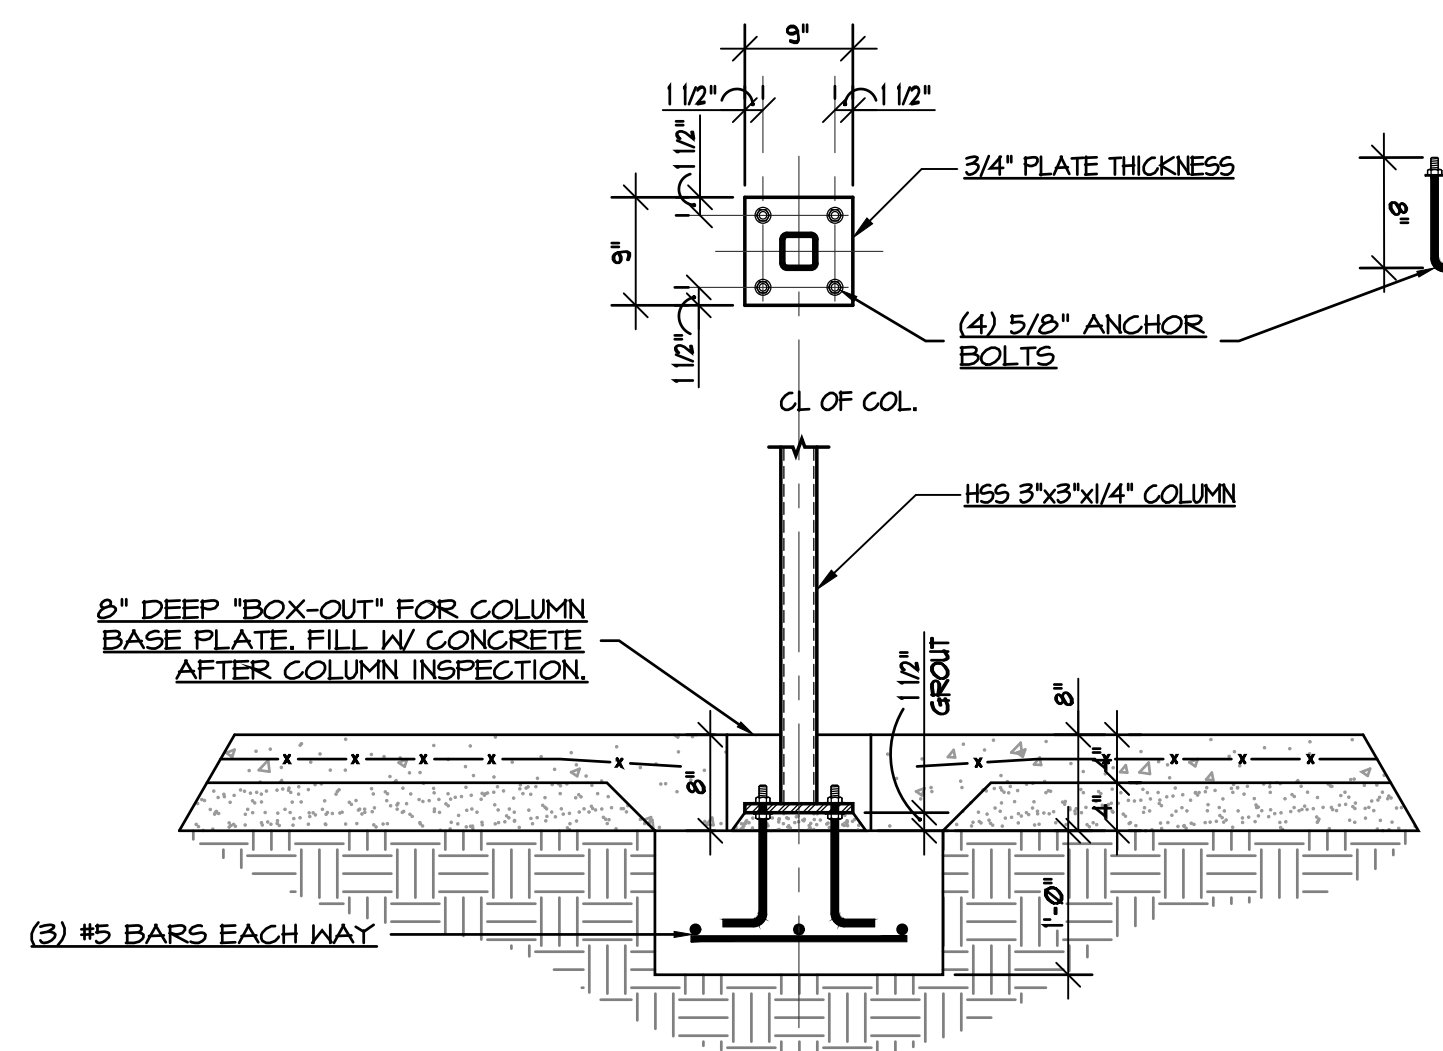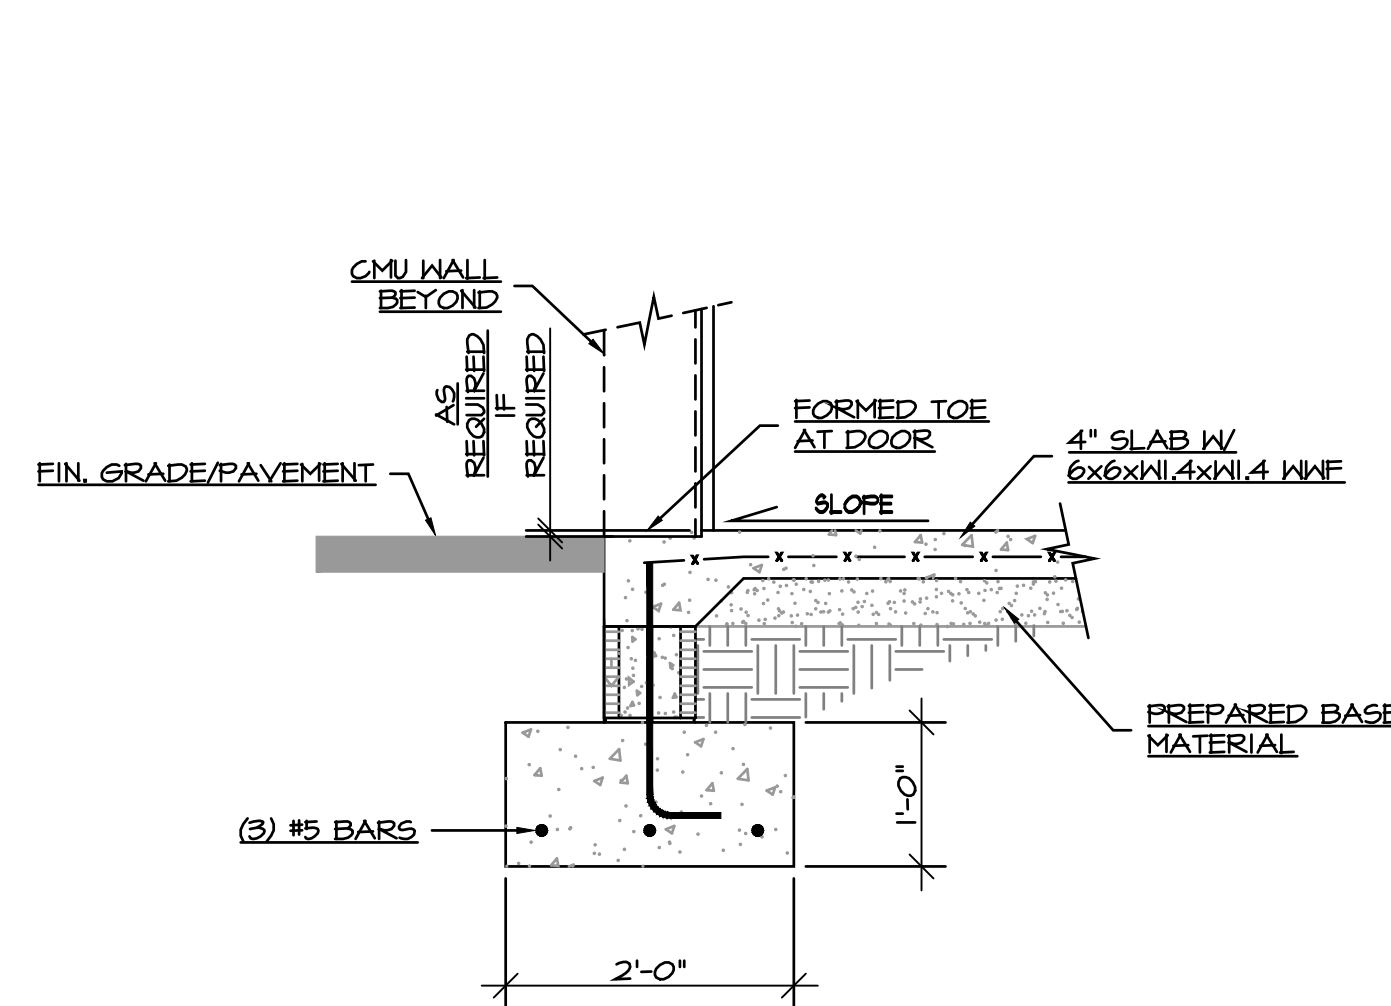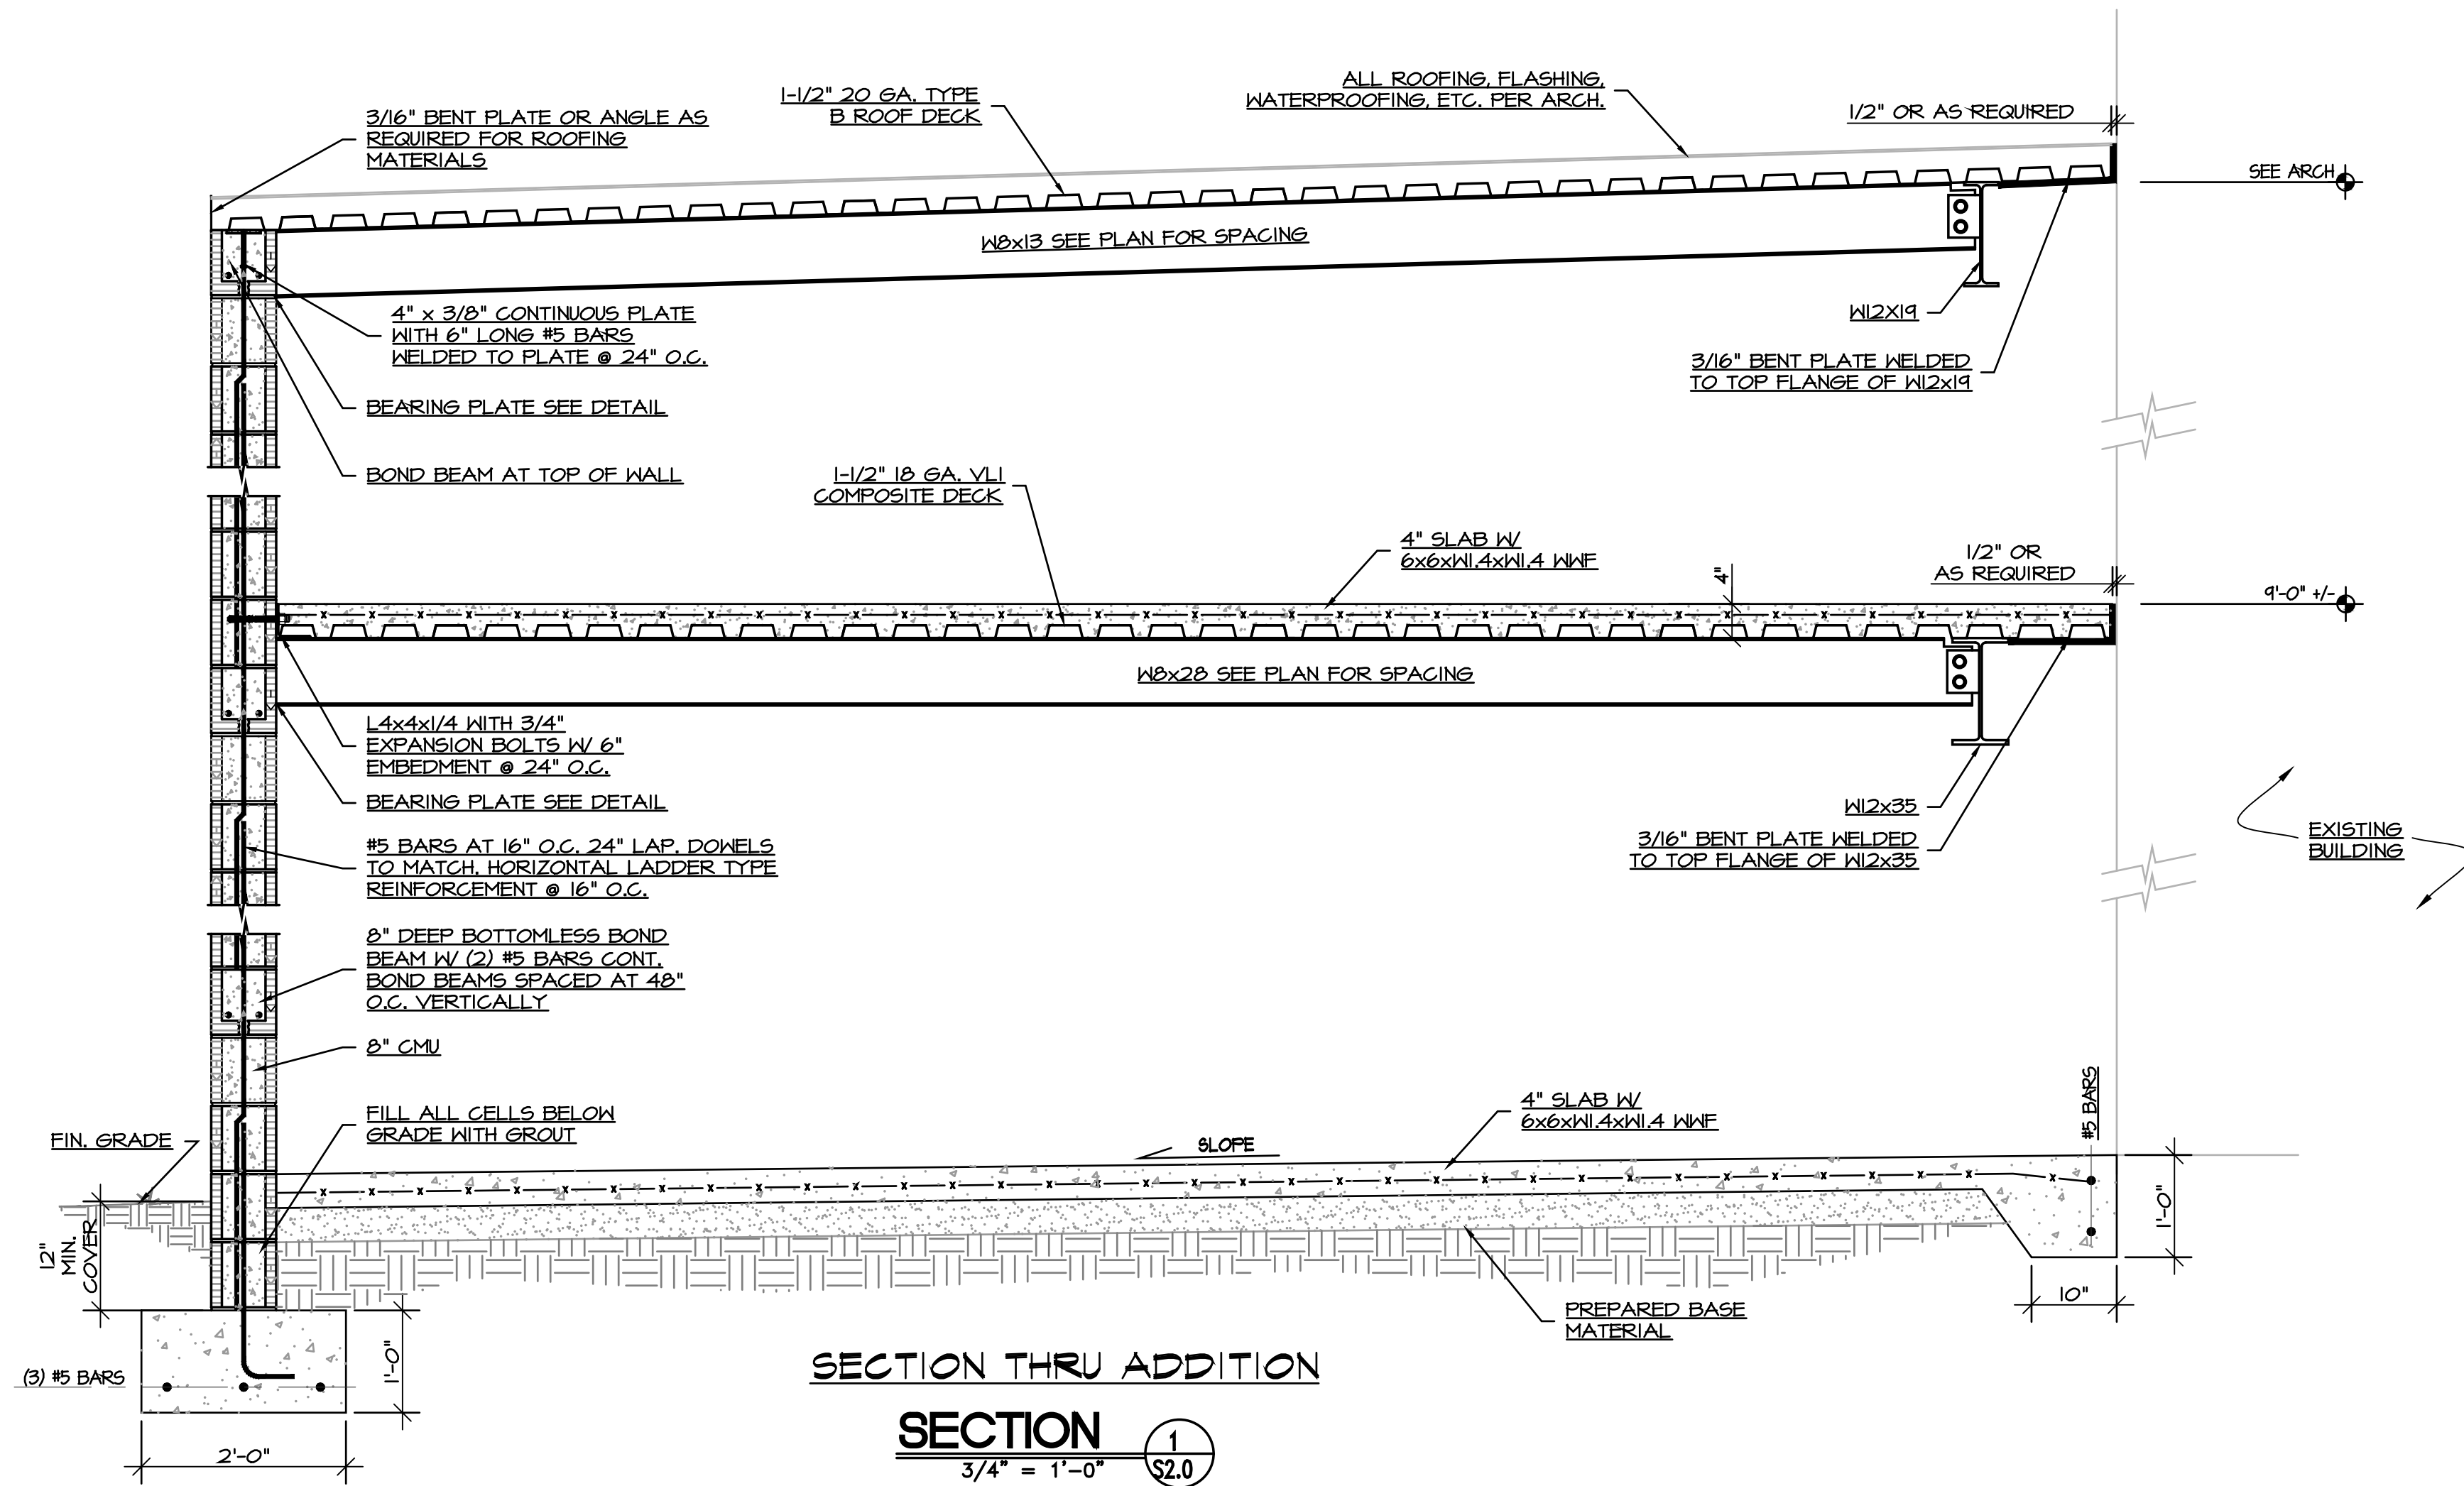


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Revisions	
Revision	By

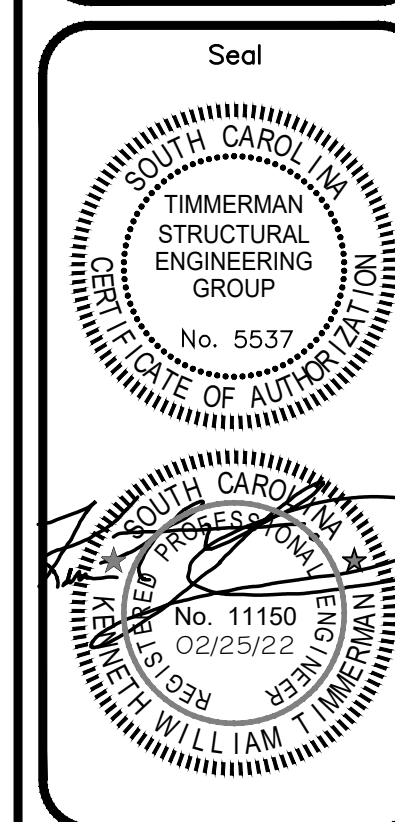

**RIVERBANKS ZOO & GARDEN BARN ADDITION**  
500 WILDLIFE PARKWAY  
COLUMBIA, SOUTH CAROLINA 29210

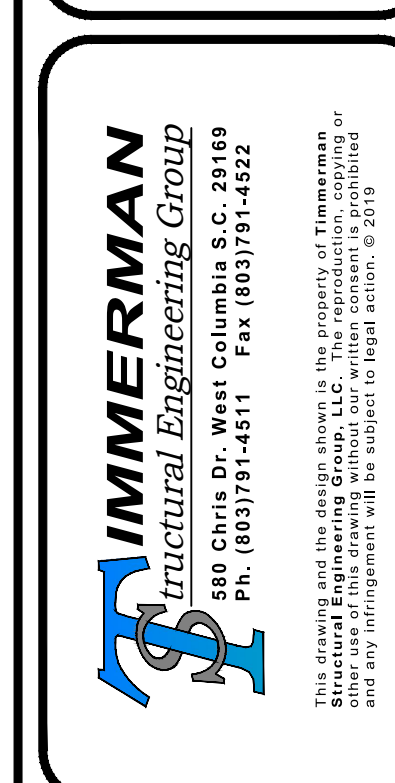

Drawing Title:  
**FOUNDATION SECTIONS**

Scale: AS NOTED

Job Number: 22-102

Designed By: KWT


Drawn By: TJD

Checked By: KWT

Date: 02/25/2022


Sheet Number  
**S2.0**  
Sheet 3 of 7



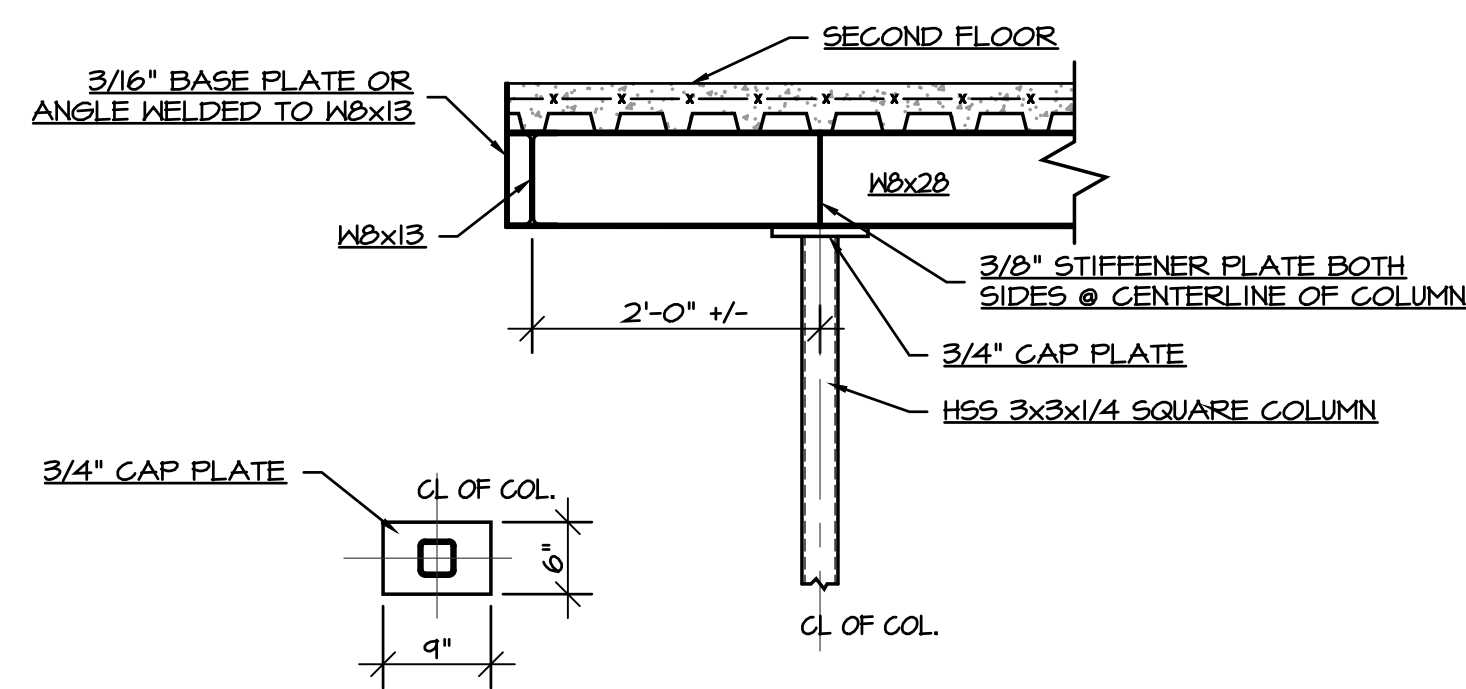


CONNECTION @ HSS 3x3x1/4 & W8x28

SECTION 1  
3/4" = 1'-0"

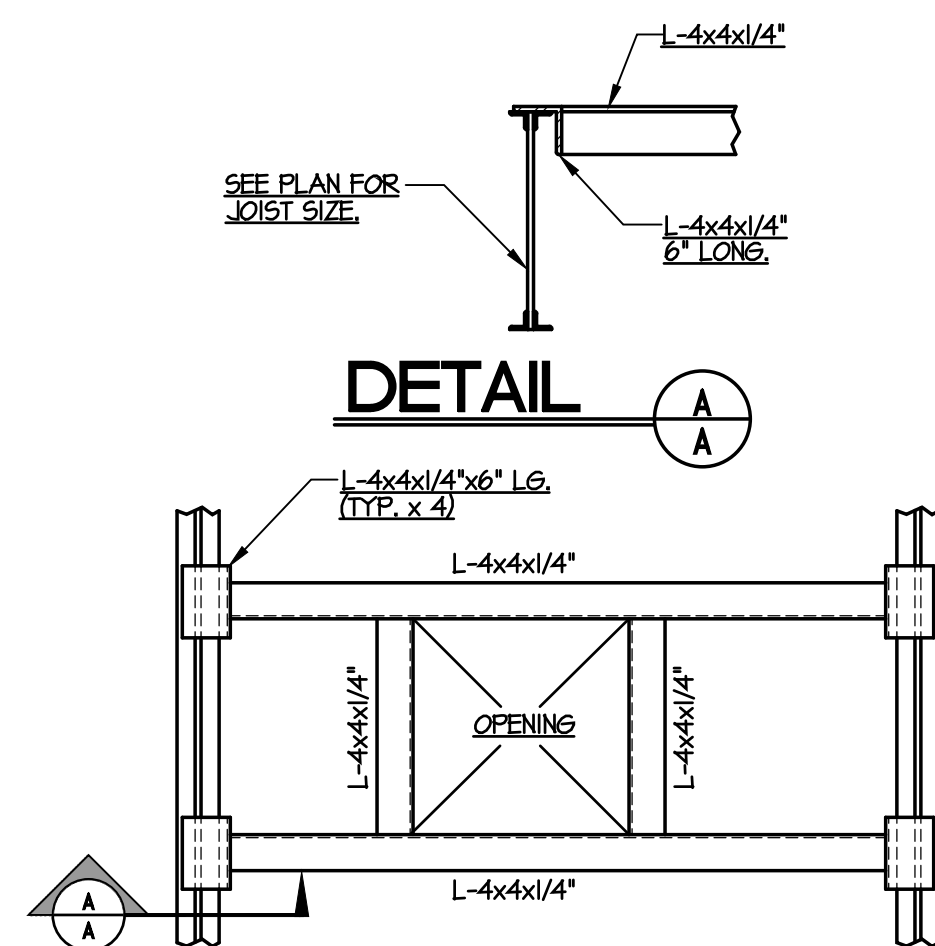


TYP. ROOF PENETRATION FRAMING

NOTE: CONTRACTOR SHALL INSTALL A 1/4" THICK PLATE FOR FULL WIDTH OF THE SUPPORTING BARJOIST(S) AND BEAM(S) AS NEEDED TO PROVIDE CONTINUOUS BEARING FOR SUPPORT CURBS. FRAMING NOT REQUIRED FOR PENETRATIONS 12"x12" OR 12" DIAMETER AND SMALLER.

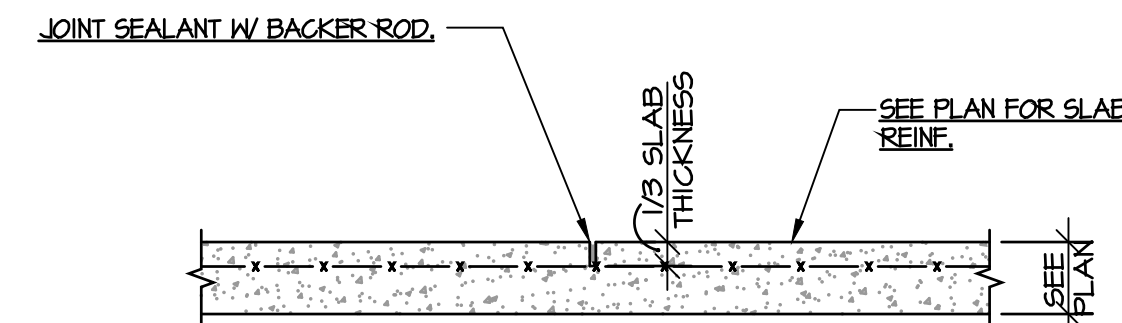


TYPICAL SAW JOINT "SJ" DETAIL

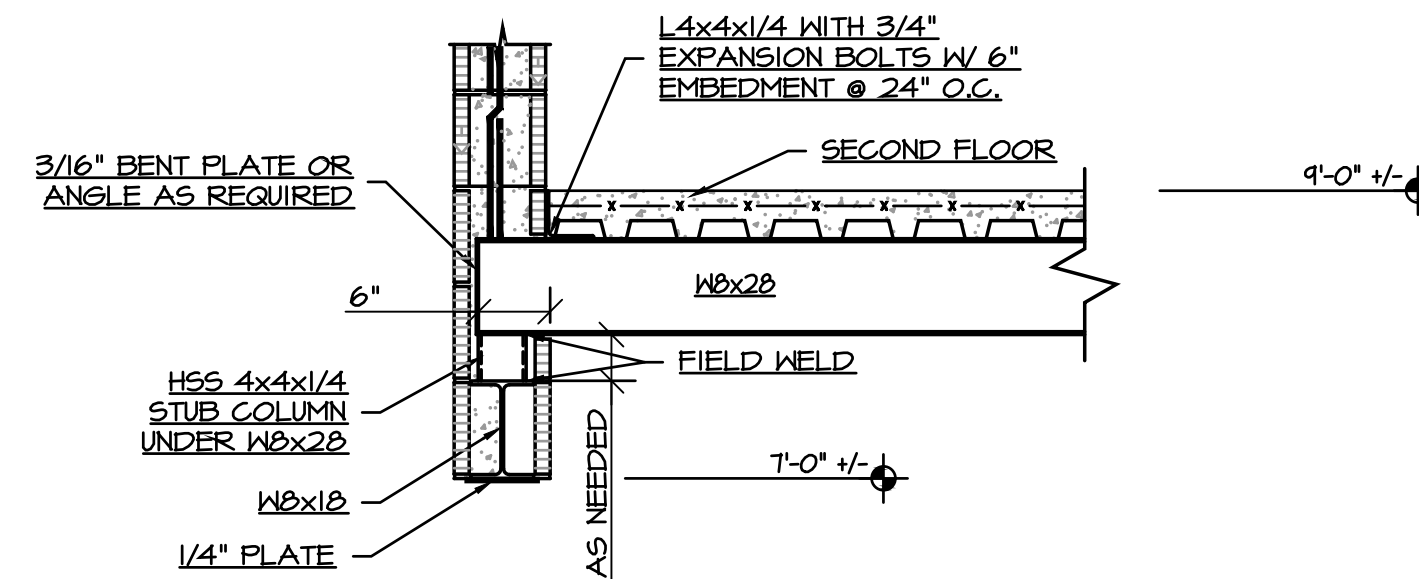


LINTEL DETAIL


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LADDER @ ROOF HATCH SECTION


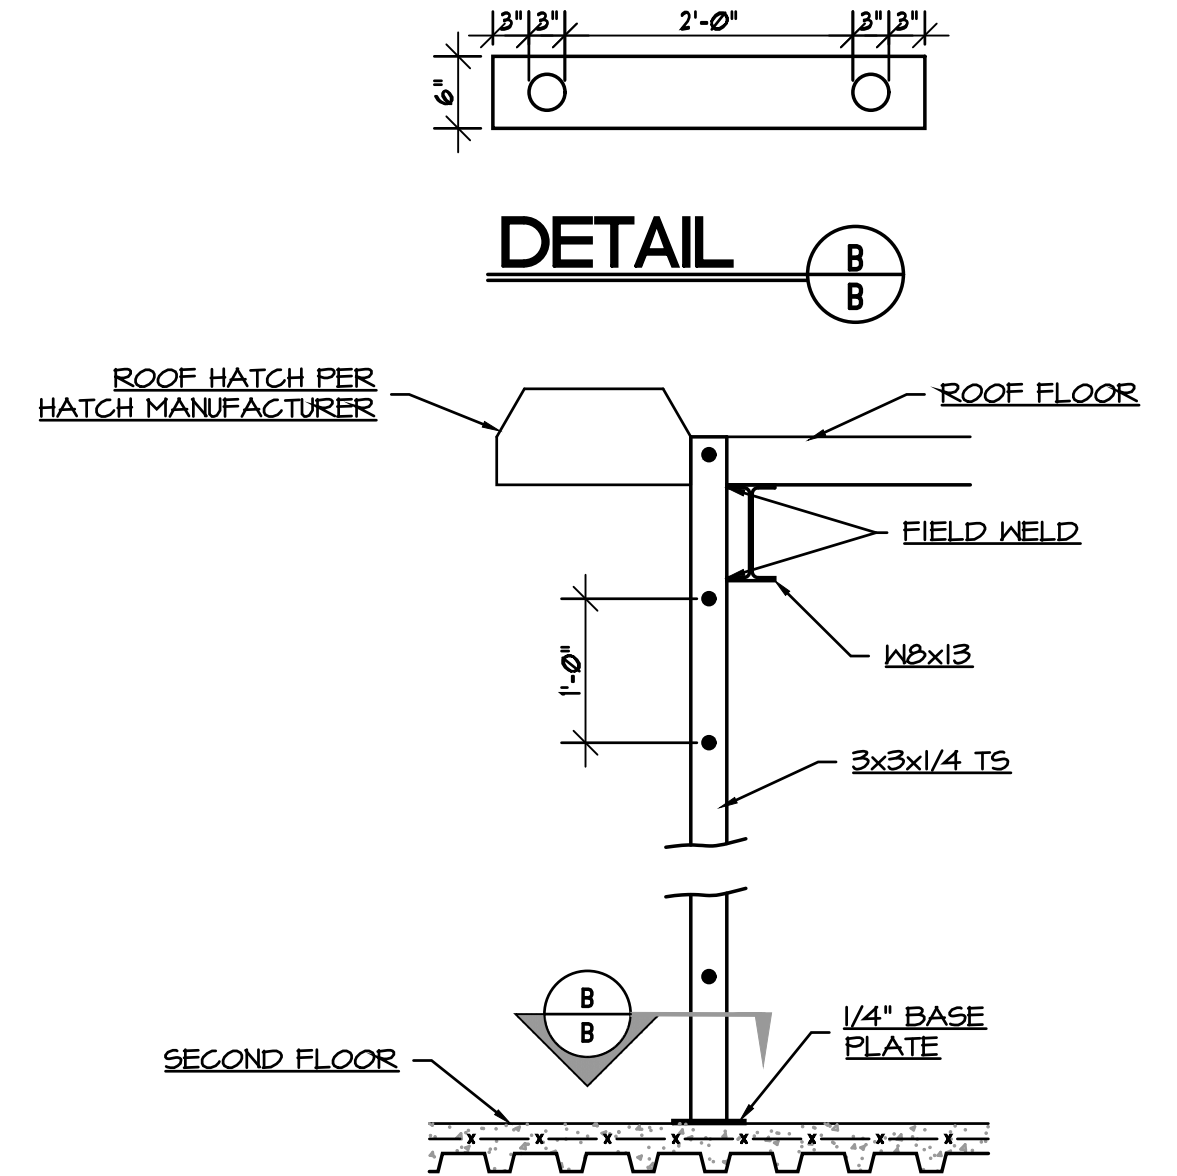


TYP. SECTION @ STAIR FOUNDATION

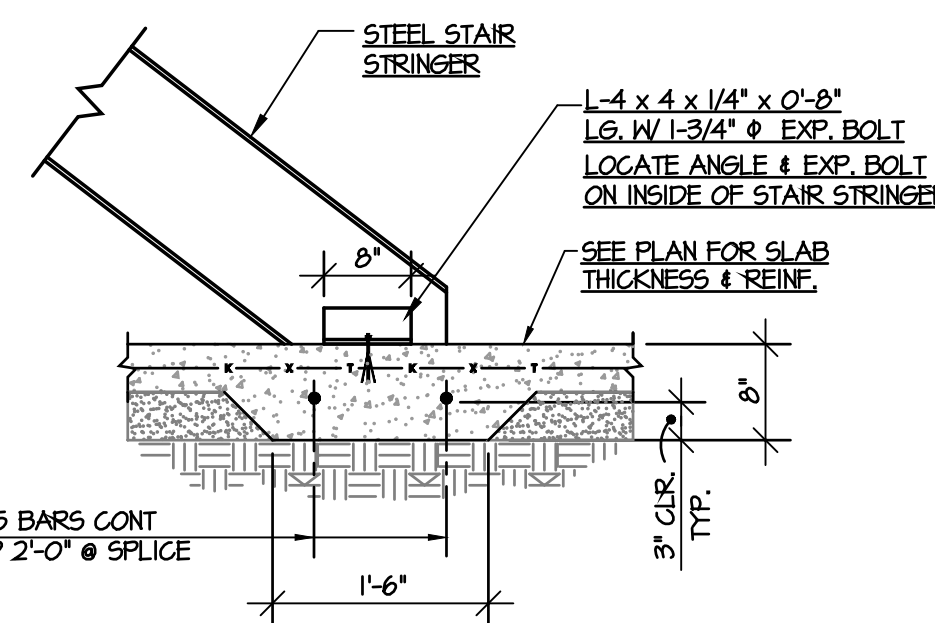

SECTION THROUGH SECOND FLOOR DOORWAY

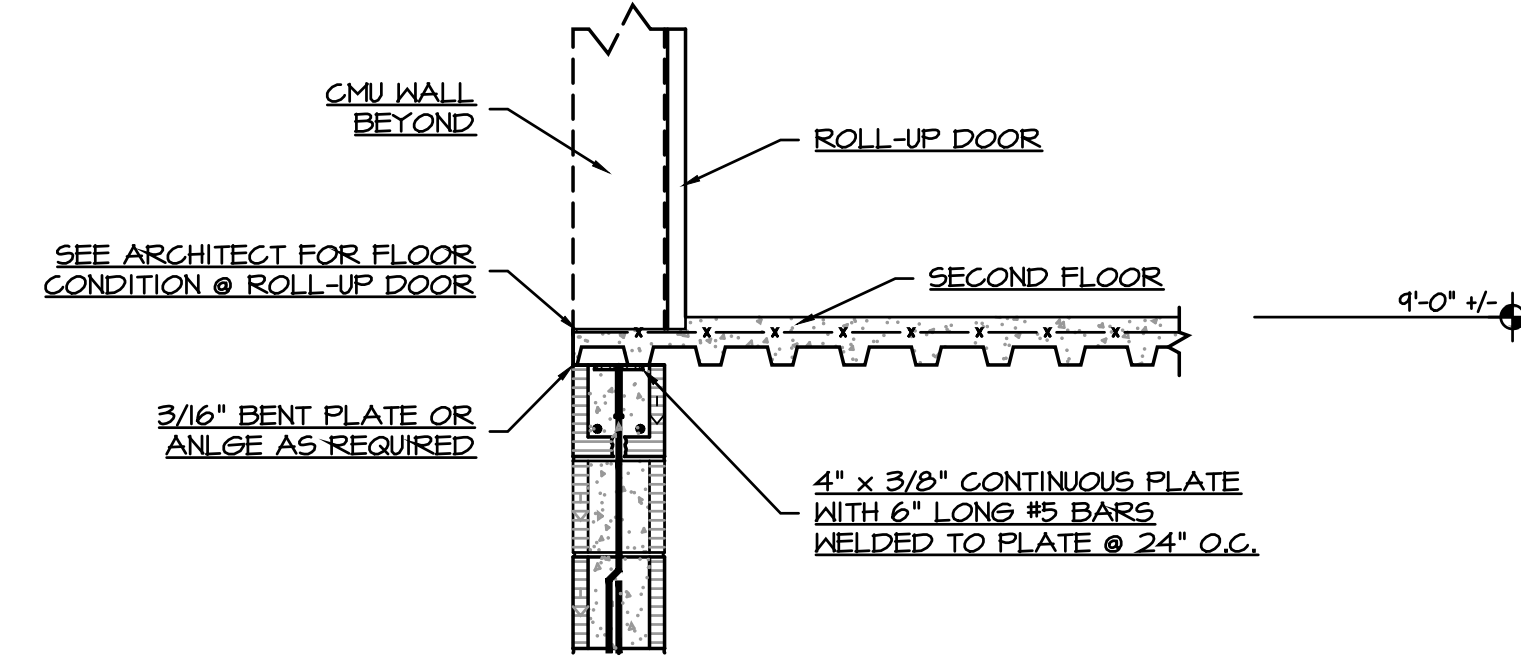
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3/4" = 1'-0"

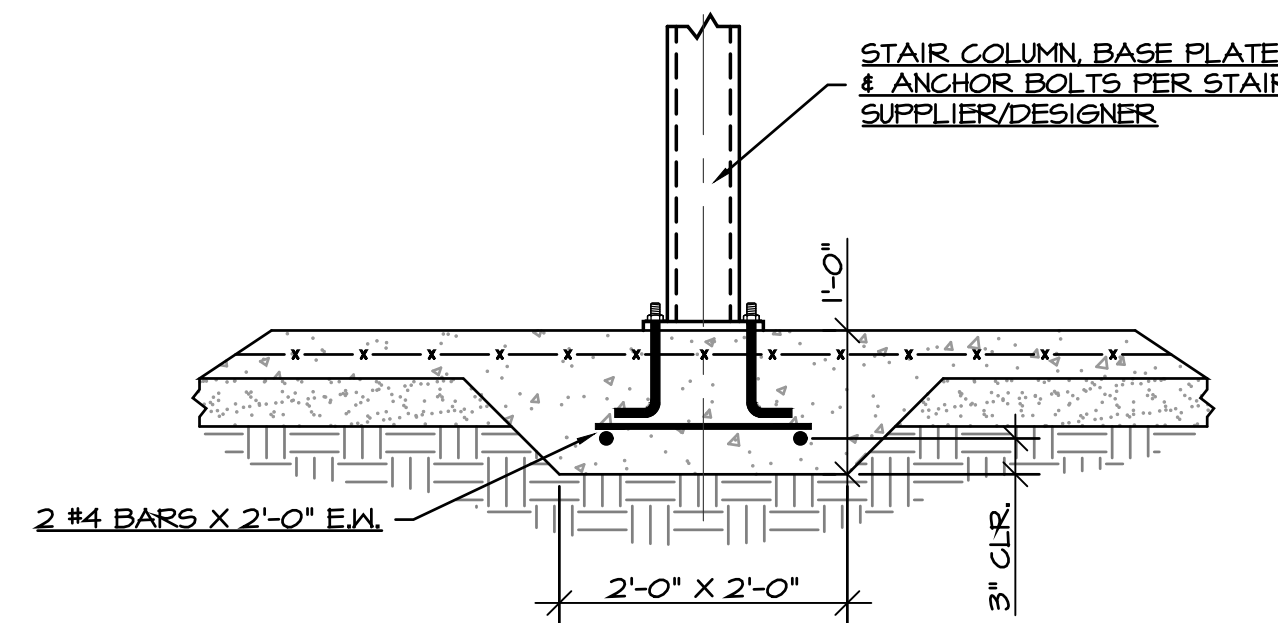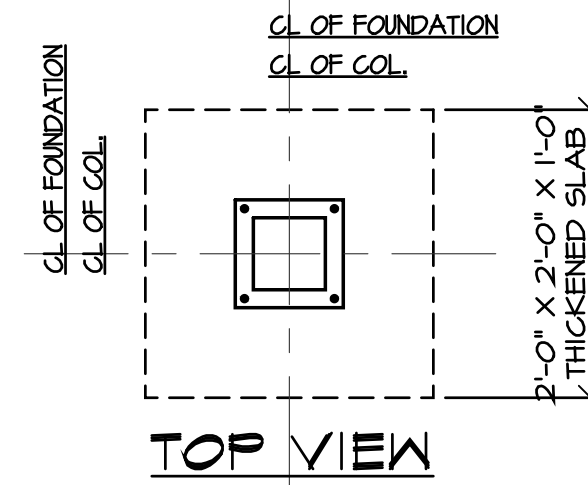


NOTE: THIS DETAIL MAY BE AT SEVERAL LOCATIONS. SEE STAIR SUPPLIERS DRAWINGS FOR LOCATIONS.

FOR CONSTRUCTION

Revisions	
Revision	By

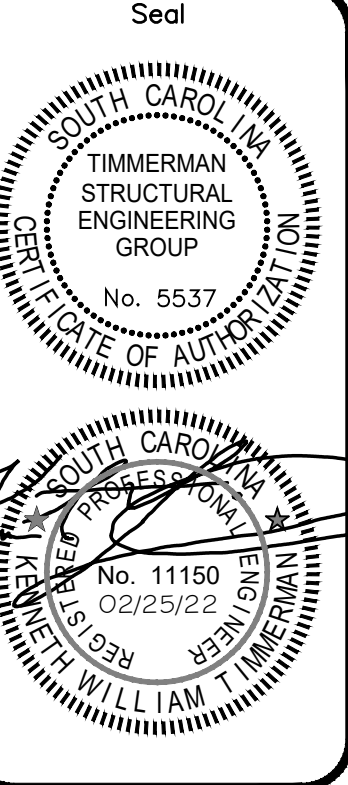











RIVERBANKS ZOO & GARDEN BARN ADDITION  
500 WILDLIFE PARKWAY  
COLUMBIA, SOUTH CAROLINA 29210

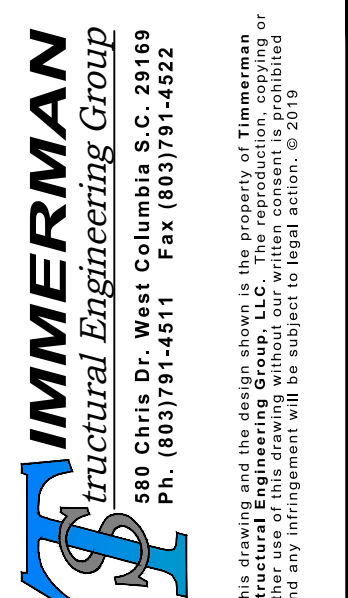

Drawing Title:	
SECTIONS CONTINUED	
Scale:	AS NOTED
Job Number:	22-102
Designed By:	KWT
Drawn By:	TJD
Checked By:	KWT
Date:	02/25/2022


Sheet Number  
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FOR CONSTRUCTION

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Revision	By

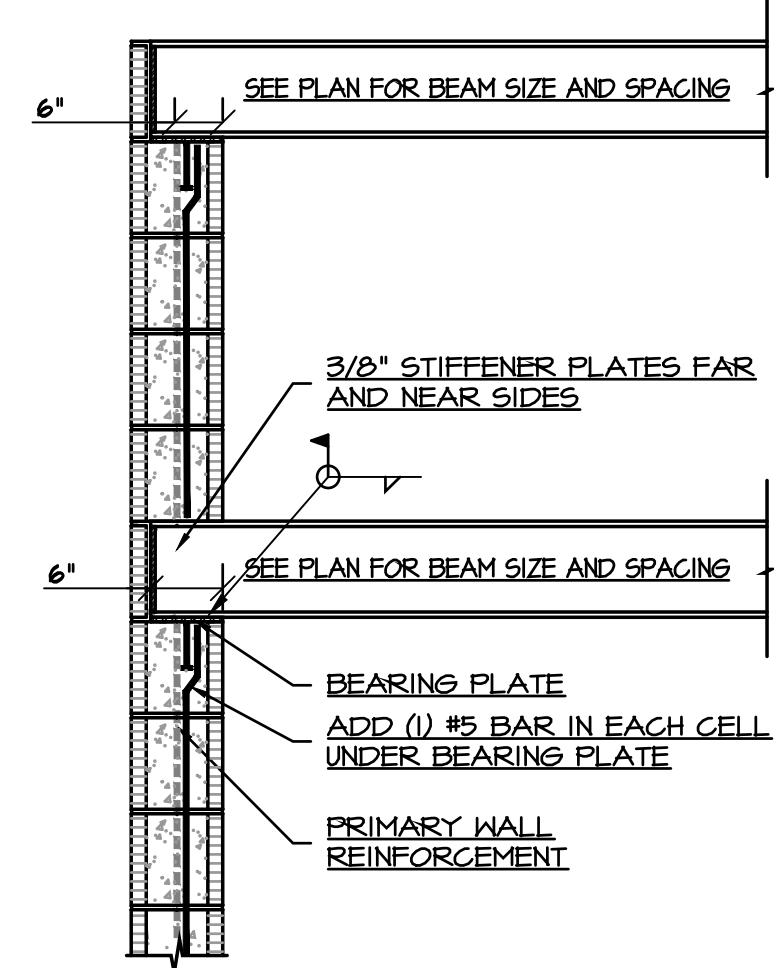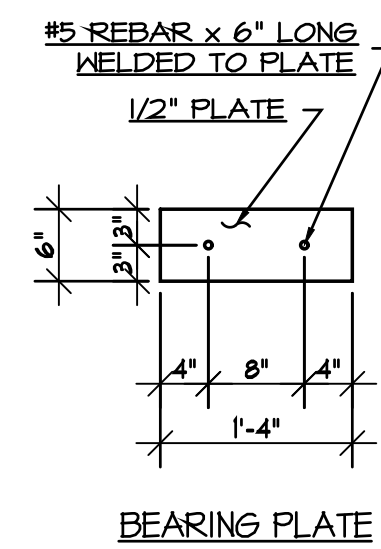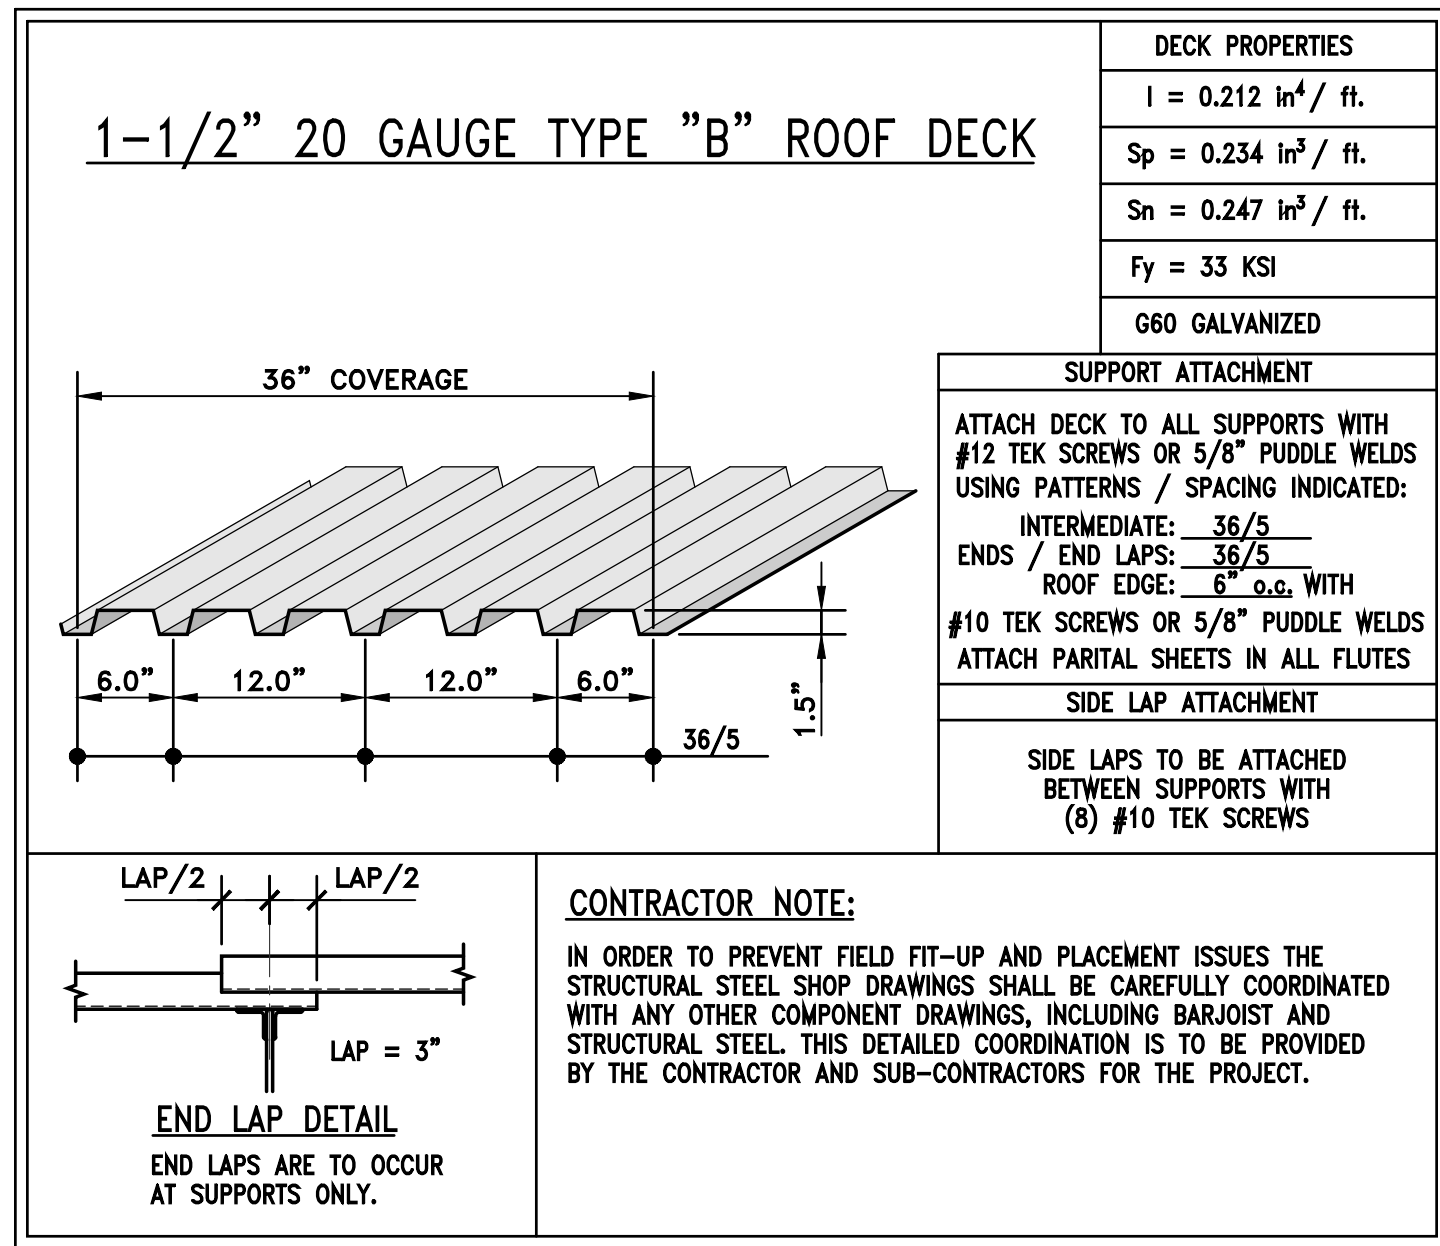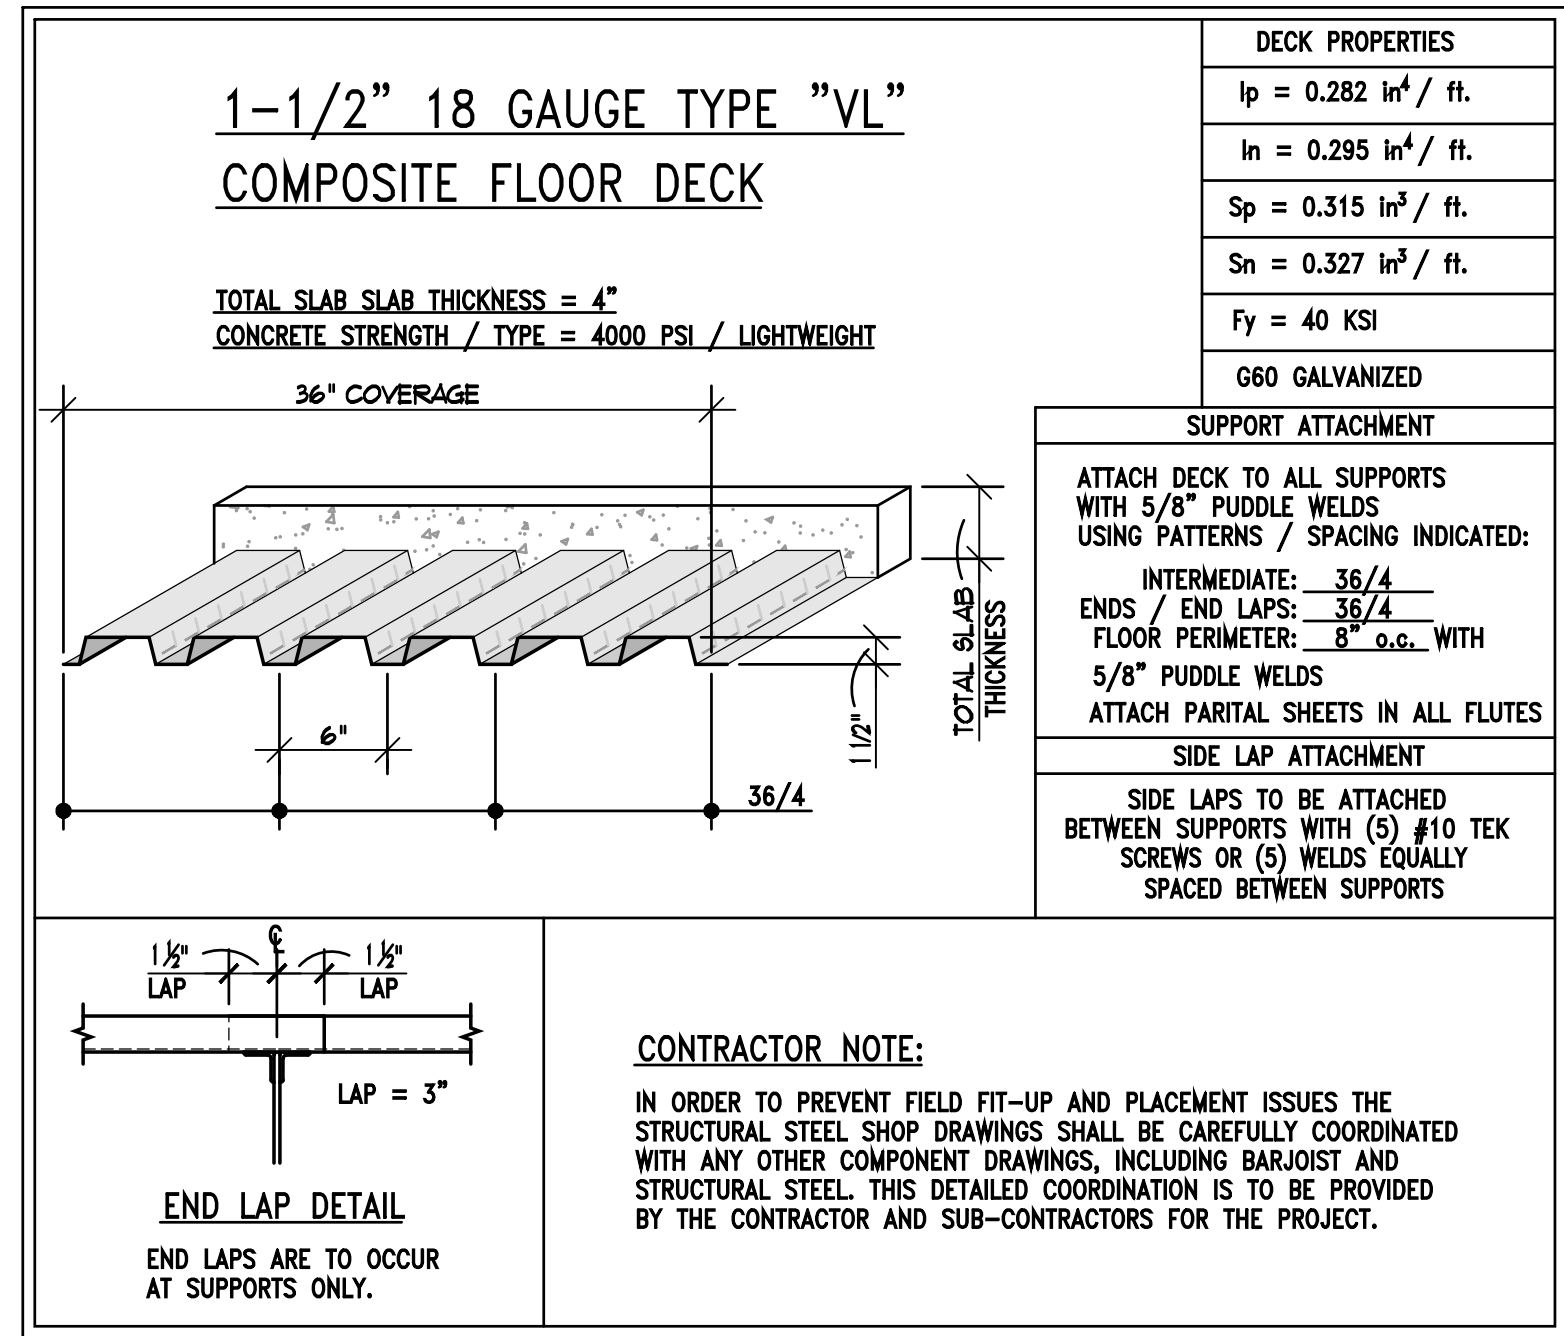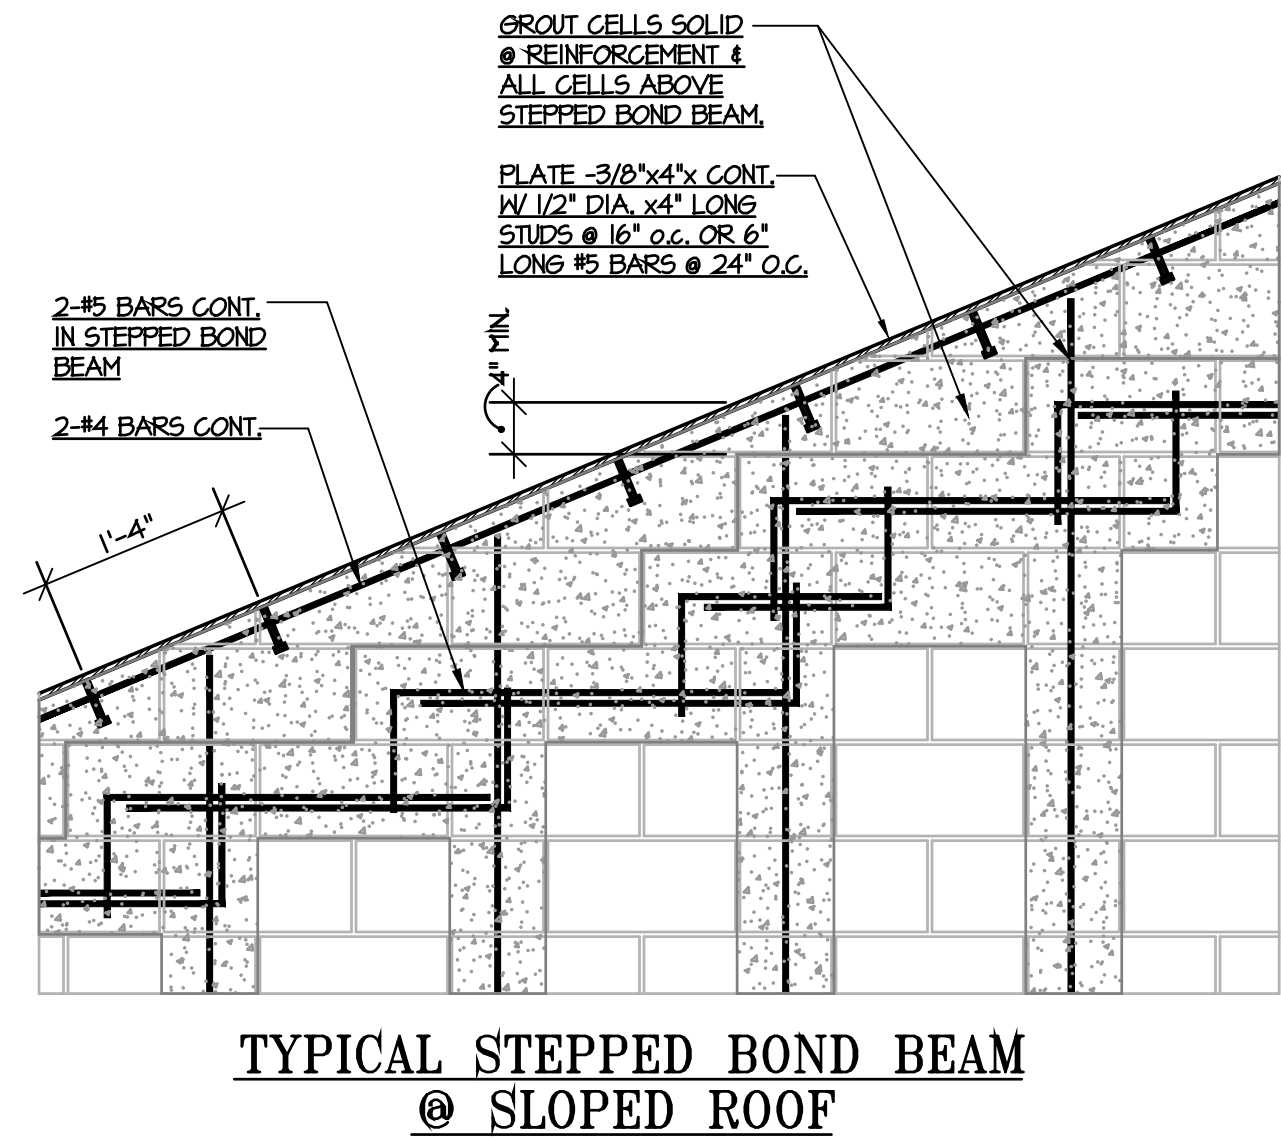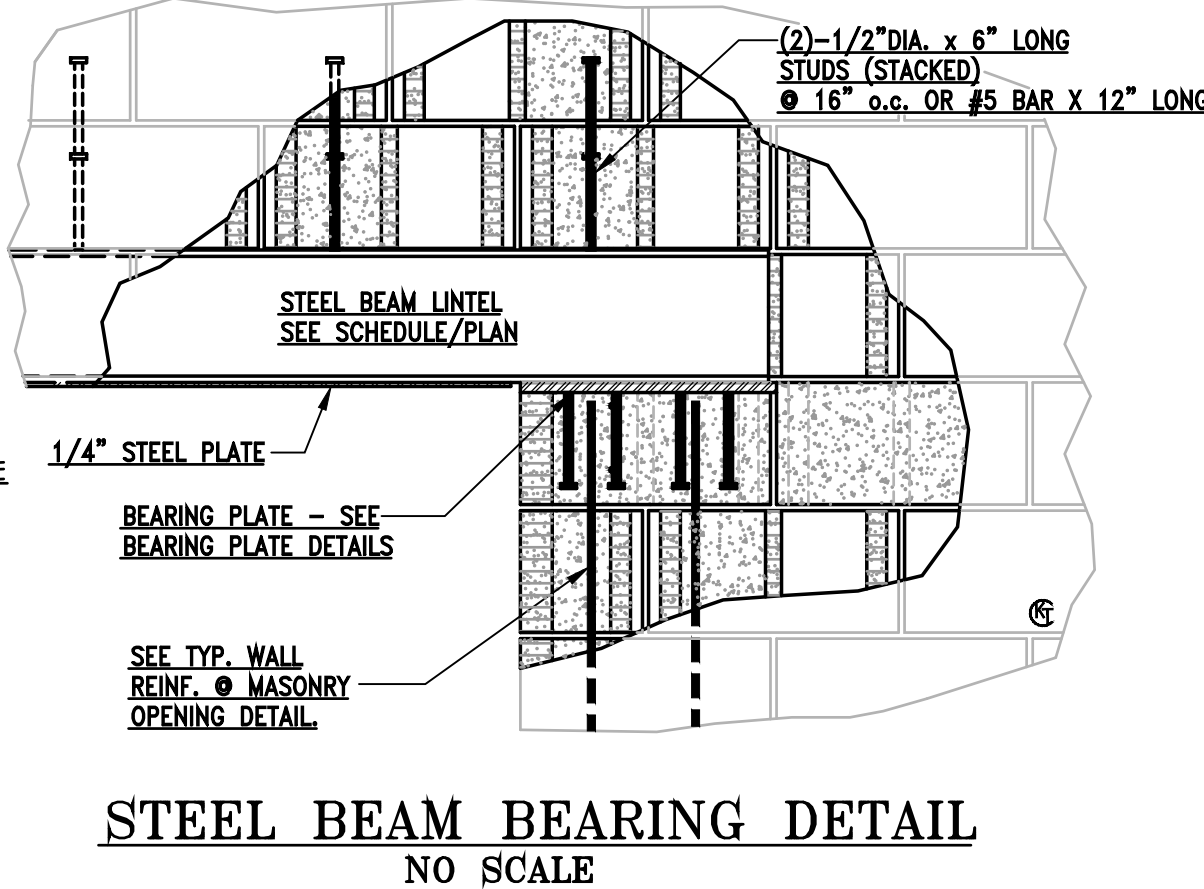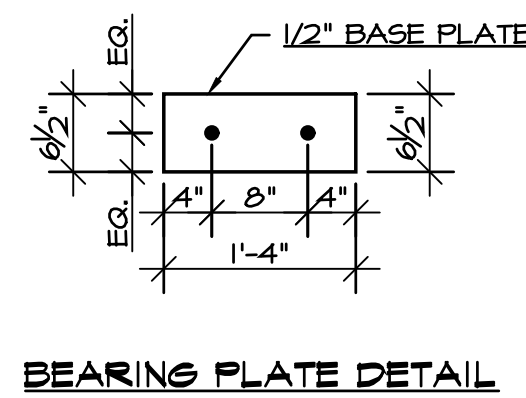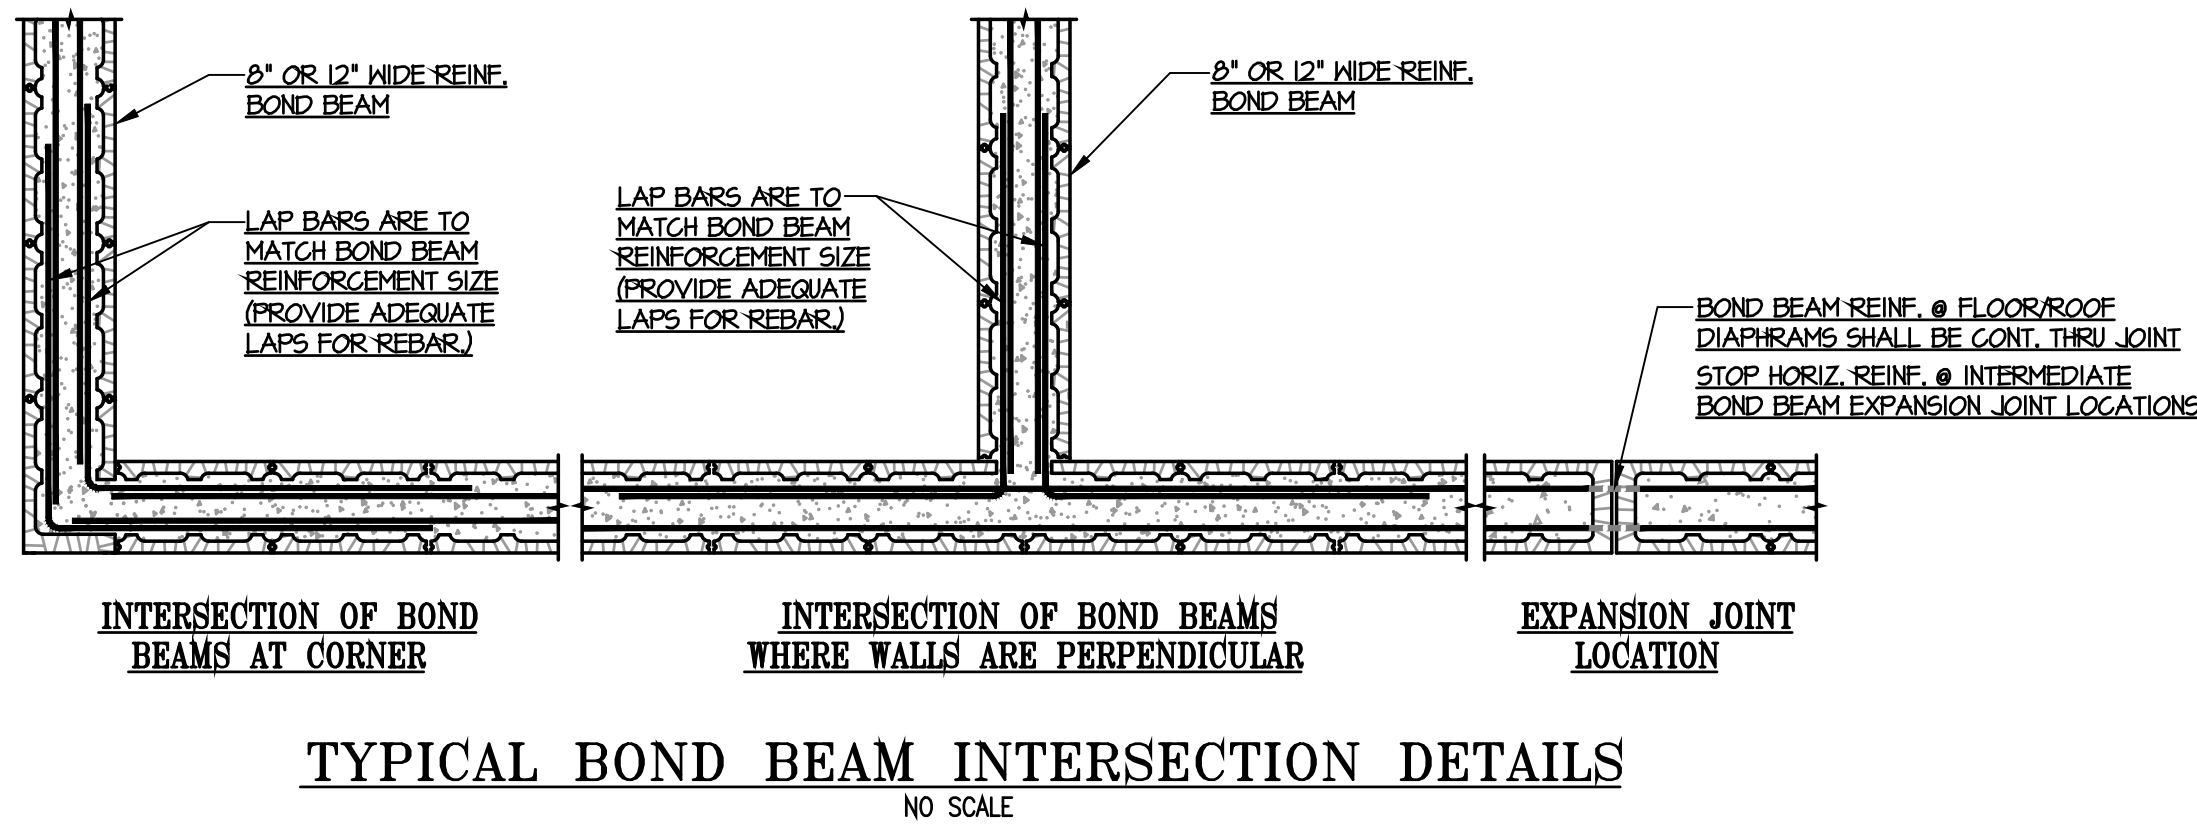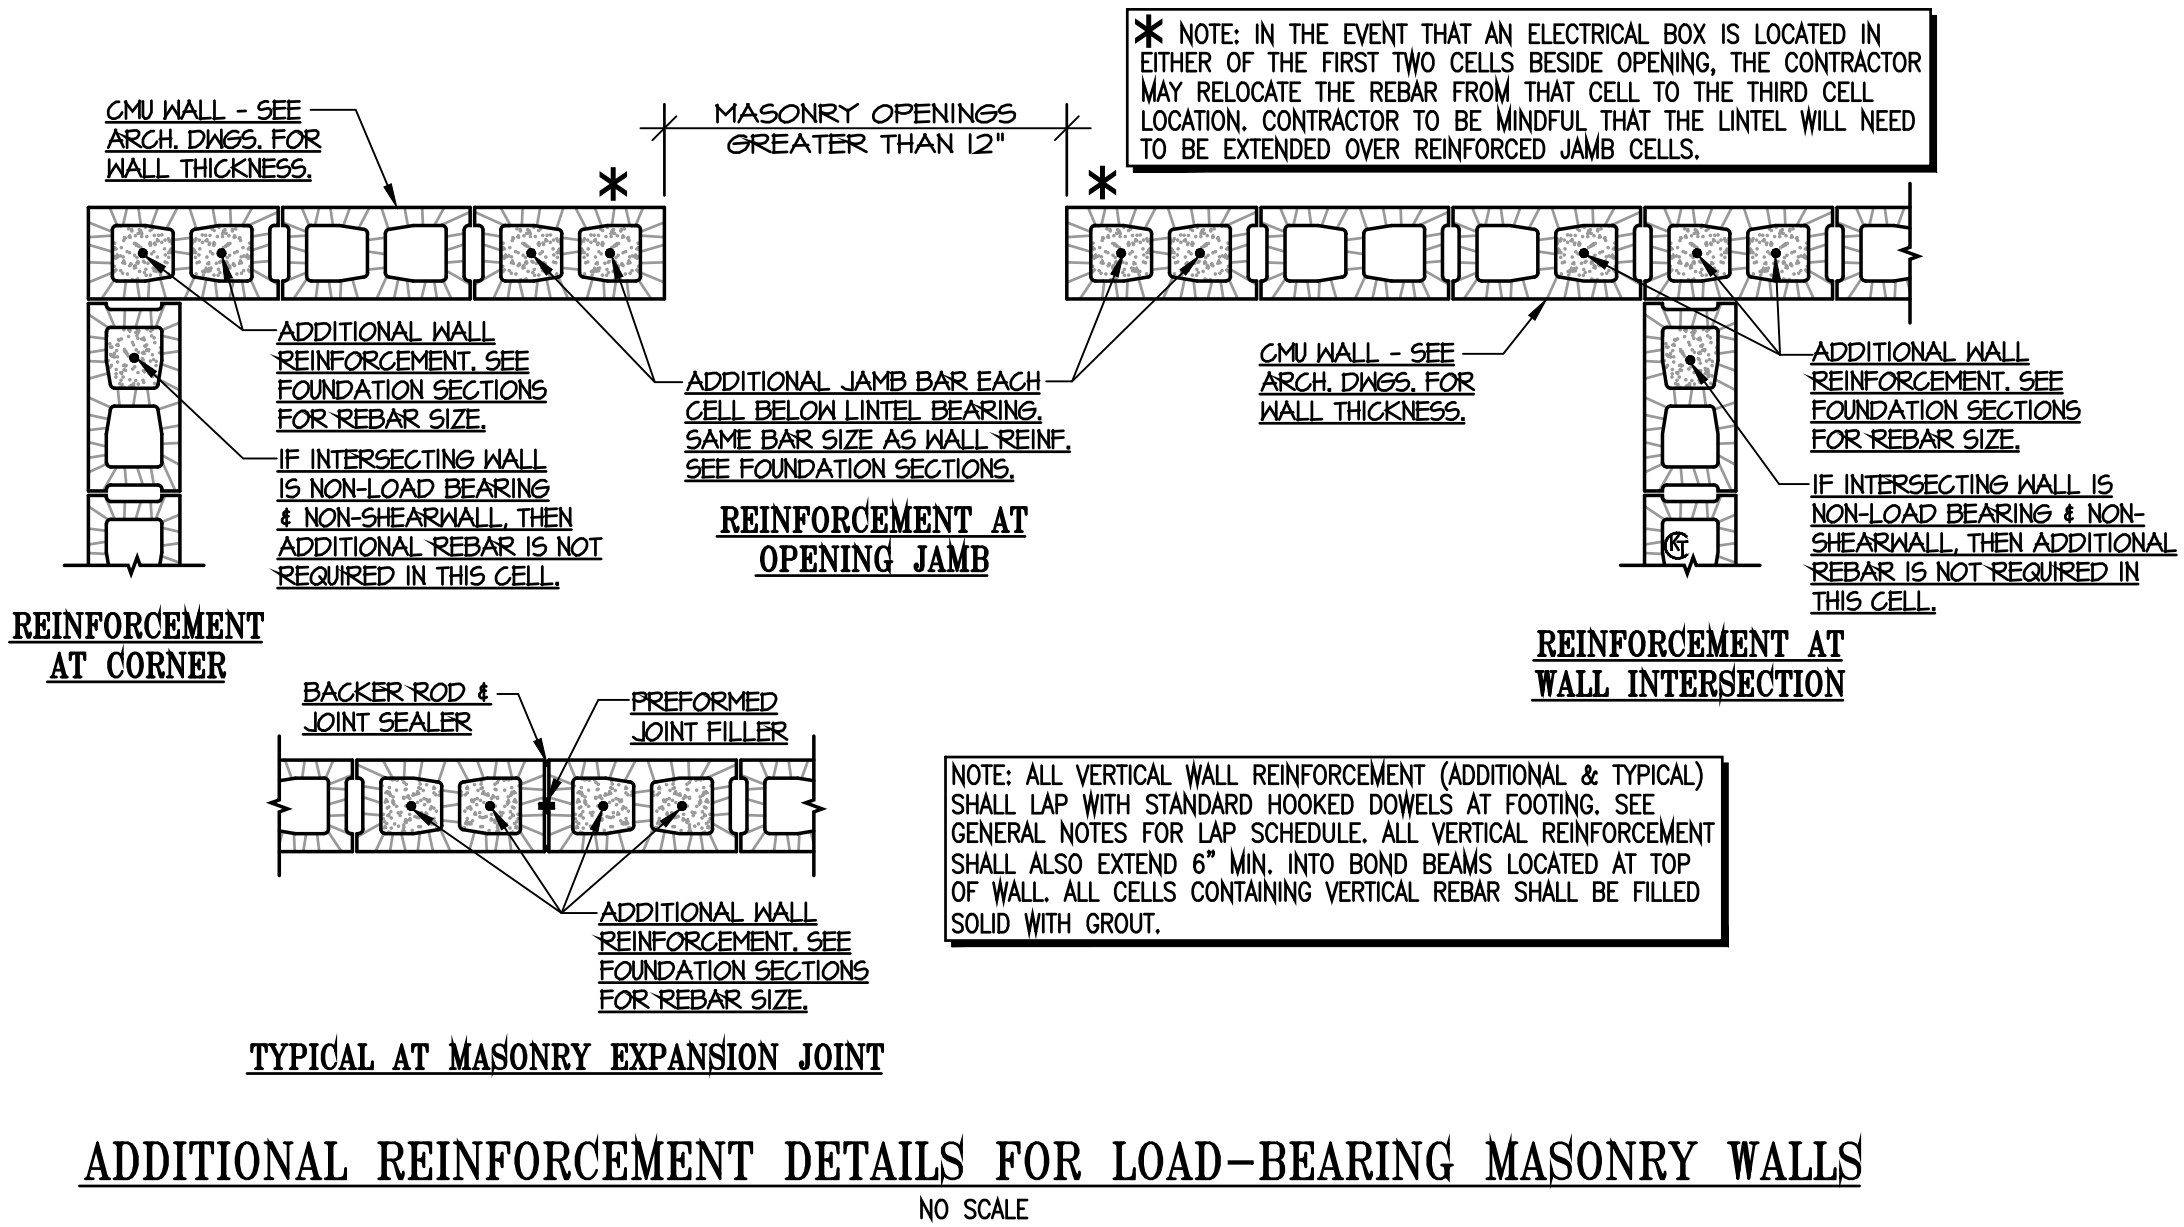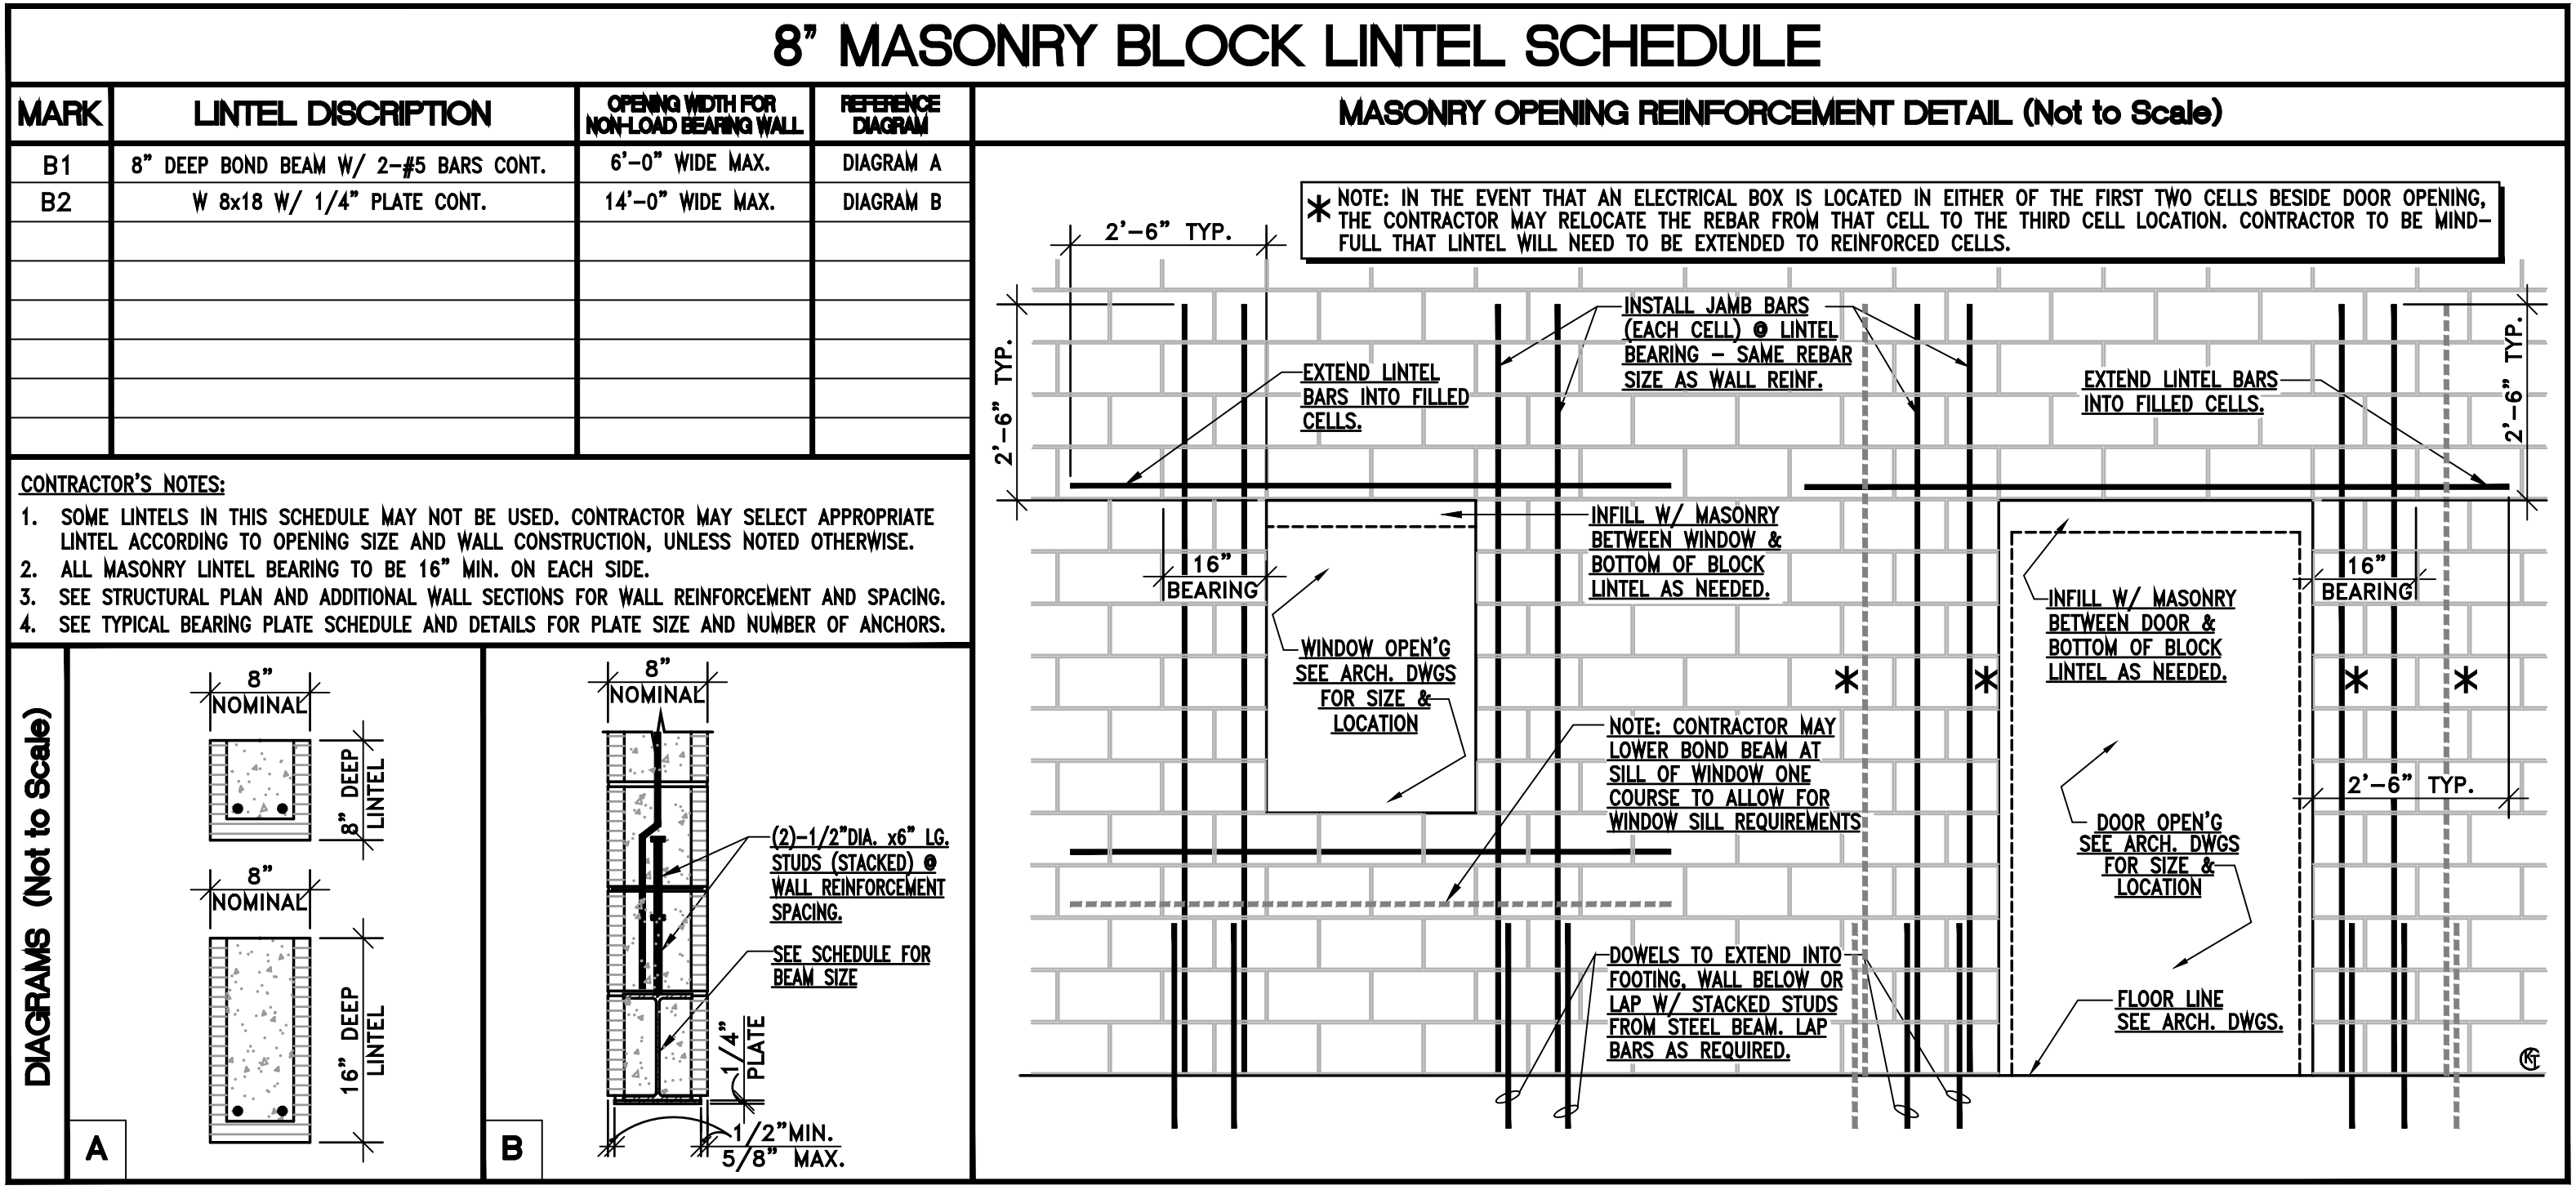

Job Title:

**RIVERBANKS ZOO & GARDEN BARN ADDITION**

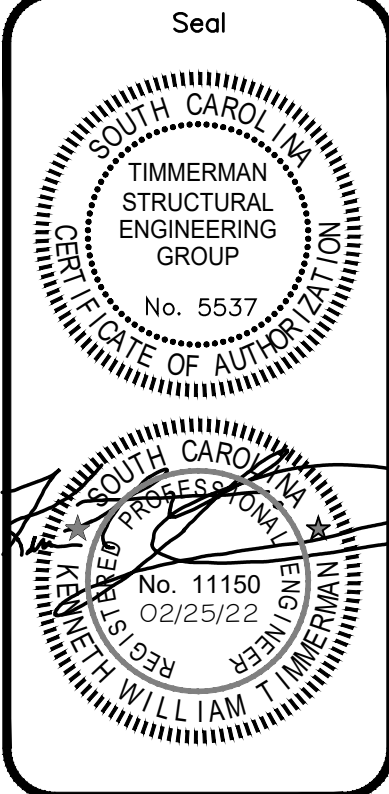500 WILDLIFE PARKWAY  
COLUMBIA, SOUTH CAROLINA 29210



Drawing Title:	
TYPICAL DETAILS	
Scale:	AS NOTED
Job Number:	22-102
Designed By:	KWT
Drawn By:	TJD
Checked By:	KWT
Date:	02/25/2022



STRUCTURAL/GENERAL NOTES:

1. THE LEAD (ARCHITECTURAL) DRAWINGS SHALL BE CONSIDERED "THE ORIGINAL SOURCE" FOR THE DIMENSIONING FOR THE PROJECT AND THEREBY WILL NORMALLY TAKE PRECEDENCE OVER THE DRAWINGS BY OTHERS ON THE DESIGN TEAM. THE DIMENSIONS INDICATED IN THESE STRUCTURAL DRAWINGS ARE TO DOCUMENT AND AID THE STRUCTURAL DESIGNER WITH THE DIMENSIONS USED FOR THE BASIC DESIGN OF THE STRUCTURAL SYSTEM. CONSTRUCTION AND DETAILING DIMENSIONS SHALL BE TAKEN (OR DERIVED) FROM THE "ORIGINAL SOURCE" DRAWINGS BY THE ARCHITECT OR LEAD DESIGNER.
2. AS PART OF MEANS AND METHODS, THE CONTRACTOR IS SOLELY RESPONSIBLE FOR THE DESIGN AND ERECTION OF TEMPORARY BRACING AND SHORING AS REQUIRED FOR STABILITY OF THE STRUCTURAL SYSTEM AND STRUCTURAL COMPONENTS DURING ALL PHASES OF CONSTRUCTION.
3. IT IS UP TO THE CONTRACTOR TO BE AWARE OF ANY EXISTING AND/OR NEIGHBORING SITE CONDITIONS WHICH MAY HAVE A BEARING ON THE CONSTRUCTION COST, MEANS AND METHODS, AND WORKING CONDITIONS FOR THIS PROJECT.
4. ALL HANDRAILS, SKYLIGHTS, STAIRS, STAIR LANDINGS, ELEVATOR HOIST BEAMS, ELEVATOR RELATED STEEL, OTHER ARCHITECTURAL/STRUCTURAL ITEMS & THEIR CONNECTIONS (SHOWN OR NOT) ON THE STRUCTURAL AND/OR CONSTRUCTION DOCUMENTS SHALL BE DESIGNED BY A REGISTERED ENGINEER, REGISTERED IN THE PROJECT STATE, TO RESIST ALL LOADS PER THE LATEST EDITION OF THE APPLICABLE BUILDING CODE(S) AND AS SPECIFIED IN THE CONTRACT DOCUMENTS. ANY ENGINEERING, DETAILING FEES, MATERIAL AND LABOR COSTS FOR THESE ITEMS ARE CONSIDERED PART OF THE CONTRACT.
5. THE CONTRACTOR SHALL DETERMINE SIZES AND LOCATIONS OF ALL SLOTS, PIPE SLEEVES, ANCHOR BOLTS, ETC. AS REQUIRED FOR ALL TRADES PRIOR TO CONSTRUCTING THAT PORTION OF THE PROJECT.
6. CONTRACTOR SHALL MAKE NO DEVIATIONS FROM DESIGN DRAWINGS AND SPECIFICATIONS WITHOUT WRITTEN APPROVAL OF THE ARCHITECT AND/OR STRUCTURAL ENGINEER.
7. THE CONTRACTOR SHALL CONSTRUCT THIS PROJECT IN ACCORDANCE TO ALL APPLICABLE BUILDING CODES AND SAFETY STANDARDS AND/OR REGULATIONS.
8. THE DESIGN PROFESSIONALS DO NOT CONTROL, OR HAVE TRAINING FOR, THE CONTRACTOR'S MEANS, METHODS, SEQUENCE, TECHNIQUES, PROCEDURES AND/OR QUALITY CONTROL IN PERFORMING THE WORK, SITE SAFETY OR SAFETY PROGRAMS IN CONNECTION WITH THIS PROJECT. THESE DUTIES ARE SOLELY THE RESPONSIBILITY OF THE CONTRACTOR AND HIS STAFF. THE CONTRACTOR IS RESPONSIBLE FOR COMPLYING WITH ALL REGULATORY AGENCIES.
9. THESE STRUCTURAL DRAWINGS ARE FOR DESCRIBING THE STRUCTURAL DESIGN FOR THE PROJECT. IN AN EFFORT TO PREVENT FINISH ISSUES, FLOOR AND WALL FINISHES (PAINT, ETC.), TILE, FIXTURES AND ALL OTHER NON-STRUCTURAL COMPONENTS SHALL BE DESIGNED AND/OR SELECTED BY OTHER PROFESSIONALS.
10. ALL SUSPENDED CEILING/SOFFIT SYSTEMS (INCLUDING LIGHT FIXTURES) SHALL BE SUPPORTED AS REQUIRED BY THE SPECIFIC PRODUCT MANUFACTURER. ATTACHMENTS, WIRES, STRUTS AND OTHER SUPPORTS SHALL BE DESIGNED TO RESIST THE CODE REQUIRED WIND (BOTH NEGATIVE AND POSITIVE PRESSURES) AND SEISMIC LOADS PER THE APPLICABLE EDITION OF THE APPROPRIATE BUILDING CODE(S). THE DESIGN OF THESE SYSTEMS SHALL BE CERTIFIED BY A LICENSED DESIGN ENGINEER REGISTERED IN THE PROJECT STATE.
11. THE CONTRACTOR SHALL REFER TO THE ARCHITECTURAL DRAWINGS (LEAD DRAWINGS) FOR ALL WALL OPENINGS (INCLUDING DOORS AND WINDOWS) AS WELL AS BUILDING CONFIGURATION AND ASSOCIATED DETAILS. REFER TO ELECTRICAL AND MECHANICAL PLANS AND/OR REQUIREMENTS FOR SIZE AND LOCATION OF ALL OPENINGS FOR DUCTS, PIPING, CONDUCTS, ETC.
12. THE CONTRACTOR SHALL REFER TO THE ARCHITECTURAL AND/OR VENDER DRAWINGS FOR LOCATIONS OF DEPRESSED FLOOR AREAS, FLOOR DRAINS, FLOOR TOPPINGS, CMU COURSING AND ANY OTHER DETAILS NOT INDICATED IN THE STRUCTURAL DRAWINGS.
13. THESE STRUCTURAL DRAWINGS ARE BASED ON THE LATEST INFORMATION/ARCHITECTURAL DRAWINGS PRIOR TO THE SUBMITTAL DATE. SOME DIMENSIONS FOUND IN THESE DRAWINGS MAY HAVE BEEN VERBALLY COMMUNICATED BY THE ARCHITECT OR TAKEN DIRECTLY FROM ELECTRONIC FILES SUPPLIED BY THE ARCHITECT.
14. AS REQUIRED BY CODE, THE CONTRACTOR SHALL DETERMINE AND POST APPROPRIATE SIGNS PERTAINING TO RESTRICTIONS OF LIVE LOAD AND/OR STACKING LIMITATIONS.
15. QUESTIONS RELATING TO THESE STRUCTURAL DRAWINGS MAY BE SUBMITTED IN WRITING, THROUGH THE ARCHITECT OR PRIME PROFESSIONAL TO THE STRUCTURAL ENGINEER. THE STRUCTURAL ENGINEER SHALL BE COPIED AT:

TIMMERMAN STRUCTURAL ENGINEERING GROUP  
580 CHRIS DRIVE  
WEST COLUMBIA, SC 29169  
(803) 791-4511

GEOTECHNICAL:

1. THIS FOUNDATION DESIGN IS BASED ON AN ASSUMED ALLOWABLE SOIL BEARING PRESSURE OF 2000 PSF.
2. A GEOTECHNICAL ENGINEER AND/OR TESTING LABORATORY SHALL BE RETAINED FOR THE PURPOSES OF ASSURING ADEQUATE SOIL SUPPORT FOR FOUNDATION AND SLABS-ON-GRADE. A COPY OF ALL TEST REPORTS SHALL REMAIN ON FILE AT THE JOB SITE AVAILABLE FOR THE DESIGN TEAM. ANY TESTS DEEMED UNACCEPTABLE SHALL BE COPIED AND SENT TO THE ARCHITECT OR LEAD DESIGN PROFESSIONAL. THE CONTRACTOR SHALL FORWARD COPIES OF ALL REPORTS TO THE OWNER AS REQUIRED BY THEIR AGREEMENT. THE PROJECT STRUCTURAL ENGINEER SHALL BE NOTIFIED OF ANY SITE CONDITIONS OR FOUNDATION CONSTRUCTION ISSUES DISCOVERED AT THE SITE.
3. CONTRACTOR IS RESPONSIBLE FOR PROTECTING ALL EXCAVATIONS AND SLOPES.
4. TIMMERMAN STRUCTURAL ENGINEERING GROUP SHALL BE NOTIFIED OF ANY TRASH, DEBRIS, SOFT AREAS FOR ANY OTHER SUBSURFACE ANOMALY FOUND UNDER THE BUILDING SITE WHETHER PLACED THERE OR NATURALLY OCCURRING. THESE STRUCTURAL DRAWINGS WILL NOT REFLECT FIELD CONDITIONS PERTAINING TO TRASH, DEBRIS, ANOMALIES, ETC. THE CONTRACTOR SHALL REMOVE AND/ OR MODIFY EXISTING SOILS AS DIRECTED BY A GEOTECHNICAL ENGINEER.

CONCRETE:

1. ALL CONCRETE AND REINFORCING BARS SHALL BE INSTALLED IN ACCORDANCE TO STANDARDS SET FORTH BY THE LATEST EDITION OF ACI-318.
2. REINFORCEMENT SHALL BE HELD IN PLACE DURING CONCRETE PLACEMENT. IF REQUIRED, ADDITIONAL BARS SHOULD BE INSTALLED AS NEEDED BY THE CONTRACTOR TO PROVIDE TO HOLD REINFORCING BARS IN PLACE WHILE CONCRETE IS PLACED.
3. 28 DAY MINIMUM CONCRETE COMPRESSIVE STRENGTH SHALL BE AS FOLLOWS:
- |                           |          |
|---------------------------|----------|
| FOOTINGS                  | 3000 PSI |
| SLABS ON GRADE            | 3000 PSI |
| FILL FOR STAIR TREAD PANS | 4000 PSI |
| SLABS ON FORM DECK        | 4000 PSI |
- NO CALCIUM CHLORIDE SHALL BE USED IN MIX.
4. SPECIFIED CONCRETE COVER FOR CONVENTIONAL REINFORCEMENT SHALL BE AS FOLLOWS:
- CONCRETE CAST AGAINST AND EXPOSED TO EARTH. . 3 INCHES
- CONCRETE EXPOSED TO EARTH OR WEATHER:
- |                          |              |
|--------------------------|--------------|
| #6 THRU #18 BARS.....    | 2 INCHES     |
| #5 BARS AND SMALLER..... | 1-1/2 INCHES |
- CONCRETE NOT EXPOSED TO WEATHER OR IN CONTACT IN EARTH:
- |                            |              |
|----------------------------|--------------|
| SLABS, WALLS, JOISTS:      |              |
| #14 AND #18 BARS .....     | 1-1/2 INCHES |
| #11 BARS AND SMALLER ..... | 3/4 INCHES   |
5. THE CONTRACTOR SHALL TAKE ADDITIONAL PRECAUTIONS WHEN CONCRETE IS TO BE PLACED AND CURED DURING COLD OR HOT WEATHER. THE CONTRACTOR SHALL FOLLOW THE RECOMMENDATIONS PRESCRIBED BY THE AMERICAN CONCRETE INSTITUTE FOR COLD OR HOT WEATHER CONSTRUCTION.
6. WELDED WIRE FABRIC SHALL BE LAPPED A MINIMUM OF 12".

7. ALL PLUMBING SLOTS SHALL BE FILLED WITH CONCRETE TO THE SAME DEPTH AS THE FLOOR SLAB AFTER PIPING IS INSTALLED.
8. EXTERIOR CONCRETE PADS SHALL BE SIZED AND LOCATED PER THE CONTRACT DOCUMENTS AND/OR EQUIPMENT SPECIFICATIONS/ REQUIREMENTS. SEE DRAWINGS BY ARCHITECT AND/OR MECHANICAL/ELECTRICAL ENGINEERS IN ADDITION TO THE STRUCTURAL AND CIVIL DRAWINGS.
9. THE GENERAL CONTRACTOR SHALL SUBMIT REBAR SHOP DRAWINGS SHOWING NUMBER, SIZE AND LOCATION, INCLUDING BAR LISTS AND DIAGRAMS, TO THE DESIGN TEAM FOR APPROVAL.
10. REBAR DOWELS SHALL MATCH VERTICAL REINFORCING (UNO) .
11. SEE ARCHITECTURAL DRAWINGS OR OWNER REQUESTS FOR REQUIRED CONCRETE FINISH/COLOR, SPECIAL FLATNESS REQUIREMENTS, ETC. ALL CONCRETE SHALL BE PROPERLY CURED IMMEDIATELY AFTER FINISHING.
12. A QUALIFIED TESTING LABORATORY SHALL BE RETAINED TO COLLECT CYLINDERS AND PERFORM THE NECESSARY CONCRETE TESTS. A MINIMUM OF FOUR CYLINDERS SHALL BE TAKEN FOR EVERY 50 CUBIC YARDS (OR FRACTION THEREOF) OF EACH CONCRETE TYPE/STRENGTH SUPPLIED. THE CONCRETE CYLINDERS SHALL BE TAKEN AFTER WATER AND ADMIXTURES (IF ANY) ARE ADDED TO THE MIX. IT IS RECOMMENDED THAT ONE CYLINDER SHALL BE TESTED AT 7 DAYS, TWO AT 28 DAYS AND HOLD THE FINAL CYLINDER IN RESERVE. IT IS RECOMMENDED FOR TEST REPORTS SHALL BE SENT DIRECTLY TO THE GENERAL CONTRACTOR WITH COPIES TO THE OWNER, ARCHITECT AND STRUCTURAL ENGINEER. ANY NONCONFORMING CYLINDER BREAKS (INCLUDING 7 AND 14 DAY BREAKS) SHALL BE FLAGGED AND BROUGHT TO THE ATTENTION OF THE APPROPRIATE DESIGN PROFESSIONAL.
13. REPAIR AND PATCH DEFECTIVE AREAS IMMEDIATELY AFTER REMOVAL OF FORMS. ALL CONCRETE REPAIR MATERIAL AND PROCEDURES SHALL BE PER MANUFACTURER'S RECOMMENDATIONS.
14. 4" SLAB ON GRADE SHALL BE REINFORCED WITH W6X6-W1.4 x W1.4 WWF ON PROPERLY PREPARED BASE MATERIAL WITH VAPOR BARRIER. THE CONTRACTOR SHALL REFER TO THE GEOTECHNICAL ENGINEER'S RECOMMENDATIONS FOR SPECIFICS RELATING TO SLAB SUPPORT, LOCATION OF VAPOR BARRIER AND ANY OTHER "UNDER SLAB" REQUIREMENTS. A 4" SLAB IS TYPICALLY FOR "DOMESTIC OR LIGHT COMMERCIAL" APPLICATIONS WITH FLOOR LOADINGS UP TO 100 PSF. SLAB THICKNESS SHOULD BE INCREASED IN THE EVENT THERE IS A NEED FOR HEAVIER FLOOR LOADINGS- CONTRACTOR SHALL VERIFY FLOOR LOADS WITH OWNER AND EQUIPMENT SUPPLIERS, ETC. PRIOR TO BASE AND SLAB PLACEMENT. IN THESE AREAS THE SLAB SHALL BE THICKENED TO ACCOMMODATE THE LOADS. SEE CONSTRUCTION DOCUMENTS FOR LOCATIONS OF SLABS AND "BASIC" OR MINIMUM SLAB THICKNESS.
15. IN MANY CASES SPECIAL SLAB DESIGNS MAY BE NEEDED TO SUPPORT FORKLIFT AND VEHICLE WHEEL LOADS. THE CONTRACTOR SHALL SUBMIT FORKLIFT MAKE AND MODEL TO LEAD DESIGNER IN THE EVENT FORKLIFTS ARE TO BE USED IN THE FINISHED BUILDING.
16. THE CONTRACTOR, CONCRETE SUPPLIERS AND ALL RELATED SUBCONTRACTORS SHALL BE EXPERIENCED IN THE USE OF CONCRETE ADMIXTURES, SEALERS, CURING COMPOUNDS, ETC. AS NEEDED PER FIELD CONDITIONS.

MASONRY:

1. THE MASONRY DIMENSIONS ON THIS PROJECT ARE CONSIDERED AS NOMINAL DIMENSIONS. THE SHAPE AND ACTUAL SIZE OF THE MASONRY UNITS AND SPECIAL UNITS SHALL BE CONSIDERED IN THE BUILDING AND WALL LAYOUT PLAN. REFERENCE IS MADE TO ARCHITECTURAL DRAWINGS FOR BUILDING LAYOUT.
2. FILL ALL CELLS BELOW FLOOR (AND GRADE) LEVEL OR CONTAINING REBAR WITH 2500 PSI GROUT. GROUT SHALL BE PLACED IN LIFTS NO HIGHER THAN 5 FEET. MASONRY UNITS SHALL BE CLEAN AND DRY. FIRE RATED MASONRY WALLS SHALL HAVE ALL CELLS GROUT FILLED.
3. THE CONTRACTOR SHALL INSTALL SUFFICIENT REBAR PLACEMENT WALL TIES TO ENSURE THE PROPER PLACEMENT OF ALL HORIZONTAL AND VERTICAL REBAR.
4. ALL MASONRY ACCESSORIES (INCLUDING LINTEL PLATES AND ANGLES) SHALL BE GALVANIZED. HORIZONTAL BED JOINT REINFORCEMENT SHALL BE GALVANIZED AS REQUIRED BY APPLICATION, MANUFACTURER'S RECOMMENDATIONS AND APPLICABLE BUILDING CODES. ALL LINTEL PLATES AND ANGLES SHALL HAVE A MINIMUM THICKNESS OF 3/8" THICK UNLESS OTHERWISE NOTED IN STRUCTURAL DRAWINGS.

5. MASONRY REBAR LAP SPLICES SHALL BE AS FOLLOWS:

BAR SIZE	CENTERED BARS		FACE BARS
	8" BLOCK	12" BLOCK	
#4 BAR	15" LAP	15" LAP	22" LAP
#5 BAR	24" LAP	16" LAP	35" LAP
#6 BAR	36" LAP	24" LAP	54" LAP
#7 BAR	52" LAP	33" LAP	63" LAP
#8 BAR	72" LAP	50" LAP	72" LAP

6. CONCRETE MASONRY TO HAVE A MINIMUM F'm OF 1500 PSI. THIS IS TO BE ACHIEVED BY USING A CONCRETE BLOCK MASONRY UNIT WITH A NET AREA COMPRESSIVE STRENGTH OF 2000 PSI WHEN USED IN CONJUNCTION WITH TYPE M OR S MORTAR.
7. ALL MASONRY SHALL BE PLACED IN FULL MORTAR BED. ALL MORTAR SHALL BE TYPE "M" OR "S".
8. THE INTERSECTION OF ALL LOAD BEARING MASONRY WALLS SHALL BE TIED OR ATTACHED AT WALL INTERSECTIONS OR WHERE THEY MEET BY ONE OF THE FOLLOWING METHODS:
- A. STEEL CONNECTIONS: WALLS SHALL BE ANCHORED AT INTERSECTIONS USING 2" WIDE X 0.25" THICK BY 24" LONG STRAPS (GALVANIZED) PLUS A 2"-90 DEGREE BEND AT EACH END. STEEL STRAPS SHALL BE PLACED IN MORTAR BEDS AT 48" ON CENTER VERTICALLY.
- B. BONDING OF UNITS: FIFTY PERCENT OF THE MASONRY UNITS SHALL BE LAID IN AN OVERLAPPING PATTERN. MASONRY UNITS FORMING THE BONDING PATTERN SHALL BEAR NO LESS THAN 3 INCHES ON THE UNITS BELOW.
- C. JOINT REINFORCEMENT: INTERSECTING WALLS MAY BE JOINED USING MASONRY WALL REINFORCEMENT SPACED AT 8 INCHES ON CENTER VERTICALLY. THE WIRE SIZE SHALL BE AT LEAST W1.7 AND EXTEND AT LEAST 30 INCHES FROM THE INTERSECTION.

NOTE: FOR APPLICATIONS WHERE INDEPENDENT FIRE WALLS ARE USED, INTERSECTING WALLS SHALL NOT BE TIED TO THESE FIRE WALLS TO ALLOW THE FREESTANDING FIRE WALLS TO REMAIN INTACT IN THE EVENT OF A FIRE.

NOTE: NON-LOAD BEARING MASONRY PARTITION WALLS SHALL BE TIED TO ONE ANOTHER BUT NOT TIED TO LOAD BEARING MASONRY WALLS.

9. THE CONTRACTOR SHALL TAKE ADDITIONAL PRECAUTIONS WHEN MASONRY IS TO BE CONSTRUCTED DURING COLD WEATHER (AMBIENT TEMPERATURE BELOW 40 DEGREES FAHRENHEIT). DURING HOT CONDITIONS (ABOVE 90 DEGREES) PRECAUTIONS SHALL BE TAKEN TO MINIMIZE EXCESS HEAT IN THE MASONRY UNITS, WATER AND MORTAR. IT IS ADVISED THAT THE CONTRACTOR FOLLOW THE RECOMMENDATIONS PRESCRIBED BY AMERICAN CONCRETE ASSOCIATION FOR COLD OR HOT WEATHER CONSTRUCTION.
10. SEE ARCHITECTURAL DRAWINGS FOR LOCATIONS OF MASONRY CONTROL JOINTS & BRICK EXPANSION JOINTS. ALL CONTROL JOINTS AND EXPANSION JOINTS SHALL BE INSTALLED IN ACCORDANCE TO THE STANDARDS PRESCRIBED BY THE NATIONAL CONCRETE MASONRY ASSOCIATION. IN NO CASE SHALL EXTERIOR WALL JOINTS BE SPACED GREATER THAN 25 FEET ON CENTER AND INTERIOR WALL JOINTS SHALL NOT EXCEED 30 FEET ON CENTER. REINFORCED BOND BEAMS LOCATED AT ROOF AND FLOOR DIAPHRAGMS SHALL BE CONTINUOUS THROUGH MASONRY JOINTS UNLESS OTHERWISE SPECIFIED IN THE STRUCTURAL DRAWINGS.
11. RUNNING BOND MASONRY TO HAVE 9 GAGE LADDER TYPE JOINT REINFORCEMENT @ 16" ON CENTER VERTICALLY. PREFORMED BED JOINT REINFORCEMENT SHALL BE USED AT ALL WALL CORNERS AND INTERSECTIONS. ALL GAGE WIRE LADDER TYPE BED JOINT REINFORCEMENT SHALL BE LAPPED A MINIMUM OF 8 INCHES.
12. FOR ALL LOAD BEARING WALLS (AND SHEAR WALLS) THE CONTRACTOR SHALL INSTALL BOND BEAMS AT A MAXIMUM SPACING OF 4 FEET ON CENTER AS MEASURED FROM THE TOP OF FOUNDATION.
- IN SOME CASES, BOND BEAMS MAY HAVE TO BE CUT DOWN FROM 16 INCH DEEP BOND BEAMS IN ORDER TO ACHIEVE THE PROPER ELEVATION FOR JOIST BEARING ELEVATIONS. 8" WIDE BOND BEAMS SHALL CONTAIN TWO #5 BARS.
- THE CONTRACTOR MAY PLACE ELECTRICAL BOXES IN BOND BEAMS PROVIDED THE REBAR IS CONTINUOUS. THE CONTRACTOR MAY ALSO SPACE BOND BEAMS AS NEEDED TO MISS ELECTRICAL BOXES PROVIDED THE BOND BEAM MAXIMUM SPACING IS MAINTAINED. REINFORCED BOND BEAMS LOCATED AT ROOF AND/OR FLOOR DIAPHRAGMS SHALL BE CONTINUOUS THROUGH MASONRY EXPANSION JOINTS UNLESS OTHERWISE SPECIFIED IN THE STRUCTURAL DRAWINGS.
13. WALL SLEEVES FOR UTILITIES SHALL BE CAREFULLY PLACED TO PREVENT CONFLICT WITH WALL AND FOUNDATION REINFORCEMENT. TO PREVENT LOAD TRANSFER TO THE UTILITY, ALL PIPES SHALL BE SLEEVED WITH STEEL OR DUCTILE IRON TO PROVIDE A 1 INCH CLEARANCE BETWEEN THE SLEEVE AND UTILITY PIPE.


STRUCTURAL AND MISCELLANEOUS STEEL:

1. THE CONTRACTOR SHALL SUBMIT DETAILED STRUCTURAL STEEL SHOP DRAWINGS TO INCLUDE (BUT NOT LIMITED TO) COLUMNS, BEAMS, DECKING, STAIRS, STAIR LANDINGS AND ALL CONNECTIONS. AS PART OF THE SHOP DRAWINGS, THE CONTRACTOR SHALL SUPPLY EMBEDDED STEEL PLATE AND BRACKET LOCATION DRAWINGS.
2. SPECIAL STAIR/RAIL NOTE: STRUCTURAL STAIRS, HANDRAILS AND GUARDRAILS MUST BE DESIGNED BY A REGISTERED ENGINEER, LICENSED IN THE PROJECT STATE. THE DESIGN DRAWINGS (SHOP DRAWINGS) MUST BE SEALED BY THE DESIGN ENGINEER RETAINED BY THE CONTRACTOR/ SUBCONTRACTOR IN ORDER TO COMPLETE THE SHOP DRAWING PROCESS.
3. ALL STEEL DETAILS AND CONNECTIONS SHALL BE IN ACCORDANCE WITH THE REQUIREMENTS OF THE LATEST EDITION OF A.I.S.C. SPECIFICATIONS.
4. FIELD SPLICES SHALL BE DESIGNED AND CONSTRUCTED TO DEVELOP THE FULL CAPACITY OF THE MEMBER IN BENDING, SHEAR AND AXIAL LOADS.
5. IN THE ABSENCE OF SPECIFIC CAMBER REQUIREMENTS, THE STEEL SHALL BE FABRICATED AND ERECTED WITH MILL CAMBER UP.
6. ALL FRAMING AND MISCELLANEOUS STEEL SHALL BE FILLET WELDED ALL AROUND UNLESS OTHERWISE NOTED. WELD SIZE SHALL BE THE MAXIMUM AS ALLOWED BY THE LATEST EDITION OF THE "MANUAL OF STEEL CONSTRUCTION" BASED ON THE MATERIAL THICKNESS. ALL WELDING SHALL BE DONE WITH E-70 ELECTRODES.
7. ALL CAP PLATES FOR STEEL COLUMNS SHALL HAVE A MINIMUM THICKNESS OF 3/4" THICK UNLESS OTHERWISE NOTED IN THE DETAILS.
8. SHOP AND FIELD CONNECTIONS NOT SPECIFICALLY DETAILED ON THE DRAWINGS MAY BE WELDED OR BOLTED. ALL WELDING SHALL BE DONE WITH E-70 ELECTRODES. CUTS, HOLES, COPING, ETC. REQUIRED FOR WORK OF OTHER TRADES, ROOF LINES OR BUILDING GEOMETRY SHALL BE SHOWN ON THE STRUCTURAL STEEL SHOP DRAWINGS AND FABRICATED IN THE SHOP. FIELD CUTTING AND/OR BURNING IS NOT PERMITTED WITHOUT APPROVAL OF THE STRUCTURAL ENGINEER OF RECORD FOR THE PROJECT OR A STRUCTURAL ENGINEER REGISTERED IN THE PROJECT STATE.
9. A SUITABLE NON-SHRINK GROUT (7000 PSI) SHALL BE USED UNDER BASE PLATES REQUIRING GROUT. GROUT SHALL BE PLACED UNDER THE BASEPLATE ONCE THE STEEL COLUMN IS IN PLACE & PLUMB. THOUGH THE DETAILS AND DRAWINGS MAY (OR MAY NOT) INDICATE, THE CONTRACTOR MAY OPT TO USE LEVELING PLATES AND LEVELING NUTS BELOW THE BASE PLATES TO PLUMB THE STEEL COLUMNS. THE CONTRACTOR SHALL ADJUST THE FOOTING ELEVATION(S) AND CONSIDER THE FLOOR ELEVATION FOR COLUMNS SUBJECT TO GROUT, LEVELING NUTS, ETC.
10. ALL WELDS IN EXPOSED STEEL SHALL BE FIELD COATED W/ ZINC-RICH PAINT.
11. STEEL DETAILERS TO VERIFY/DETERMINE JOIST AND BEAM BEARING ELEVATIONS WITH THE ARCHITECTURAL DRAWINGS TO ENSURE PROPER ROOF SLOPES FOR DRAINAGE AND CORRECT FLOOR ELEVATIONS. SEE ARCHITECTURAL DRAWINGS FOR FLASHING AND ROOF RELATED DETAILS NOT SHOWN ON STRUCTURAL DRAWINGS.
12. ALL STEEL REQUIRING PAINT SHALL BE PROPERLY CLEANED AND PREPARED TO ACCEPT THE APPROPRIATE PAINT FOR THE PROJECT. THE PAINT TYPE, COLOR AND THICKNESS SHALL BE SELECTED ACCORDING TO THE LOCATION OF THE STEEL, TYPE OF BUILDING AND OWNER'S REQUIREMENTS FOR COLOR, ETC. DECISIONS INVOLVING PAINT, COLOR AND SO ON SHALL BE PER OWNER.
13. 1/4" THICK STEEL PLATES SHALL BE INSTALLED TO THE TOP OR BOTTOM FLANGES OF ALL STEEL BEAMS SUPPORTING MASONRY WALLS. THE PLATE WIDTH SHALL BE ON LESS THAN 1 INCH NARROWER THAN THE MASONRY WALL WIDTH UNO.

METAL DECKING:

1. DECKING INSTALLER SHALL EXAMINE SUPPORT FRAMING AND FIELD CONDITIONS FOR COMPLIANCE WITH REQUIREMENTS FOR DECKING INSTALLATION TOLERANCES AND OTHER CONDITIONS AFFECTING DECK INSTALLATION. CONTRACTOR SHALL DETERMINE REQUIRED DECK OPENING LOCATIONS AND SIZES FOR ALL TRADES REQUIRING DECK PENETRATIONS.
2. 1-1/2" DEEP ROOF DECK, 20 GAGE, TYPE "B", G60 GALVANIZED (SEE BUILDING PLAN) TO BE MECHANICALLY FASTENED INSTALLED WITH A 36/5 FASTENER PATTERN WITH #12 TEK SCREWS. OR 5/8" PUDDLE WELDS) AT ALL ENDS (3" LAP) AND INTERMEDIATE SUPPORTS. INSTALL 8 #10 TEK SCREWS ALONG SIDE LAPS BETWEEN SUPPORTS. ATTACH DECKING AT 6 INCHES ON CENTER ALONG THE ROOF PERIMETER WITH #10 TEK SCREWS OR 5/8" PUDDLE WELDS. CONTRACTOR MAY PUDDLE WELD DECK TO SUPPORTS PROVIDED APPROVED WELD WASHERS WITH A 3/8" DIAMETER HOLE ARE USED.
3. 1-1/2" COMPOSITE FLOOR DECK, TYPE "1.5 VLI" - 18 GAUGE (GALVANIZED) COMPOSITE METAL FLOOR DECKING SHALL BE FASTENED WITH 4- 5/8" PUDDLE WELDS AT EACH SUPPORT AND LAPS. DECKING MUST BEAR AT LEAST 1-1/2" ON ALL SUPPORTS INCLUDING LAPS (LAP DECK 3" MINIMUM) . INSTALL 5 EQUALLY SPACED #10 TEK SCREWS OR WELDS FOR SIDE LAPS BETWEEN SPANS AND ATTACH DECKING TO PERIMETER FLOOR STEEL WITH 5/8" PUDDLE WELDS AT 8 INCHES ON CENTER. CONCRETE COVER OF AT LEAST 2" SHALL BE PROVIDED ABOVE THE TOP OF THE STEEL DECK. SEE PLAN FOR ADDITIONAL INFORMATION.
4. FOR CONCRETE SLABS PLACED ON STEEL DECKING - THE CONTRACTOR SHOULD REPAIR/PATCH ONLY THOSE RANDOM CRACKS WHICH AFFECT THE SERVICEABILITY OF THE FLOOR.
5. PROVIDE 4 X 4 X 1/4 ANGLES SURROUNDING ALL METAL DECK PENETRATIONS UNLESS OTHERWISE NOTED.
6. THE INSTALLATION OF ALL FLOOR AND ROOF DECK SHALL INCLUDE DECK ANGLES TO FORM AN ATTACHMENT TO ALL MASONRY AND CONCRETE WALLS. DECK SUPPORT ANGLES SHALL BE 5 X 3.5 X 1/4" (LONG LEG VERTICAL) WITH 3/4" (6" EMBEDMENT) EPOXY BOLTS AT 2'-0" ON CENTER SHALL BE USED AT ALL MASONRY AND CONCRETE WALLS UNLESS OTHERWISE INDICATED IN THE CONSTRUCTION DOCUMENTS. A 5 X 5 X 5/16" ANGLE SHALL BE USED AT LOCATIONS IN WHICH THE DECK SUPPORT MUST SPAN BETWEEN STEEL JOISTS AND/OR BEAMS. IN THE EVENT THE STEEL DECK CHANGES DIRECTION, STEEL TUBES SHALL BE INSTALLED TO SHIM AND PROVIDE CONTINUOUS SUPPORT FOR THE DECK. THESE TUBES MAY OR MAY NOT BE INDICATED IN THE DETAILS (FOR CLARITY).
7. CONCRETE (INCLUDING TOPPINGS) IS NOT WATERTIGHT OR A WATERPROOF MATERIAL. WATER PERMEABILITY MAY POSSIBLY BE REDUCED DEPENDING ON A NUMBER OF FACTORS INCLUDING SURFACE SLOPE, STANDING WATER ON THE SURFACE OF CONCRETE WILL EVENTUALLY SEEP INTO THE CONCRETE MATERIAL THROUGH VIRTUALLY INVISIBLE CRACKS WHICH EXISTS IN ALL CURED CONCRETE. FOR THIS REASON CONCRETE MUST BE PROPERLY SEALED AND PROTECTED FROM WATER INTRUSION. AN ADEQUATE LONG TERM CONCRETE MAINTENANCE PLAN SHOULD BE USED FOR ALL CONCRETE SYSTEMS. REFERENCE IS MADE TO A WATERPROOFING PROFESSIONAL FOR PROPER DETAILS.
8. ALL STEEL REQUIRING PAINT SHALL BE PROPERLY CLEANED AND PREPARED TO ACCEPT THE APPROPRIATE PAINT FOR THE PROJECT. THE PAINT TYPE, COLOR AND THICKNESS SHALL BE SELECTED ACCORDING TO THE LOCATION OF THE STEEL, TYPE OF BUILDING AND OWNER'S REQUIREMENTS FOR COLOR, ETC. DECISIONS INVOLVING PAINT, COLOR AND SO ON SHALL BE PER OWNER.

Revisions	
Revision	By

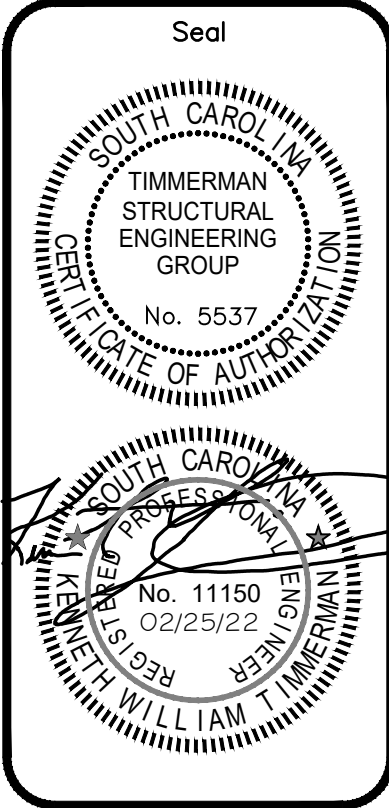

Job Title:

**RIVERBANKS ZOO & GARDEN BARN ADDITION**  
500 WILDLIFE PARKWAY  
COLUMBIA, SOUTH CAROLINA 29210



Drawing Title:	
NOTES	
Scale:	AS NOTED
Job Number:	22-102
Designed By:	KWT
Drawn By:	TJD
Checked By:	KWT
Date:	02/25/2022

Sheet Number
<b>S3.0</b>
Sheet 6 of 7

FOR CONSTRUCTION




STATEMENT OF SPECIAL INSPECTIONS (PER CHAPTER 17, 2018 IBC)									
SPECIAL INSPECTION COMPANY / COORDINATOR – TO BE RETAINED BY OWNER									
BUILDING SYSTEM OR COMPONENT	MATERIAL SUBMITTAL	TESTING			INSPECTION (PER IBC)			QUALITY ASSURANCE (PER IBC)	
		REQUIREMENTS	FREQUENCY	AGENCY	MONITORING	FREQUENCY	AGENCY	PART OF WIND	PART OF SEISMIC
SOILS (COMPACTED FILL)  NOTE: THIS SECTION MAY BE MODIFIED BY PROJECT GEOTECHNICAL ENGINEER BASED ON PROJECT SOIL CONDITIONS.	N/A	1. TEST IN PLACE DRY DENSITY OF COMPACTED FILL.	1. AS APPROVED GEOTECHNICAL ENGINEER.	TESTING LAB TO BE APPROVED BY SPECIAL INSPECTION COORDINATOR & BUILDING OFFICIAL	AS EXCAVATION AND FILL PLACEMENT BEGINS, THE FOLLOWING SHALL BE VERIFIED TO ENSURE COMPLIANCE WITH GEOTECHNICAL REPORT: 1. MATERIALS BELOW SHALLOW FOUNDATIONS ARE ADEQUATE TO ACHIEVE THE DESIGN BEARING CAPACITY AS SPECIFIED IN SOILS REPORT. 2. EXCAVATIONS ARE EXTENDED TO PROPER DEPTH AND HAVE REACHED PROPER MATERIAL. 3. PERFORM CLASSIFICATION AND TESTING OF COMPACTED FILL MATERIALS. 4. USE OF PROPER MATERIALS, DENSITIES AND LIFT THICKNESSES DURING PLACEMENT AND COMPACTION OF COMPACTED FILL. 5. PRIOR TO PLACEMENT OF COMPACTED FILL, OBSERVE SUBGRADE AND VERIFY THAT SITE HAS BEEN PREPARED PROPERLY.	1. PERIODIC 2. PERIODIC 3. PERIODIC 4. CONTINUOUS 5. PERIODIC	INSPECTION AGENCY TO BE APPROVED BY SPECIAL INSPECTION COORDINATOR & BUILDING OFFICIAL	1. COLUMNS AND SHEARWALLS ACCORDANCE WITH APPROVED SOILS REPORT PRIOR TO PLACEMENT OF FILL.	1. COLUMNS AND SHEARWALLS ACCORDANCE WITH APPROVED SOILS REPORT PRIOR TO PLACEMENT OF FILL.
CONCRETE FOUNDATIONS	1. SUBMIT CONCRETE MIX DESIGN. 2. SUBMIT FOUNDATION REINFORCEMENT SHOP DRAWINGS. 3. VERIFY PROPER CONCRETE STRENGTH.	1. TEST CONCRETE STRENGTH.	1. A MINIMUM OF (4) CYLINDERS SHALL BE TAKEN FOR EVERY 50 CUBIC YARDS (OR FRACTION THEREOF) OF EACH TYPE AND STRENGTH OF CONCRETE PER DAY.	TESTING LAB TO BE APPROVED BY SPECIAL INSPECTION COORDINATOR & BUILDING OFFICIAL	AS CONCRETE AND REINFORCING STEEL CONSTRUCTION BEGINS, THE FOLLOWING SHALL BE INSPECTED TO ENSURE COMPLIANCE: 1. VERIFY REINFORCING SIZE, QUANTITY & PLACEMENT 2. ANCHORS CAST IN CONCRETE 3. ANCHORS POST INSTALLED IN HARDENED CONCRETE 4. VERIFYING USE OF REQUIRED DESIGN MIX 5. AT THE TIME FRESH CONCRETE IS SAMPLED TO FABRICATE SPECIMENS FOR STRENGTH TESTS, PERFORM SLUMP AND AIR CONTENT TEST, AND DETERMINE THE TEMPERATURE OF CONCRETE 6. CONCRETE PLACEMENT FOR PROPER APPLICATION TECHNIQUES 7. INSPECT FORMWORK FOR, SHAPE, LOCATION AND DIMENSIONS OF THE CONCRETE MEMBER BEING FORMED	1. PERIODIC 2. PERIODIC 3. PERIODIC 4. PERIODIC 5. CONTINUOUS 6. CONTINUOUS 7. PERIODIC	INSPECTION AGENCY TO BE APPROVED BY SPECIAL INSPECTION COORDINATOR & BUILDING OFFICIAL	1. SPREAD FOOTINGS AT BEARING WALLS AND SHEARWALL.	1. SPREAD FOOTINGS AT BEARING WALLS AND SHEARWALL.
CONCRETE MASONRY UNITS	1. SUBMIT TEST DATA ON CMU UNITS NET AREA OF COMPRESSIVE STRENGTH 2. SUBMIT MORTAR & GROUT MIX DESIGNS	1. TEST COMPRESSIVE STRENGTH OF MORTAR & GROUT.	1. (1) SET OF GROUT CUBES FROM EACH FLOOR AND/OR (1) SET OF CUBES FOR EACH 20 YARDS (OR FRACTION THEREOF) PER DAY	TESTING LAB TO BE APPROVED BY SPECIAL INSPECTION COORDINATOR & BUILDING OFFICIAL PER IBC	SEE MASONRY INSPECTION CHART	SEE MASONRY INSPECTION CHART	INSPECTION AGENCY TO BE APPROVED BY SPECIAL INSPECTION COORDINATOR & BUILDING OFFICIAL PER IBC	1. YES	1. YES
STRUCTURAL STEEL	1. SUBMIT MANUFACTURER'S CERTIFIED MILL TEST REPORTS FOR STRUCTURAL STEEL.	N/A	N/A	N/A	1. INSPECT STEEL FRAME JOINT DETAILS FOR COMPLIANCE WITH CONSTRUCTION DOCUMENTS.	1. PERIODIC	INSPECTION AGENCY TO BE APPROVED BY SPECIAL INSPECTION COORDINATOR & BUILDING OFFICIAL PER IBC	1. FLOOR AND ROOF SYSTEM FRAMING	1. FLOOR AND ROOF SYSTEM FRAMING
STRUCTURAL STEEL HIGH – STRENGTH BOLTING (AND MECHANICAL FASTENING OF METAL DECK)	1. SUBMIT MANUFACTURER'S CERTIFICATE OF COMPLIANCE FOR HIGH-STRENGTH BOLTS, NUTS, WASHERS AND/OR FASTENERS.	N/A	N/A	N/A	1. VERIFY BOLTING IN BEARING-TYPE CONNECTIONS ARE INSTALLED IN ACCORDANCE WITH AISC SPECIFICATIONS. 2. VERIFY BOLTING IN SLIP-CRITICAL CONNECTIONS ARE INSTALLED IN ACCORDANCE WITH AISC SPECIFICATIONS. 3. VERIFY IDENTIFICATION MARKING ON HIGH-STRENGTH BOLTS, NUTS AND WASHERS CONFORMING TO ASTM STANDARDS SPECIFIED. 4. VERIFY FASTENER TYPE AND ADHERENCE TO SPECIFIED FASTENER ATTACHMENT PATTERN. 5. VERIFY PROPER STORAGE AND HANDLING OF BOLTS, NUTS, WASHERS.	1. PERIODIC 2. CONTINUOUS (MAY BE PERIODIC IF TURN-OF-NUT WITH MATCH MARKING METHODS, DIRECT TENSION INDICATOR OR ALTERNATE DESIGN FASTENER (TWIST-OFF) METHODS ARE USED) 3. PERIODIC 4. PERIODIC 5. PERIODIC	INSPECTION AGENCY TO BE APPROVED BY SPECIAL INSPECTION COORDINATOR & BUILDING OFFICIAL PER IBC	1. FLOOR AND ROOF SYSTEM BOLTING	1. FLOOR AND ROOF SYSTEM BOLTING
STRUCTURAL STEEL WELDING	1. SUBMIT MANUFACTURER'S CERTIFICATE OF COMPLIANCE FOR WELD FILLER MATERIAL.	N/A	N/A	N/A	VERIFY WELDING IS IN COMPLIANCE WITH AWS D1.1 1. COMPLETE AND PARTIAL PENETRATION GROOVE WELDS. 2. MULTIPASS FILLET WELDS 3. SINGLE-PASS FILLET WELDS > 5/16" 4. SINGLE-PASS FILLET WELDS < OR = 5/16" 5. FLOOR AND DECK WELDS	1. CONTINUOUS 2. CONTINUOUS 3. CONTINUOUS 4. PERIODIC 5. PERIODIC	INSPECTION AGENCY TO BE APPROVED BY SPECIAL INSPECTION COORDINATOR & BUILDING OFFICIAL PER IBC	1. FLOOR AND ROOF SYSTEM WELDING	1. FLOOR AND ROOF SYSTEM WELDING
NOTE: ALL TESTING, INSPECTION & RELATED REPORTS SHALL BE SENT TO THE SPECIAL INSPECTION COORDINATOR & THE OWNER. ANY DEFICIENCIES SHALL BE CLEARLY NOTED & BROUGHT TO THE ATTENTION OF THE SPECIAL INSPECTION COORDINATOR BEFORE THE END OF THE INSPECTOR'S SHIFT.									

DEFINITIONS:  
– SPECIAL INSPECTOR: PER IBC. "A QUALIFIED PERSON EMPLOYED OR RETAINED BY AN APPROVED AGENCY AND APPROVED BY THE BUILDING OFFICIAL AS HAVING THE COMPETENCE NECESSARY TO INSPECT A PARTICULAR TYPE OF CONSTRUCTION REQUIRING SPECIAL INSPECTION".  
– PERIODIC SPECIAL INSPECTION: PER IBC. "SPECIAL INSPECTION BY THE SPECIAL INSPECTOR WHO IS INTERMITTENTLY PRESENT WHERE THE WORK TO BE INSPECTED HAS BEEN OR IS BEING PERFORMED".  
– CONTINUOUS SPECIAL INSPECTION: PER IBC. "SPECIAL INSPECTION BY THE SPECIAL INSPECTOR WHO IS PRESENT WHEN AND WHERE THE WORK TO BE INSPECTED IS BEING PERFORMED". THIS IS INTENDED TO BE A CONTINUOUS INSPECTION.


FOR CONSTRUCTION

Revisions	
Revision	By

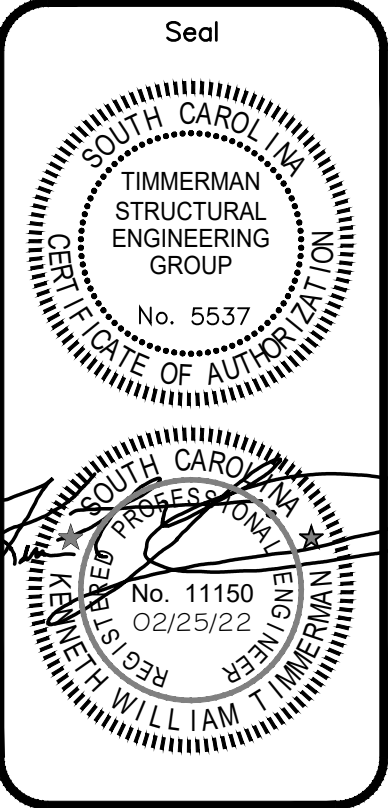

Job Title:

**RIVERBANKS ZOO & GARDEN BARN ADDITION**  
500 WILDLIFE PARKWAY  
COLUMBIA, SOUTH CAROLINA 29210

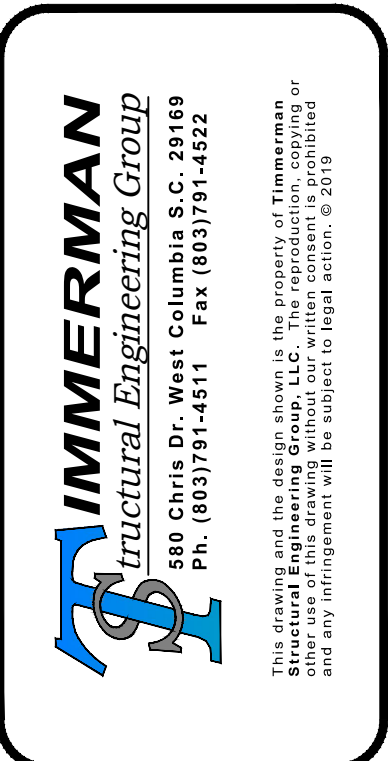

Drawing Title:

SPECIAL INSPECTIONS

Scale: AS NOTED

Job Number: 22-102

Designed By: KWT

Drawn By: TJD

Checked By: KWT

Date: 02/25/2022



ELECTRICAL SPECIFICATIONS

A. GENERAL:

1. PROVIDE ALL WORK, EQUIPMENT, SERVICES, LABOR AND MATERIALS NECESSARY TO INSTALL COMPLETE AND FUNCTIONAL ELECTRICAL SYSTEMS AS DESCRIBED OR IMPLIED BY THE CONTRACT DOCUMENTS.
2. INSTALLATION SHALL BE IN ACCORDANCE WITH THE LATEST APPLICABLE RULES OF THE LATEST ADOPTED EDITIONS OF THE NATIONAL ELECTRICAL CODE – NFPA-70, NATIONAL ELECTRIC SAFETY CODE – ANSI-C2, LIFE SAFETY CODE – NFPA-101, STATE AND LOCAL CODES, THE AMERICANS WITH DISABILITIES ACT, INTERNATIONAL ENERGY CONSERVATION CODE – IECC, AND THE INTERNATIONAL BUILDING CODE –IBC.
3. APPLY AND PAY FOR ALL PERMITS AND INSPECTIONS.
4. MATERIALS SHALL BE NEW AND AS SPECIFIED AND SHALL NOT BE SUBSTITUTED UNLESS WRITTEN AUTHORITY IS OBTAINED FROM THE ENGINEER. ALL MATERIALS SHALL BE UNDERWRITERS APPROVED AND BEAR THE UL LABEL, BE STANDARD PRODUCTS AND BE THE MANUFACTURERS LATEST DESIGN. ALL ITEMS OF THE SAME TYPE OR RATING SHALL BE IDENTICAL AND OF THE SAME MANUFACTURER.
5. PREPLAN ALL WORK PRIOR TO ORDERING, PURCHASING OR FABRICATION ANY PART OF THE WORK DESCRIBED BY THIS DRAWING.
6. THE ELECTRICAL CONTRACTOR SHALL VERIFY THE NAMEPLATE RATINGS OF ALL EQUIPMENT THAT IS SUPPLIED AND/OR INSTALLED BY OTHERS.
7. THE ELECTRICAL CONTRACTOR SHALL COORDINATE THE LOCATION, SIZE AND TYPE OF ELECTRICAL CONNECTIONS TO MECHANICAL EQUIPMENT AND MAKE CONNECTIONS IN ACCORDANCE WITH MANUFACTURERS RECOMMENDATIONS.
8. MECHANICAL EQUIPMENT SHALL BE WIRED THROUGH A FUSED DISCONNECT SWITCH LOCATED ON OR IMMEDIATELY ADJACENT TO THE EQUIPMENT BEING SERVED, SUCH SWITCH SHALL BE RATED ACCORDING TO THE MECHANICAL EQUIPMENT MANUFACTURERS RECOMMENDATIONS.
9. IMMEDIATELY NOTIFY THE ENGINEER OF ANY CONFLICTS WITH EXISTING FIELD CONDITIONS OR THE WORK OF OTHER TRADES.
10. RESOLVE ALL CONFLICTS PRIOR TO INCURRING ANY MATERIAL OR LABOR EXPENSES.
11. LOCATE ALL WORK GENERALLY AS SHOWN ON THIS DRAWING; HOWEVER COORDINATE EQUIPMENT, LIGHT FIXTURE, AND DEVICE LOCATIONS WITH ACTUAL FIELD CONDITIONS TO OBTAIN CODE-REQUIRED AND MANUFACTURER-DICTATED SERVICE CLEARANCES.
12. COMPLY WITH THE MANUFACTURERS TECHNICAL INSTRUCTIONS WHEN INSTALLING ELECTRICAL EQUIPMENT, LIGHT FIXTURES, DEVICES AND MATERIALS.
13. PROVIDE ALL APPURTENANCES NECESSARY TO PROPERLY INSTALL EQUIPMENT, LIGHT FIXTURES, DEVICES, MATERIALS, ETC.
14. THE ELECTRICAL CONTRACTOR SHALL PROVIDE ALL WORK AND COSTS REQUIRED TO MAKE CONNECTION TO ELECTRIC AND TELEPHONE UTILITIES, CONSULT CIVIL PLAN FOR TIE-IN LOCATIONS, AND VERIFY INTENDED LOCATIONS WITH ENGINEER AND OWNER PRIOR TO INSTALLATION.
15. EQUIPMENT SHALL BE SUITABLE FOR ITS APPLICATION (E.G. WHEN INSTALLED OUTDOORS, IT SHALL BE WEATHERPROOF ETC.).
16. THE ELECTRICAL INSTALLATION SHALL COMPLY WITH THE INTERNATIONAL BUILDING CODE –IBC – CHAPTER 16-REFERENCE TO-ASSE CHAPTER 13 SECTION.
- SEISMIC DESIGN REQUIREMENTS FOR NONSTRUCTURAL COMPONENTS.
- NONSTRUCTURAL COMPONENTS INCLUDE MECHANICAL AND ELECTRICAL SYSTEMS.
1. SPRINKLER SYSTEMS
2. ESCALATORS AND ELEVATORS
3. VESSELS
4. PIPING
5. HVAC DUCTING
6. LIGHTING FIXTURES
7. ELECTRICAL EQUIPMENT

B. RACEWAYS:

1. ALL CONDUCTORS AND CABLES SHALL BE INSTALLED IN RACEWAYS. TYPE MC CABLE WILL BE CONSIDERED TO MEET THIS REQUIREMENT AND THE INTENT OF THIS SPECIFICATION. TYPE NMC CABLE CAN BE USED AS SPECIFIED BELOW.
2. ALL CONDUIT SHALL BE ½ INCH MINIMUM SIZE AND ZINC-COATED EMT, EXCEPT IN WET, DAMP OR WASH DOWN AREAS WHERE ZINC-COATED RIGID STEEL (GRS) OR IMMEDIATE METALLIC CONDUIT (MC) SHALL BE USED.
3. EMT FITTINGS SHALL BE STEEL SET SCREW TYPES. FLEXIBLE CONDUIT CONNECTORS SHALL BE STEEL COMPRESSION TYPES.
4. SECURE CONDUITS USING MANUFACTURED, GALVANIZED STRAPS. TIE WIRE IS NOT ALLOWED.
5. IN FINISHED AREAS, ROUTE ALL CONDUIT CONCEALED ABOVE CEILINGS, IN WALLS OR CASEWORK, OR BELOW GRADE.
6. THOROUGHLY COAT ALL UNDERGROUND METALLIC CONDUITS WITH TWO COATS OF ASPHALTUM OR BITUMASTIC PAINT. CONDUITS INSTALLED UNDERGROUND ON THE EXTERIOR OF THE BUILDING SHALL BE BURIED 2- FEET 0-INCHES MINIMUM UNDER ROADWAYS AND PARKING AREAS.
7. RIGID NONMETALLIC CONDUIT MAY BE USED CONCEALED IN WALLS, FLOORS AND CEILINGS, FOR THE SECONDARY UNDERGROUND SERVICE, THE UNDERGROUND TELEPHONE SERVICE CONDUIT, BRANCH CIRCUITS AND TELEPHONE SYSTEM CONDUITS LOCATED BELOW THE CONCRETE FLOOR SLAB ON GRADE OR BURIED ON THE EXTERIOR OF THE BUILDING. ALL PVC SHALL BE SCHEDULE 40 (UNLESS NOTED OTHERWISE) POLYVINYL CHLORIDE UL LISTED FOR USE WITH 75C CONDUCTORS. INSTALLATION SHALL COMPLY WITH ALL CODES, THE UTILITY COMPANY REGULATIONS, AND THE MANUFACTURERS INSTRUCTIONS. INSTALL SEPARATE BONDING CONDUCTOR IN ALL PVC RACEWAYS.
8. ALL PVC COMPONENTS OF THE PVC CONDUIT SYSTEM SHALL BE FURNISHED FROM THE SAME MANUFACTURER AND USED SPECIFICALLY FOR THEIR INTENDED PURPOSE.
9. RIGID NONMETALLIC CONDUIT SHALL NOT BE INSTALLED IN PATIENT CARE AREAS OF HEALTH CARE FACILITIES.
10. PROVIDE PULL CORDS IN ALL EMPTY CONDUITS. INSTALL GREEN GROUNDING CONDUCTOR IN ALL FLEXIBLE RACEWAYS.
11. ALL OUTLET BOXES SHALL BE GALVANIZED STEEL EXCEPT THAT CAST BOXES WITH GASKETED COVERS SHALL BE REQUIRED IN ALL INTERIOR WET AREAS AND ON THE EXTERIOR OF THE BUILDING. OUTLET BOXES SHALL BE NO LESS THAN 4 IN X 4 IN. X 2 IN. DEEP.

C. WIRING:

1. CONDUCTORS SHALL BE COPPER, THHN/THWN 90 DEGREE C, 600 VOLTS, SOLID FOR #10 AWG OR #12 AWG, AND STRANDED FOR ALL LARGER SIZES. CONTROL CIRCUIT CONDUCTORS MAY BE #14 AWG SOLID. ALL 208V/120 VAC CONDUCTORS SHALL BE COLOR-CODED BLACK, RED, BLUE, WHITE, AND GREEN FOR PHASES A, B, C, NEUTRAL AND GROUND RESPECTIVELY. ALL 480Y/277 VAC CONDUCTORS SHALL BE COLOR-CODED BROWN, ORANGE, YELLOW, NATURAL GRAY, AND GREEN FOR PHASES A, B, C, NEUTRAL, AND GROUND RESPECTIVELY.
2. ALL CONDUCTORS AND CABLES SHALL BE INSTALLED IN CONDUITS AND TESTED FOR CONTINUITY AND GROUND BEFORE BEING ENERGIZED, ALL FAULTY CONDUCTORS SHALL BE REPLACED.
3. NO WIRE SMALLER THAN #12 SHALL BE INSTALLED UNLESS INDICATED.
4. VERIFY THAT THE ELECTRICAL CHARACTERISTICS OF CIRCUITS ARE CORRECT PRIOR TO ENERGIZING THE EQUIPMENT.
5. FULLY COORDINATE WITH THE OTHER TRADES TO DETERMINE THE POWER REQUIREMENTS AND CONNECTION POINTS FOR EQUIPMENT FURNISHED BY OTHERS. PROVIDE ELECTRICAL POWER TO EACH PIECE OF EQUIPMENT BASED UPON THE MANUFACTURERS WIRING DIAGRAMS AND UNIT MOUNTED NAMEPLATES.
6. THE CONDUIT AND NEUTRAL CONDUCTORS OF THE ELECTRICAL SYSTEM AND ALL ELECTRICAL EQUIPMENT SHALL BE GROUNDED. PROVIDE AN INSULATED EQUIPMENT GROUNDING CONDUCTOR WITH EVERY ISOLATED CIRCUIT. THE CONDUIT SYSTEM AND NEUTRAL CONDUCTORS SHALL BE BONDED TOGETHER ONLY AT THE SERVICE ENTRANCE EQUIPMENT. GROUNDING AT THE SERVICE ENTRANCE SHALL COMPLY WITH NEC ARTICLE 250.
7. WHERE TYPE AC OR MC CABLE IS INSTALLED IN HEALTH CARE FACILITIES, INCLUDING DOCTOR'S OFFICES, THE METAL SHEATH SHALL BE LISTED AS AN EGC. IT SHALL ALSO HAVE AN INTERNAL INSULATED EQUIPMENT GROUNDING CONDUCTOR.
8. BRANCH CIRCUITS IN PATIENT CARE AREAS SHALL PROVIDE REDUNDANT GROUNDING FOR RECEPTACLES AND ELECTRICAL EQUIPMENT. THE WIRING SHALL BE INSTALLED IN METAL RACEWAYS PROPERLY INSTALLED TO ACT AS AN EQUIPMENT GROUNDING CONDUCTOR OR METAL CLAD CABLES WHOSE METAL SHEATHS ARE LISTED FOR USE AS AN EQUIPMENT GROUNDING CONDUCTOR. THE SYSTEM SHALL ADDITIONALLY INCLUDE AN INSULATED COPPER EQUIPMENT GROUNDING CONDUCTOR SIZED IN ACCORDANCE WITH 250.122.
9. TYPE NMC CABLE CAN BE USED FOR CONCEALED WORK IN NORMALLY DRY LOCATIONS. IT SHALL BE CONCEALED WITHIN WALLS, FLOORS OR CEILINGS THAT HAVE AT LEAST A 15 MINUTE FIRE RATING. IT SHALL NOT BE INSTALLED EXPOSED IN DROPPED OR SUSPENDED CEILINGS. TYPE NMC CABLE SHALL NOT BE USED IN PATIENT CARE AREAS OF HEALTH CARE FACILITIES.

D. POWER EQUIPMENT:



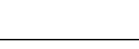
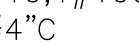
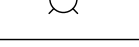
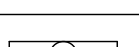
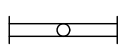

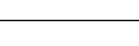



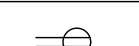

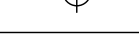

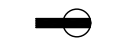








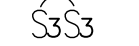


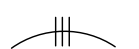



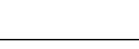
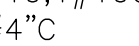
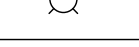
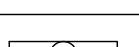

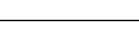


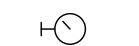











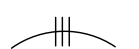


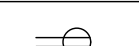

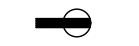

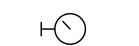
1. PANEL BOARDS SHALL BE DEAD-FRONT SAFETY TYPE WITH FULL HEIGHT, ALUMINUM OR COPPER BUSSING AND A NOMINAL 22 INCHES WIDE CABINET. ALL CIRCUIT BREAKERS SHALL BE MOLDED CASE, BOLT-ON, AUTOMATIC THERMAL MAGNETIC TYPE, CALIBRATED FOR 40C OR AMBIENT COMPENSATING. ALL DIRECTORIES SHALL BE TYPED.
2. SAFETY SWITCHES SHALL BE GENERAL DUTY, QUICK-MAKE, QUICK-BREAK, TYPES OF THE SIZE AND FUSE AMPACITY AS DENOTED ON THE DRAWINGS. PROVIDE GROUND BUS, SOLID NEUTRAL (WHEN CIRCUIT HAS A NEUTRAL), CLASS RK-5 DUAL ELEMENT TIME DELAY FUSES, REJECTION TYPE FUSE HOLDERS AND NEMA RATED ENCLOSURE.
3. SERVICE ENTRANCE EQUIPMENT SHALL BE IN ACCORDANCE WITH NEC-230 AND APPROVED BY THE LOCAL AUTHORITY HAVING JURISDICTION. THE ELECTRICAL CONTRACTOR SHALL COORDINATE SHORT CIRCUIT RATING WITH THE LOCAL SERVING UTILITY, AND PROVIDE EQUIPMENT THAT EXCEEDS THE INTERRUPTING DEMAND OF THE AVAILABLE SHORT CIRCUIT CURRENT. ELECTRICAL CONTRACTOR SHALL CO-ORDINATE METERING REQUIREMENTS WITH THE SERVING ELECTRICAL UTILITY. FURNISH ANY EQUIPMENT REQUIRED BY UTILITY FOR CT METERING OR METER CANS AND OBTAIN APPROVAL FROM UTILITY PRIOR TO START OF ELECTRICAL WORK.
4. ALL ELECTRICAL EQUIPMENT SHALL BE PERMANENTLY MARKED TO CONFORM TO DESIGNATIONS ON THE DRAWINGS AND ALSO PER THE INSTRUCTIONS OF THE AUTHORITY HAVING JURISDICTION.

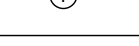
E. DEVICES:

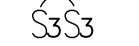1. EXCEPT IN HEALTH CARE FACILITIES, ALL WIRING DEVICES SHALL BE SPECIFICATION GRADE. THE COLOR SHALL BE SELECTED BY THE ARCHITECT FROM THE MANUFACTURERS STANDARD COLORS.
2. RECEPTACLES AT PATIENT BED LOCATIONS IN HEALTH CARE FACILITIES SHALL BE HOSPITAL GRADE AND SHALL BE IDENTIFIED WITH A GREEN DOT ON THE FACE OF THE RECEPTACLE, AND THE WORDS "HOSPITAL-GRADE" STAMPED ON THE DEVICE'S MOUNTING STRAP.
3. SWITCHES SHALL BE QUIET OPERATING TYPES RATED 20A.
4. RECEPTACLES SHALL BE NEMA 5-20R TYPES UNLESS OTHERWISE NOTED.
5. PROVIDE A SINGLE MULTI-GANG BOX AND DEVICE PLATE FOR ALL GROUP MOUNTED WIRING DEVICES.
6. ALL COVER PLATES SHALL BE PLASTIC TYPE UNLESS OTHERWISE NOTED.
7. GFI RECEPTACLES SHALL BE INSTALLED IN AREAS OUTLINED IN NEC. ALL RECEPTACLES LOCATED WITHIN SIX FEET OF A SINK OR OTHER SOURCE OF WATER SHALL BE GFI. ALL RECEPTACLES LOCATED IN WET AREAS SHALL BE GFI.

F. LIGHTING EQUIPMENT:

1. ALL LIGHT FIXTURES SHALL BE PROVIDED COMPLETE WITH LAMPS, ALL NECESSARY ACCESSORIES AND AS DESCRIBED ON THE DRAWINGS. COORDINATE ALL CONSTRUCTION DETAILS SUCH AS PROPER FIXTURE TRIM WITH CEILING CONSTRUCTION.
2. CEILING MOUNTED AND SUSPENDED LIGHT FIXTURES SHALL BE SUPPORTED BY A METHOD RATED AT LEAST FIVE TIMES THE SUPPORT WEIGHT. THE METHOD SHALL ALSO COMPLY WITH ARTICLES 410-15 AND 410-16 AS APPROPRIATE OF THE NEC.
3. MAGNETIC BALLAST SHALL BE ENERGY SAVING, 90% OR BETTER POWER FACTOR, CLASS P, A SOUND-RATED TYPES WITH NO PCB MATERIALS.
4. ELECTRONIC BALLASTS SHALL BE SOLID-STATE, NO FLICKER, 99% POWER FACTOR, WITH THD 10%-15%. CLASS A SOUND-RATED OR BETTER TYPES WITH NO PCB MATERIALS.
5. VERIFY EACH LIGHT FIXTURE AGAINST THE ARCHITECTS ROOM FINISHES AND RESOLVE ALL CONFLICTS BEFORE ORDERING LIGHT FIXTURES.
6. EXIT SIGNS SHALL HAVE DIRECTIONAL ARROWS AS SHOWN ON THE DRAWING.
7. EMERGENCY EGRESS LIGHT FIXTURES SHALL BE INSTALLED 8 FT. -0 IN. AFF OR 1 FT. -0 IN. BELOW FINISHED CEILING HEIGHT.
8. CONNECT EXIT SIGNS AND EGRESS LIGHT FIXTURES DIRECTLY TO THE LOCAL LIGHT CIRCUIT BUT AHEAD OF ANY SWITCHES OR DIMMERS.
9. PROVIDE LOW TEMPERATURE LAMPS AND BALLASTS FOR FIXTURES INSTALLED IN UNHEATED AREAS.
10. PATHS OF EGRESS HEADROOM, OBJECTS PROTRUDING FROM THE CEILINGS OF PATHS OF EGRESS SHALL PROTRUDE ONLY TO 80" ABOVE THE FLOOR.


ELECTRICAL SYMBOLS LEGEND			
S <sub>2</sub>	TWO-POLE WALL SWITCH		2#12 AWG, CU PHASE AND NEUTRAL CONDUCTORS IN CONDUIT OR CABLE. AN ADDITIONAL GROUNDED CONDUCTOR IS REQUIRED.
S <sub>3</sub>	3-WAY WALL SWITCH		CONDUCTORS IN CONDUIT OR CABLE. CROSSMARKS INDICATE NUMBER OF #12 AWG CU PHASE AND NEUTRAL CONDUCTORS. AN ADDITIONAL GROUNDED CONDUCTOR IS REQUIRED.
S <sub>3D</sub>	3-WAY DIMMER SWITCH		HOMERUN TO PANEL. CONDUCTORS IN CONDUIT OR CABLE, CROSSMARKS INDICATE NUMBER OF #12 AWG CU PHASE AND NEUTRAL CONDUCTORS. AN ADDITIONAL GROUNDED CONDUCTOR IS REQUIRED.
S <sub>4</sub>	FOUR-POLE WALL SWITCH		HOMERUN TO PANEL, SIZE AS NOTED
S <sub>M</sub>	MOTOR SWITCH		
S <sub>MC</sub>	MOMENTARY CONTACT, LOW VOLTAGE SWITCH		
S <sub>MS</sub>	MOTION SENSOR SWITCH		
S <sub>OC</sub>	OCCUPANCY SENSOR SWITCH, DUAL TECHNOLOGY, ON/OFF/AUTO		
S <sub>D</sub>	DIMMER SWITCH, SINGLE POLE		
S <sub>D KEY</sub>	DIMMER SWITCH, SINGLE POLE, KEY OPERATED.		
S <sub>MC</sub> 3	MOMENTARY CONTACT, LOW VOLTAGE SWITCH WITH LOW VOLTAGE CIRCUIT TO LIGHTING RELAY PANEL CONTROL. NUMERAL INDICATES CIRCUIT CONTROLLED. OVERRIDES AUTO SHUT OFF PER IECC.		
◀	TELEPHONE SYSTEM CABLE OUTLET – STUB 3/4" C TO ABOVE CEILING INSTALL CABLE TO COMM. DEMARC POINT.		
◀	TELEPHONE SYSTEM CABLE OUTLET – MOUNTED ABOVE COUNTER HEIGHT, STUB 3/4"C TO ABOVE CEILING INSTALL CABLE TO COMM. DEMARC POINT.		
◁	COMMUNICATION/DATA SYSTEM CABLE OUTLET – STUB 3/4" C TO ABOVE CEILING INSTALL CABLE TO COMM. DEMARC POINT.		
▷	R66 COAXIAL CABLE OR AS REQUIRED BY TELEVISION SYSTEM OUTLET CONFIGURED ON WALL PLATE. INSTALL CABLE TO TELEVISION SYSTEM DEMARC POINT.		
◀	DUAL JACK OUTLET, ONE RJ11 OR AS REQUIRED BY TELEPHONE SYSTEM AND ONE RJ45S OR AS REQUIRED BY COMPUTER SYSTEM OR HDMI AS REQUIRED BY VIDEO. CONFIGURED ON WALL PLATE. INSTALL CABLE TO COMM. DEMARC POINT.		
◀	DUAL JACK OUTLET, ONE RJ11 OR AS REQUIRED BY TELEPHONE SYSTEM AND ONE RJ45S OR AS REQUIRED BY COMPUTER SYSTEM OR HDMI AS REQUIRED BY VIDEO. CONFIGURED ON WALL PLATE. INSTALL CABLE TO COMM. DEMARC POINT. ABOVE COUNTER HEIGHT.		
●	FLOOR TELEPHONE SYSTEM CABLE OUTLET. INSTALL 3/4" C TO WALL AND STUB TO ABOVE CEILING INSTALL CABLE TO COMM. DEMARC POINT.		
⊙	JUNCTION BOX WITH SUSPENDED FLEXIBLE CABLE. THE CABLE SHALL HAVE A STRAIN RELIEF CORD GRIP AT THE TOP AS MANUFACTURED BY WOODHEAD OR EQUAL. CABLE SHALL BE ROUND PENDANT CABLE, MULTICONDUCTOR WITH PVC JACKET, SIZE AND CONFIGURATION AS NOTED. CONNECT TO EQUIPMENT BELOW, RECEPTACLES AS NOTED.		
H TV	TV SYSTEM CABLE OUTLET/120V DUPLEX RECEPTACLE, 84" AFF. STUB 3/4"C TO ABOVE CEILING. INCLUDES COMM. CONDUITS. CONDUITS FOR HDMI CABLES SHALL BE 2"C MINIMUM.		
TV	TV SYSTEM CABLE OUTLET/120V DUPLEX RECEPTACLE, CEILING MOUNTED. STUB 3/4"C TO ABOVE CEILING. INCLUDES COMM. CONDUITS. CONDUITS FOR HDMI CABLES SHALL BE 2"C MINIMUM.		
⊠	MASS NOTIFICATION SPEAKER WITH AMBER STROBE.		
ACU	AUTONOMIUS CONTROL UNIT FOR MASS NOTIFICATION SYSTEM		
H S	MASS NOTIFICATION SPEAKER EXTERIOR WALL MOUNTED NEMA3R		
VS	DUAL TECHNOLOGY PASSIVE INFRARED (PIR) AND ULTRASONIC (US) CEILING MOUNTED VACANCY SENSOR LIGHTING CONTROL. ALL SPACES WITH VACANCY SENSORS SHALL BE SET FOR MANUAL ON, AUTOMATIC AND MANUAL OFF CONTROL		
Svs	DUAL TECHNOLOGY PASSIVE INFRARED (PIR) AND ULTRASONIC (US) VACANCY SENSOR SWITCH. ALL SPACES WITH VACANCY SENSORS SHALL BE SET FOR MANUAL ON, AUTOMATIC AND MANUAL OFF CONTROL		
MD	MOTION DETECTOR		
BMS	BALANCED MAGNETIC SWITCH		
◻	CEILING MOUNTED CCTV CAMERA LOCATION FOR AUDIO/VISUAL SYSTEM.		
⊙	MASS NOTIFICATION SPEAKER CEILING MOUNTED.		
⊠	SIPR, PHONE & DATA DROPS IN HOLOCOM DROP BOX WITH HOLOCOM MINI DUCT TUBE UP TO HOLOCOM 2'X2' SECURE RACEWAY. INSTALL COMM CABLES. SIPR CABLES ARE NOT A PART OF THIS CONTRACT.		
⊠	ANSUL PULL STATION		
⊕	3 WIRE RECEPTACLE TO MATCH EQUIPMENT PLUG OR AS NOTED.		
			2#12 AWG, CU PHASE AND NEUTRAL CONDUCTORS IN CONDUIT OR CABLE. AN ADDITIONAL GROUNDED CONDUCTOR IS REQUIRED.
			CONDUCTORS IN CONDUIT OR CABLE. CROSSMARKS INDICATE NUMBER OF #12 AWG CU PHASE AND NEUTRAL CONDUCTORS. AN ADDITIONAL GROUNDED CONDUCTOR IS REQUIRED.
			HOMERUN TO PANEL. CONDUCTORS IN CONDUIT OR CABLE, CROSSMARKS INDICATE NUMBER OF #12 AWG CU PHASE AND NEUTRAL CONDUCTORS. AN ADDITIONAL GROUNDED CONDUCTOR IS REQUIRED.
			HOMERUN TO PANEL, SIZE AS NOTED
			LIGHTING FIXTURE, CEILING MOUNTED
			LIGHTING FIXTURE, WALL MOUNTED
			LIGHTING FIXTURE SEE SCHEDULE
			STRIP LIGHTING FIXTURE
			LIGHTING FIXTURE, RECESSED
			EXIT LIGHT FIXTURE, CEILING MOUNTED
			EXIT LIGHT FIXTURE, WALL MOUNTED
			COMBINATION EXIT LIGHT AND EMERGENCY LIGHTING
			COMBINATION EXIT AND EMERGENCY LIGHT WITH REMOTE HEAD
			SOLID STATE BATTERY PACK EMERGENCY LIGHTING UNIT
			EMERGENCY LIGHT, DECORATIVE
			DUPLEX RECEPTACLE MOUNTED 18" AFF UNLESS NOTED OTHERWISE.
			TANDEM DUPLEX RECEPTACLES IN ONE BOX MOUNTED 18" AFF UNLESS NOTED OTHERWISE.
			DUPLEX RECEPTACLE ABOVE COUNTER MOUNTED .42" AFF UNLESS NOTED OTHERWISE.
			DUPLEX RECEPTACLE, HALF HOT, HALF SWITCHED, OR SPLIT WIRED MOUNTED 18" AFF UNLESS NOTED OTHERWISE.
			GROUND FAULT INTERRUPTING DUPLEX RECEPTACLE MOUNTED 18" AFF UNLESS NOTED OTHERWISE.
			POWER RECEPTACLE, CONFIGURATION AND/OR AMPS AS NOTED MOUNTED 18" AFF UNLESS NOTED OTHERWISE.
			DUPLEX RECEPTACLE 12" BELOW CEILING
			FLOOR MOUNTED DUPLEX CONVENIENCE OUTLET, FLANGE AS REQUIRED
			TWO (2) DUPLEX RECEPTACLES MOUNTED IN DOUBLE GANG BOX. 20A,120V,2P,3W, GROUNDING, 5-20R. FLANGE AS REQUIRED.
			CLOCK OUTLET, 120V,2P,3W
			DUAL JACK OUTLET, ONE RJ11 OR AS REQUIRED BY TELEPHONE SYSTEM AND ONE RJ45S OR AS REQUIRED BY COMPUTER SYSTEM. FLOOR MOUNTED
			JUNCTION BOX
			THERMOSTAT
			MOTOR
			DISCONNECT SWITCH, NON-FUSED OR FUSED AS SHOWN OR REQUIRED
			SINGLE POLE WALL SWITCH
			TANDEM SINGLE POLE SWITCHES TO SWITCH OUTER AND INNER LAMPS SEPARATELY
			TANDEM THREE POLE SWITCHES TO SWITCH OUTER AND INNER LAMPS SEPARATELY
			TANDEM SINGLE POLE SWITCHES LOWER CASE LETTERS INDICATE LUMINAIRES SWITCHED
			PUBLIC ADDRESS SPEAKER

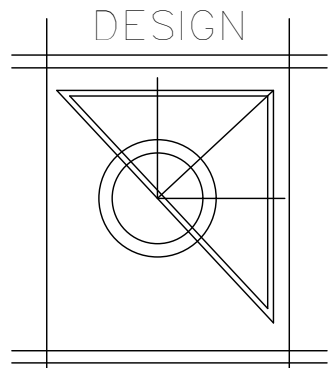


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ZOO HAY BARN ADDITION


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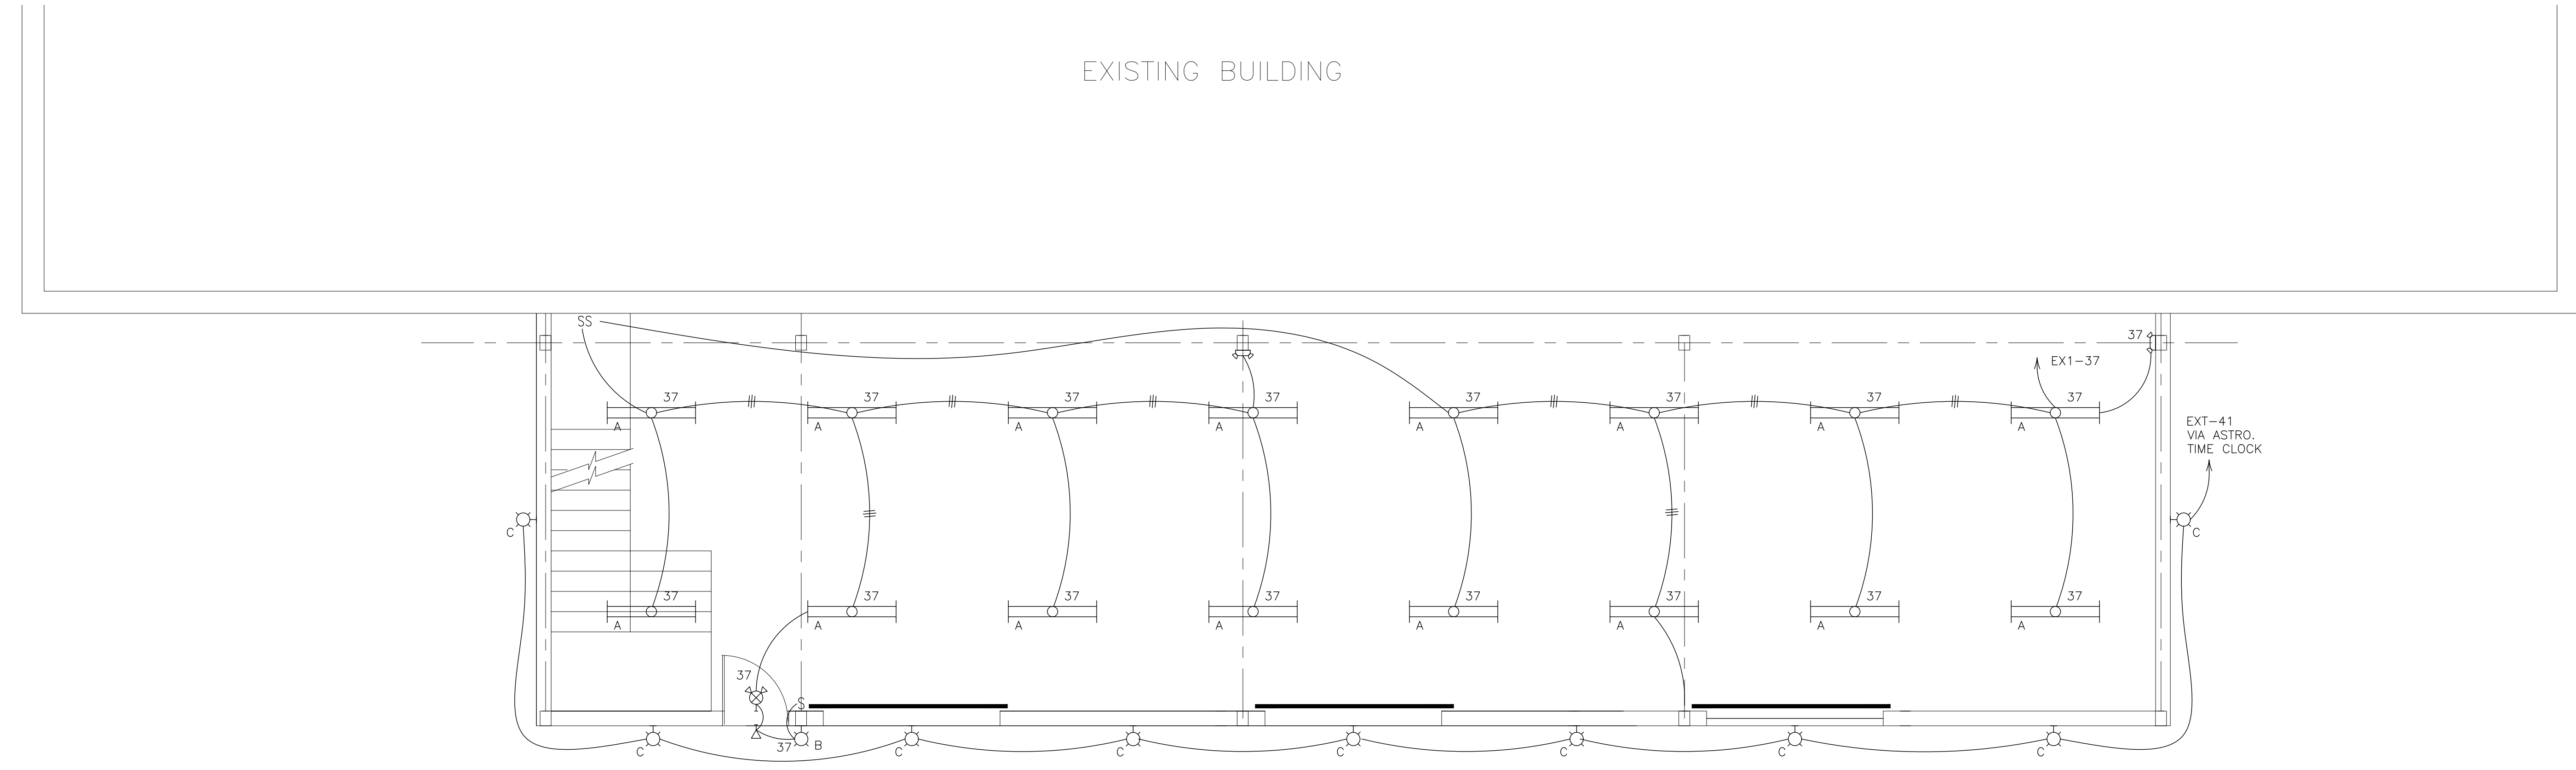
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DATE 3/2/2022

SHEET NO.	OF
E1	4

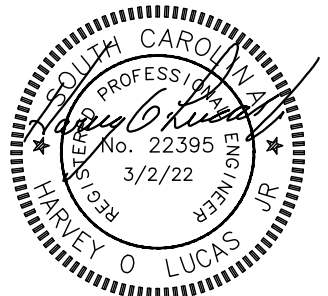





SECOND FLOOR LIGHTING PLAN  
1/4"=1'-0"

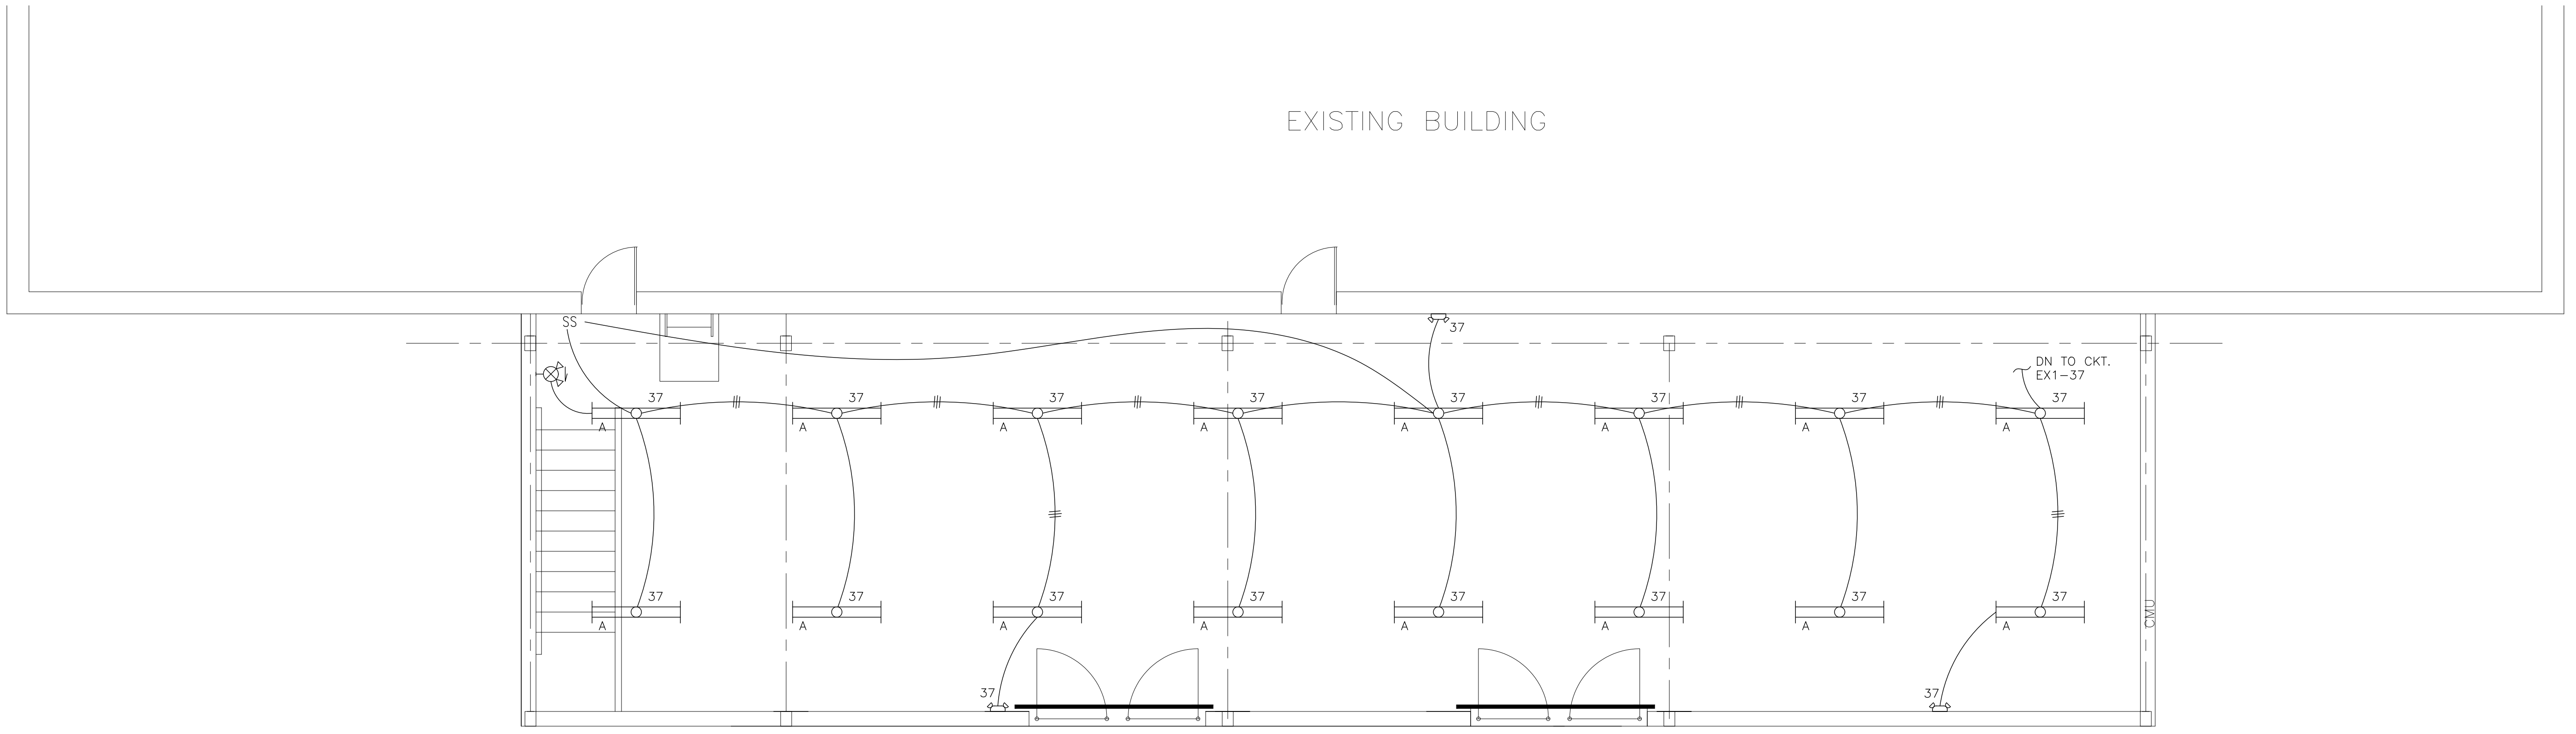

FIRST FLOOR LIGHTING PLAN  
1/4"=1'-0"

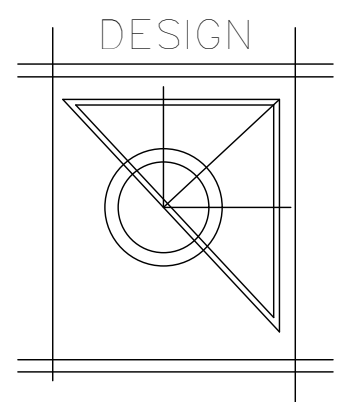

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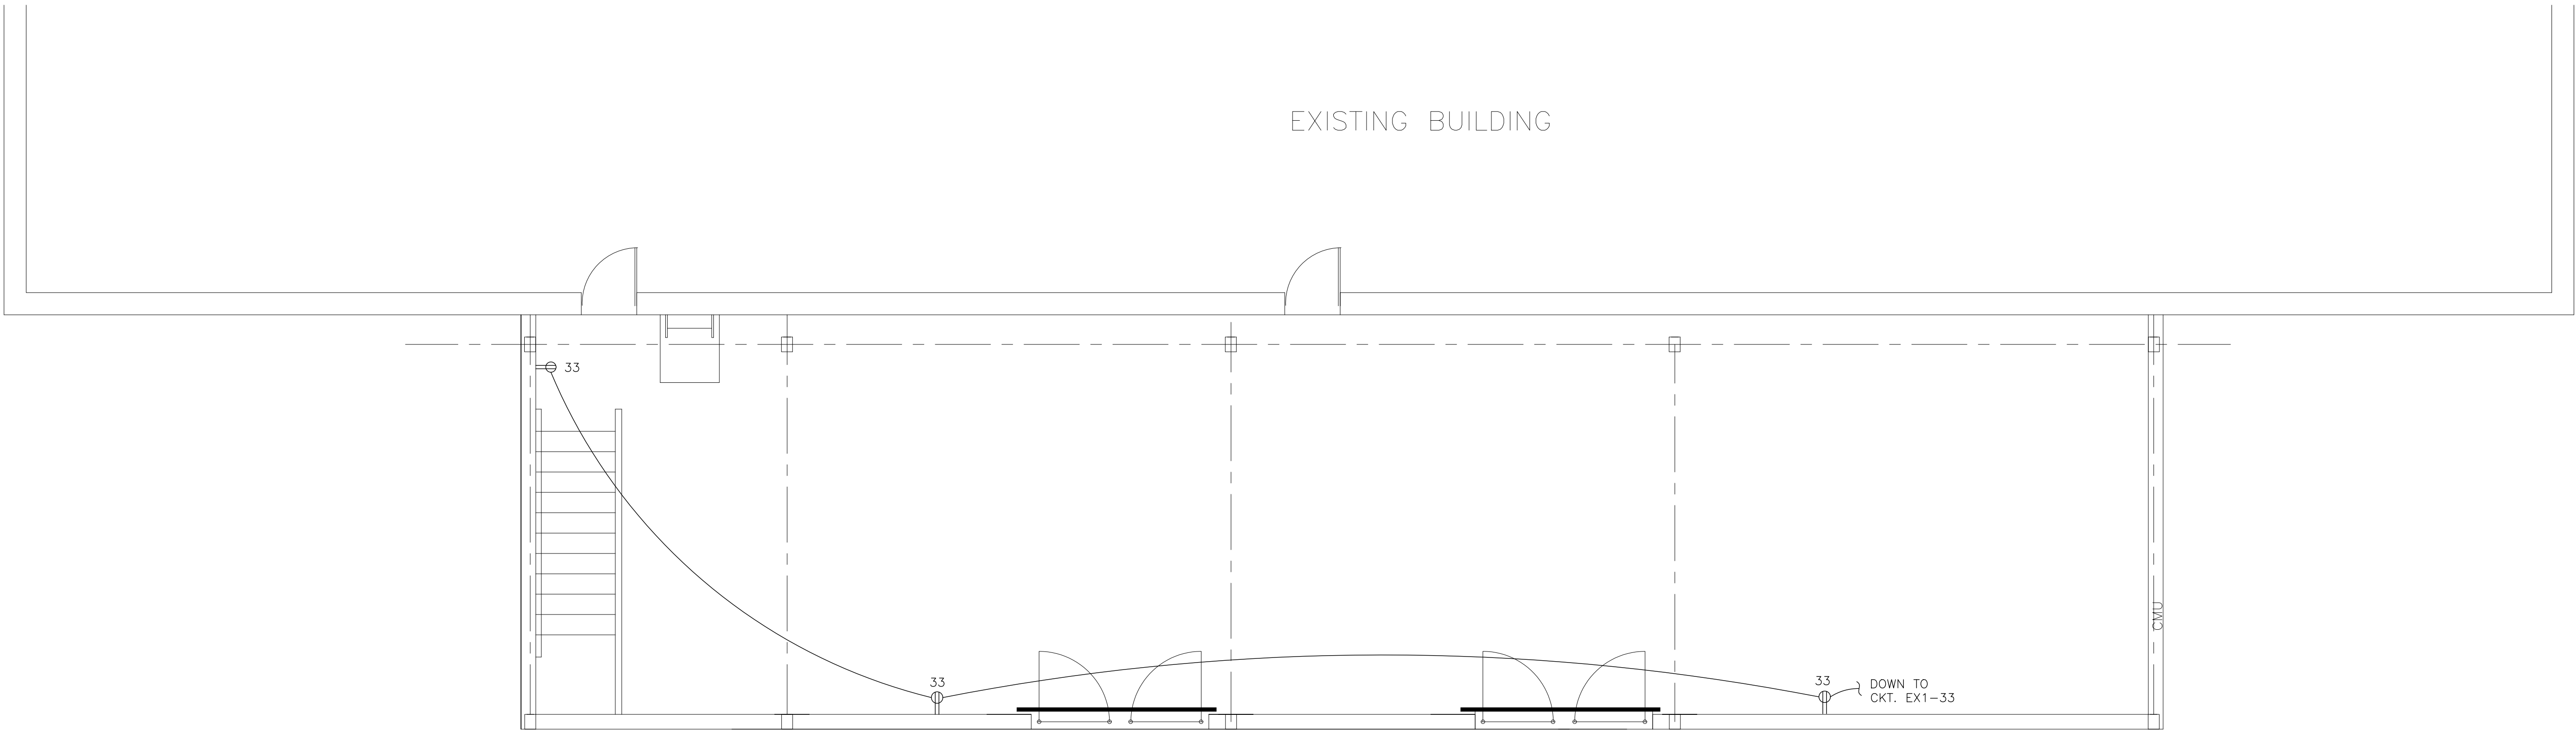
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ZOO HAY BARN ADDITION  
SHEET TITLE:  
LIGHTING PLANS

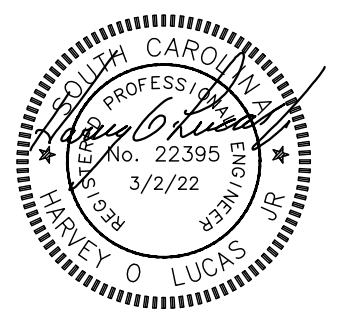
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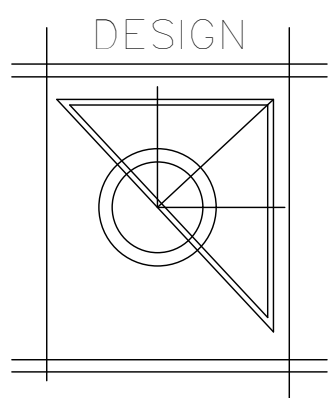


SECOND FLOOR POWER PLAN  
1/4"=1'-0"




FIRST FLOOR POWER PLAN  
1/4"=1'-0"

NOTE:  
CONNECT TO HEAT TRACING.  
SEE PANEL SCHEDULE.

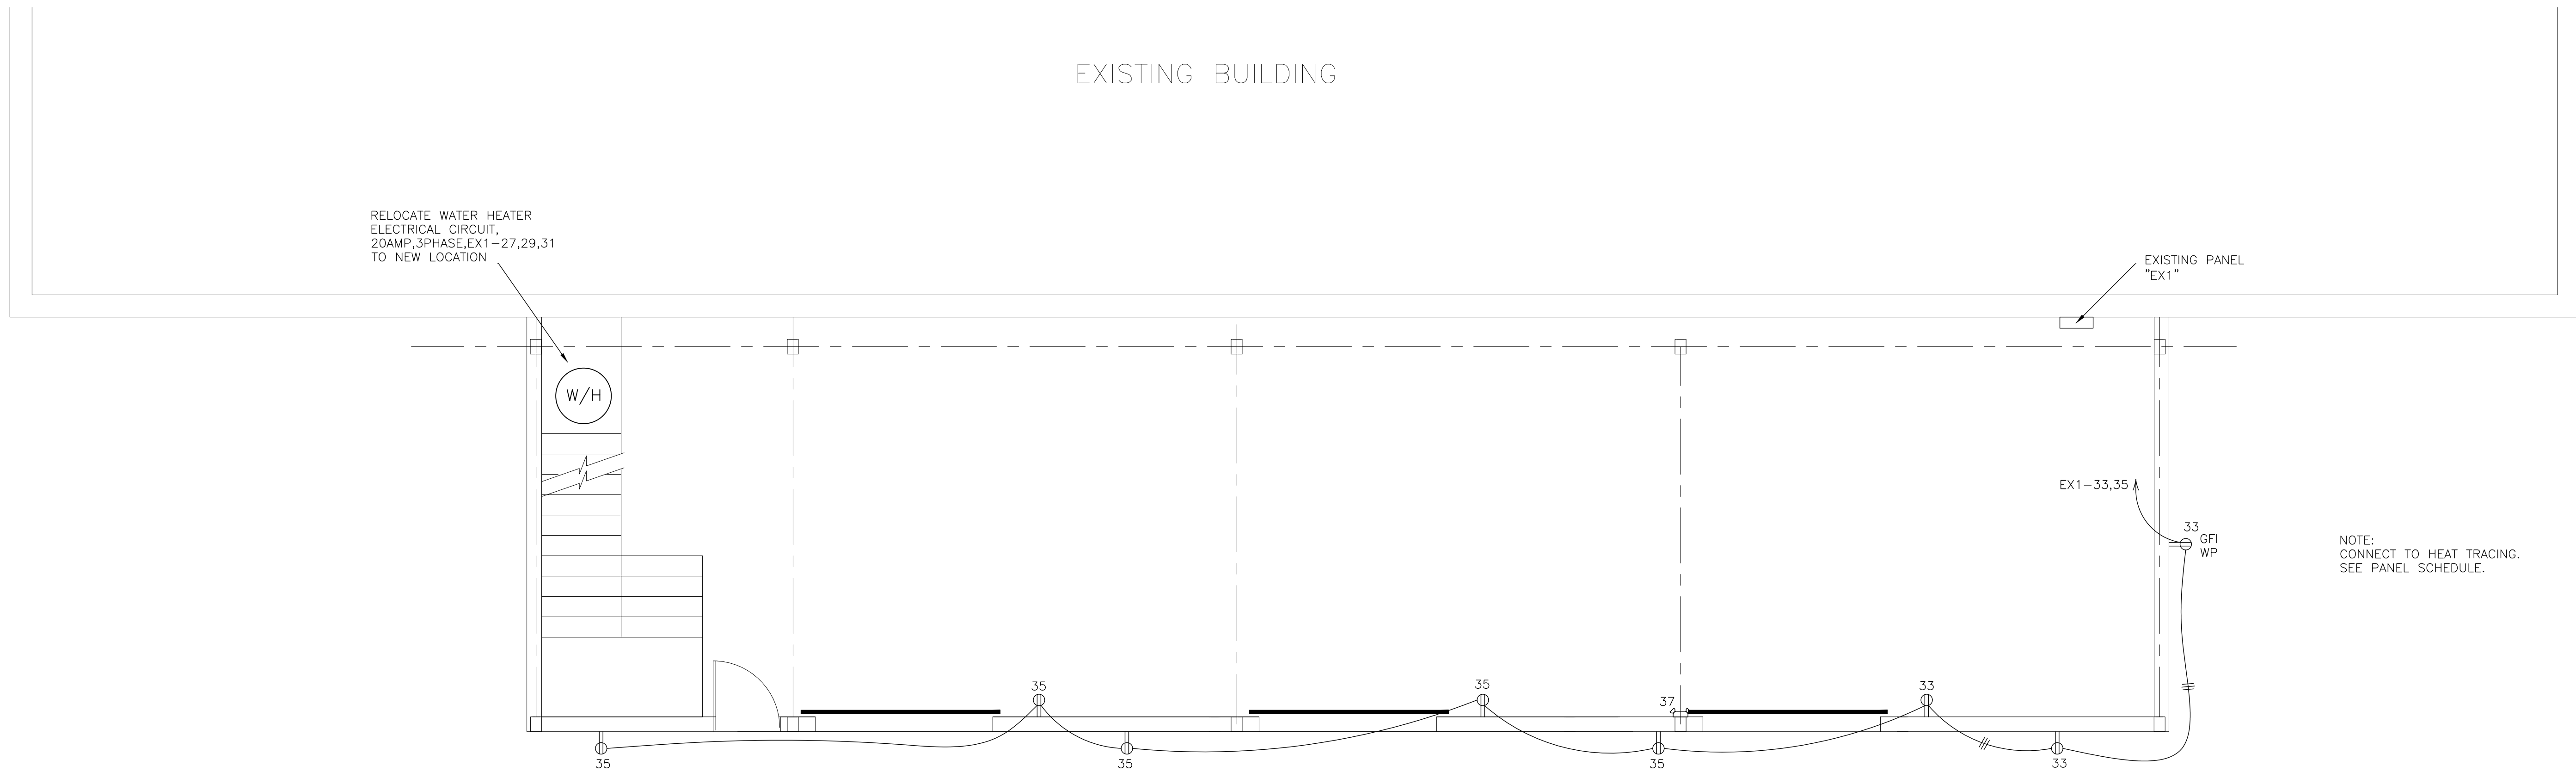

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ZOO HAY BARN ADDITION

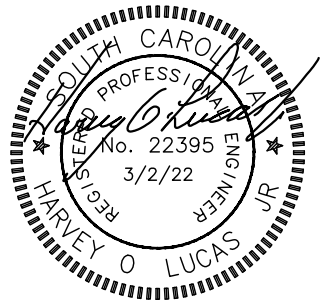SHEET TITLE:  
POWER PLANS

DRAWN BY .HOL  
DATE 3/2/2022

SHEET NO. OF  
E3 4

